

TAX LOT:

6-1-1
1880,347 SQ. FT.
430.21 ACRES

OWNER:

ARTHUR L. & CAROL ANN MOORE
P.O. BOX 655
NEW HAMPTON, NEW YORK 10958

APPLICANT:

RDM GROUP
1 INTERNATIONAL BOULEVARD, SUITE 410
MAHWAH, NEW JERSEY 07430

EXISTING A.C.O.E. WETLANDS:

±193,538 SF / 4.44 ACRES
PROPOSED A.C.O.E. WETLAND DISTURBANCE = 1,649 SF / 0.038 ACRES

EXISTING ISOLATED WETLANDS:

±10,398 SF / 0.24 ACRES
PROPOSED ISOLATED WETLAND DISTURBANCE = 2,827 SF / 0.065 ACRES

BULK TABLE

ZONING DISTRICT: MC-1 (MIXED COMMERCIAL)
SPECIAL USE SUBJECT TO SITE PLAN APPROVAL: WAREHOUSE

| MINIMUM | REQUIRED | PROPOSED | REMARKS |
|--------------------|----------|-------------|---------|
| LOT AREA | 2 ACRES | 19.73 ACRES | OK |
| FRONT YARD SETBACK | 50 FEET | 225.35 FEET | OK |
| REAR YARD SETBACK | 30 FEET | 86.18 FEET | OK |
| SIDE YARD SETBACK | | | |
| ONE | 15 FEET | 69 FEET | OK |
| BOTH | 35 FEET | 172.04 FEET | OK |
| LOT WIDTH | 100 FEET | 285.94 FEET | OK |
| MAXIMUM | | | |
| BUILDING HEIGHT | 45 FEET | 55 FEET | OK |
| LOT COVERAGE | 70% | 49.8% | OK |
| BUILDING COVERAGE | 50% | 28.1% | OK |

PARKING REQUIREMENTS:

OFFICE USE:
1 PER 300 SF OF FLOOR AREA
7,500 SF = 25 SPACES REQUIRED


WAREHOUSE USE:
1 PER 5,000 SF OF FLOOR AREA (ESTIMATED NEED PER APPLICATION)
241,000 SF = 47 SPACES PROPOSED

TOTAL PARKING REQUIRED = 72 SPACES
TOTAL PARKING PROVIDED = 96 SPACES

NOTE:
1. ITE PARKING GENERATION MANUAL:
WAREHOUSING USE - AVERAGE RATE OF 0.39 SPACES PER 1,000 S.F. GROSS FLOOR AREA
241,000 GROSS SQ. FT. / 1,000 X 0.39 = 94 SPACES

PROPOSED WAREHOUSE:
REQUIRED INTERIOR ISLAND SPACE (10 SQ.FT. PARKING SPACE) = 940 SQ.FT.
PROVIDED INTERIOR ISLAND SPACE = 35,387 SQ.FT.

PROPOSED WAREHOUSE
241,000 SF TOTAL
96 PARKING SPACES
38 DOCKS
14 TRAILER STORAGE SPACES

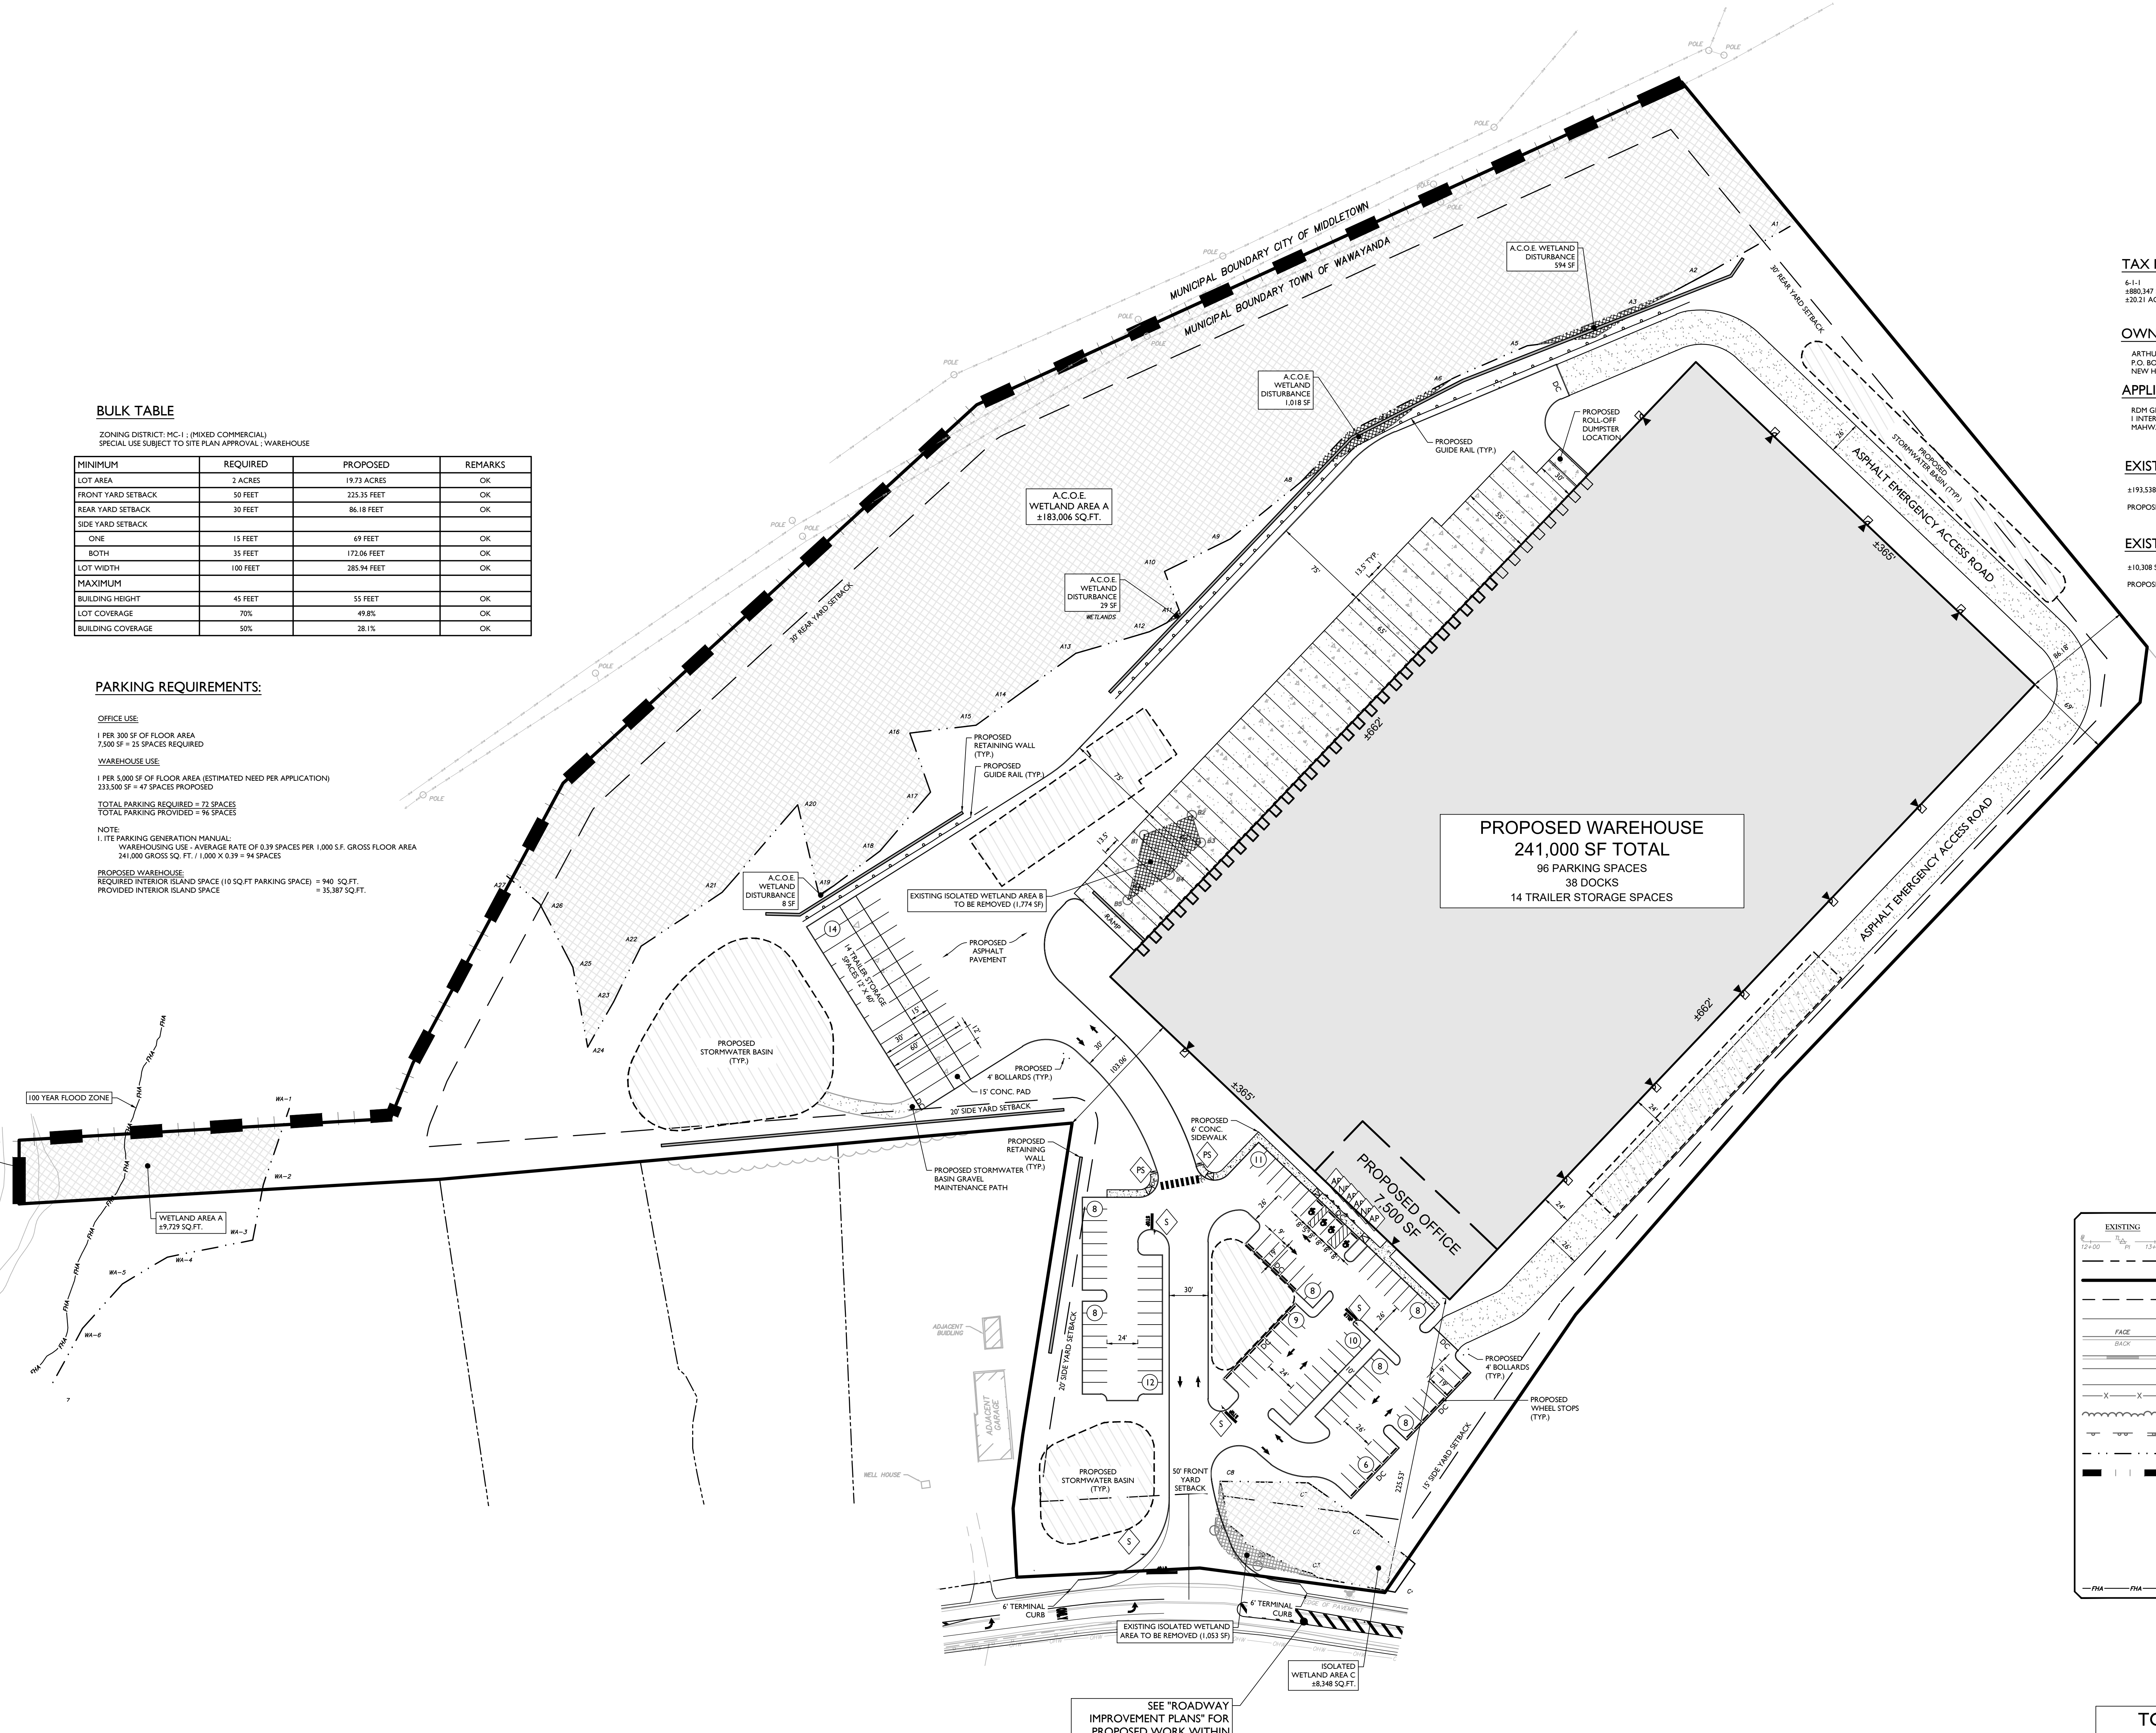

| EXISTING | LEGEND | PROPOSED |
|----------|--|----------|
| 12+00 | TRaverse LINE, CENTER LINE OR BASELINE (LABEL AS SUCH) | 12+00 |
| --- | RIGHT OF WAY LINE | --- |
| --- | PROPERTY LINE | --- |
| --- | EASEMENT LINE | --- |
| --- | EDGE OF PAVEMENT | --- |
| --- | CURB | --- |
| --- | DEPRESSED CURB | --- |
| --- | SIDEWALK | --- |
| --- | FENCES | --- |
| --- | TREELINE | --- |
| --- | ROADWAY SIGNS | --- |
| --- | WETLAND LINE | --- |
| --- | MUNICIPAL BOUNDARY LINE | --- |
| --- | STALL COUNT | --- |
| --- | ADA ACCESSIBLE STALL | --- |
| --- | DEPRESSED CURB AND ADA RAMP | --- |
| --- | DEPRESSED CURB | --- |
| --- | DIRECTION OF TRAFFIC FLOW | --- |
| --- | 100 YEAR FLOOD | --- |



Justin Eric Dates
NEW YORK REGISTERED LANDSCAPE ARCHITECT
LICENSE NUMBER: 001964-01
COLLIERS ENGINEERING & DESIGN CT, P.C.

SITE PLAN
FOR
RDM GROUP 1081
DOLSONTOWN ROAD

TAX LOTS:
6-1-1
TOWN OF WAWAYANDA
ORANGE COUNTY
NEW YORK STATE


NEWBURGH
555 Hudson Valley Avenue
Suite 101
New Windsor, NY 12553
Phone: 845.564.4495
COLLIERS ENGINEERING & DESIGN CT, P.C.
DOING BUSINESS AS MASER CONSULTING
ENGINEERING & LAND SURVEYING

SCALE: AS SHOWN
DATE: 06/24/2020
PROJECT NUMBER: 20000069A
DRAWING NAME: C-LAY
DRAWN BY: CPM
CHECKED BY: JED


SHEET TITLE:
OVERALL SITE PLAN

SHEET NUMBER:
03 of 17

REFERENCE NOTE:
1. EXISTING SITE INFORMATION TAKEN FROM MAP REFERENCE "OUTBOUND & TOPOGRAPHIC SURVEY PLAN PREPARED FOR 1081 DOLSONTOWN ROAD - SECTION 6 - BLOCK 1 - LOT 1" PREPARED BY JOHN W. MCCORD, SR. DATED 01/29/2020, LAST REVISED 03/04/2020.

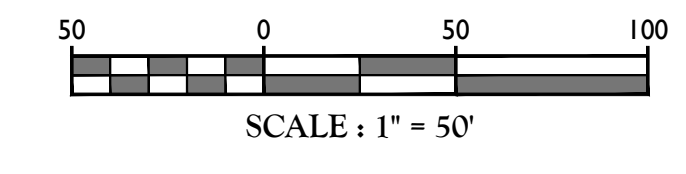


TOWN OF WAWAYANDA
PLANNING BOARD

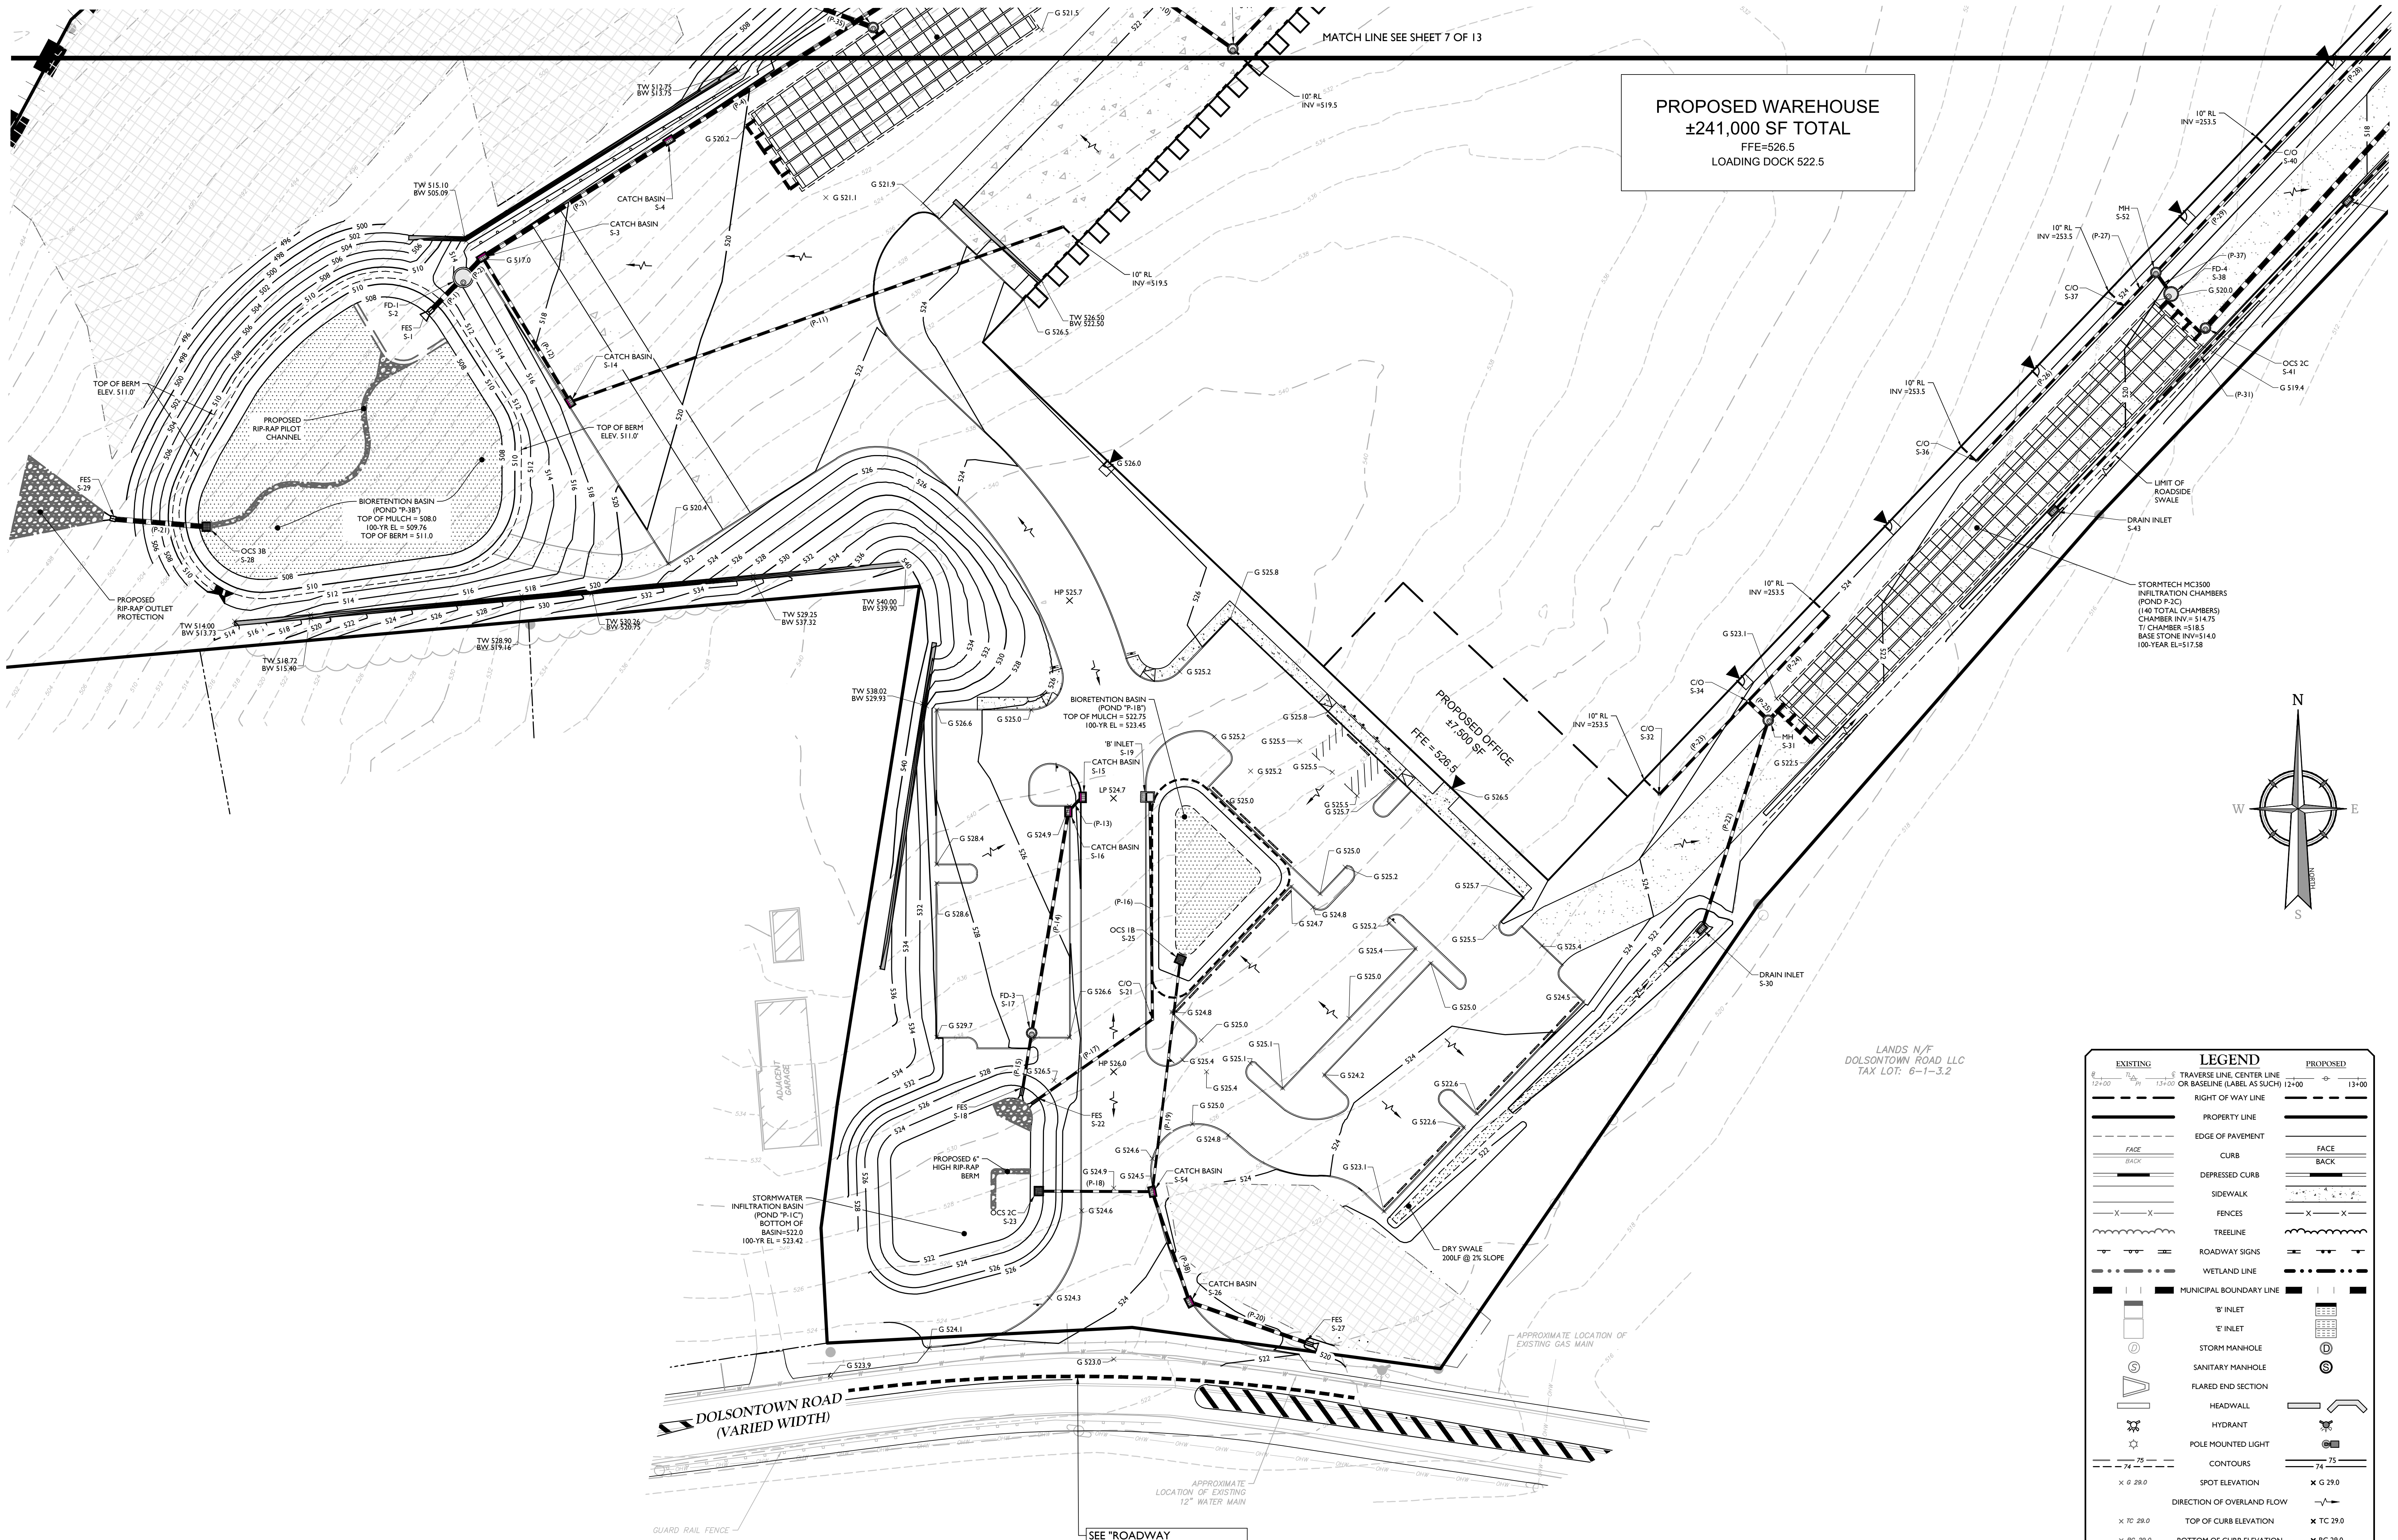


PROPOSED WAREHOUSE
±241,000 SF TOTAL
FFE=526.5
LOADING DOCK 522.5

MATCH LINE SEE SHEET 7 OF 13

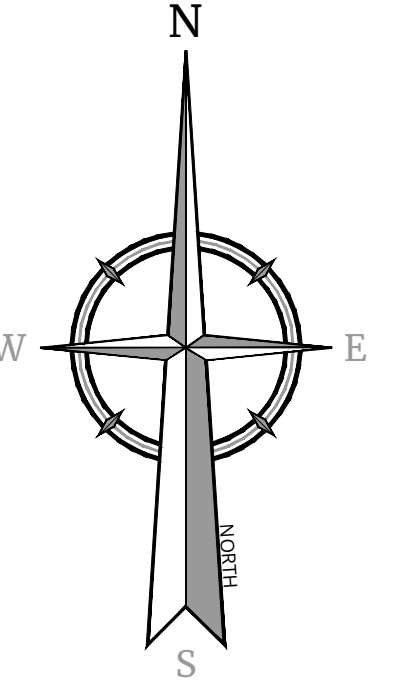

LANDS N/F
DOLSONTOWN ROAD LLC
TAX LOT: 6-1-3.2

| EXISTING | | LEGEND | | PROPOSED | |
|----------|---------------------------------|--------|---------------------------------|----------|---------------------------------|
| | TRAVERSE LINE, CENTER LINE | | TRAVERSE LINE, CENTER LINE | | TRAVERSE LINE, CENTER LINE |
| | RIGHT OF WAY LINE | | RIGHT OF WAY LINE | | RIGHT OF WAY LINE |
| | PROPERTY LINE | | PROPERTY LINE | | PROPERTY LINE |
| | EDGE OF PAVEMENT | | EDGE OF PAVEMENT | | EDGE OF PAVEMENT |
| | CURBS | | CURBS | | CURBS |
| | DEPRESSED CURB | | DEPRESSED CURB | | DEPRESSED CURB |
| | SIDEWALK | | SIDEWALK | | SIDEWALK |
| | FENCES | | FENCES | | FENCES |
| | TREELINE | | TREELINE | | TREELINE |
| | ROADWAY SIGNS | | ROADWAY SIGNS | | ROADWAY SIGNS |
| | WETLAND LINE | | WETLAND LINE | | WETLAND LINE |
| | MUNICIPAL BOUNDARY LINE | | MUNICIPAL BOUNDARY LINE | | MUNICIPAL BOUNDARY LINE |
| | B' INLET | | B' INLET | | B' INLET |
| | E' INLET | | E' INLET | | E' INLET |
| | STORM MANHOLE | | STORM MANHOLE | | STORM MANHOLE |
| | SANITARY MANHOLE | | SANITARY MANHOLE | | SANITARY MANHOLE |
| | FLARED END SECTION | | FLARED END SECTION | | FLARED END SECTION |
| | HEADWALL | | HEADWALL | | HEADWALL |
| | HYDRANT | | HYDRANT | | HYDRANT |
| | POLE MOUNTED LIGHT | | POLE MOUNTED LIGHT | | POLE MOUNTED LIGHT |
| | CONTOURS | | CONTOURS | | CONTOURS |
| | SPOT ELEVATION | | SPOT ELEVATION | | SPOT ELEVATION |
| | DIRECTION OF OVERLAND FLOW | | DIRECTION OF OVERLAND FLOW | | DIRECTION OF OVERLAND FLOW |
| | TOP OF CURB ELEVATION | | TOP OF CURB ELEVATION | | TOP OF CURB ELEVATION |
| | BOTTOM OF CURB ELEVATION | | BOTTOM OF CURB ELEVATION | | BOTTOM OF CURB ELEVATION |
| | TOP OF DEPRESSED CURB ELEVATION | | TOP OF DEPRESSED CURB ELEVATION | | TOP OF DEPRESSED CURB ELEVATION |

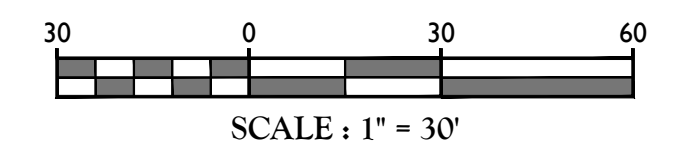

SCALE: 1" = 30'

SEE "ROADWAY IMPROVEMENT PLANS" FOR PROPOSED WORK WITHIN DOLSONTOWN ROAD R.O.W.

TOWN OF WAWAYANDA
PLANNING BOARD

| REV | DATE | DESCRIPTION |
|-----|----------|---|
| 1 | 04/20/24 | ISSUE FOR PERMITTING |
| 2 | 05/01/24 | REVISED FOR SITE ENTRANCE AND DRIVEWAY IMPROVEMENT PLANS |
| 3 | 05/22/24 | REVISED FOR LOCAL COMPLIANCE |
| 4 | 05/22/24 | REVISED FOR LOCAL COMPLIANCE |
| 5 | 07/02/24 | SET UP/UPDATED PER PROPERTY BOUNDARY UPDATE & CONDO/ WEDDLE/TOWN ROAD PLANS |

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SITE PLAN
FOR
RDM GROUP 1081
DOLSONTOWN ROAD



TAX LOTS:
6-1-1
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Phone: 845.564.4495
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DOING BUSINESS AS MASER CONSULTING
ENGINEERING & DESIGN

AS SHOWN: 06/24/2020
DATE: 06/24/2020
PROJECT NUMBER: 200000096A
DRAWING NAME: C-GRAD

GRADING, DRAINAGE, AND UTILITY PLAN

06 of 17

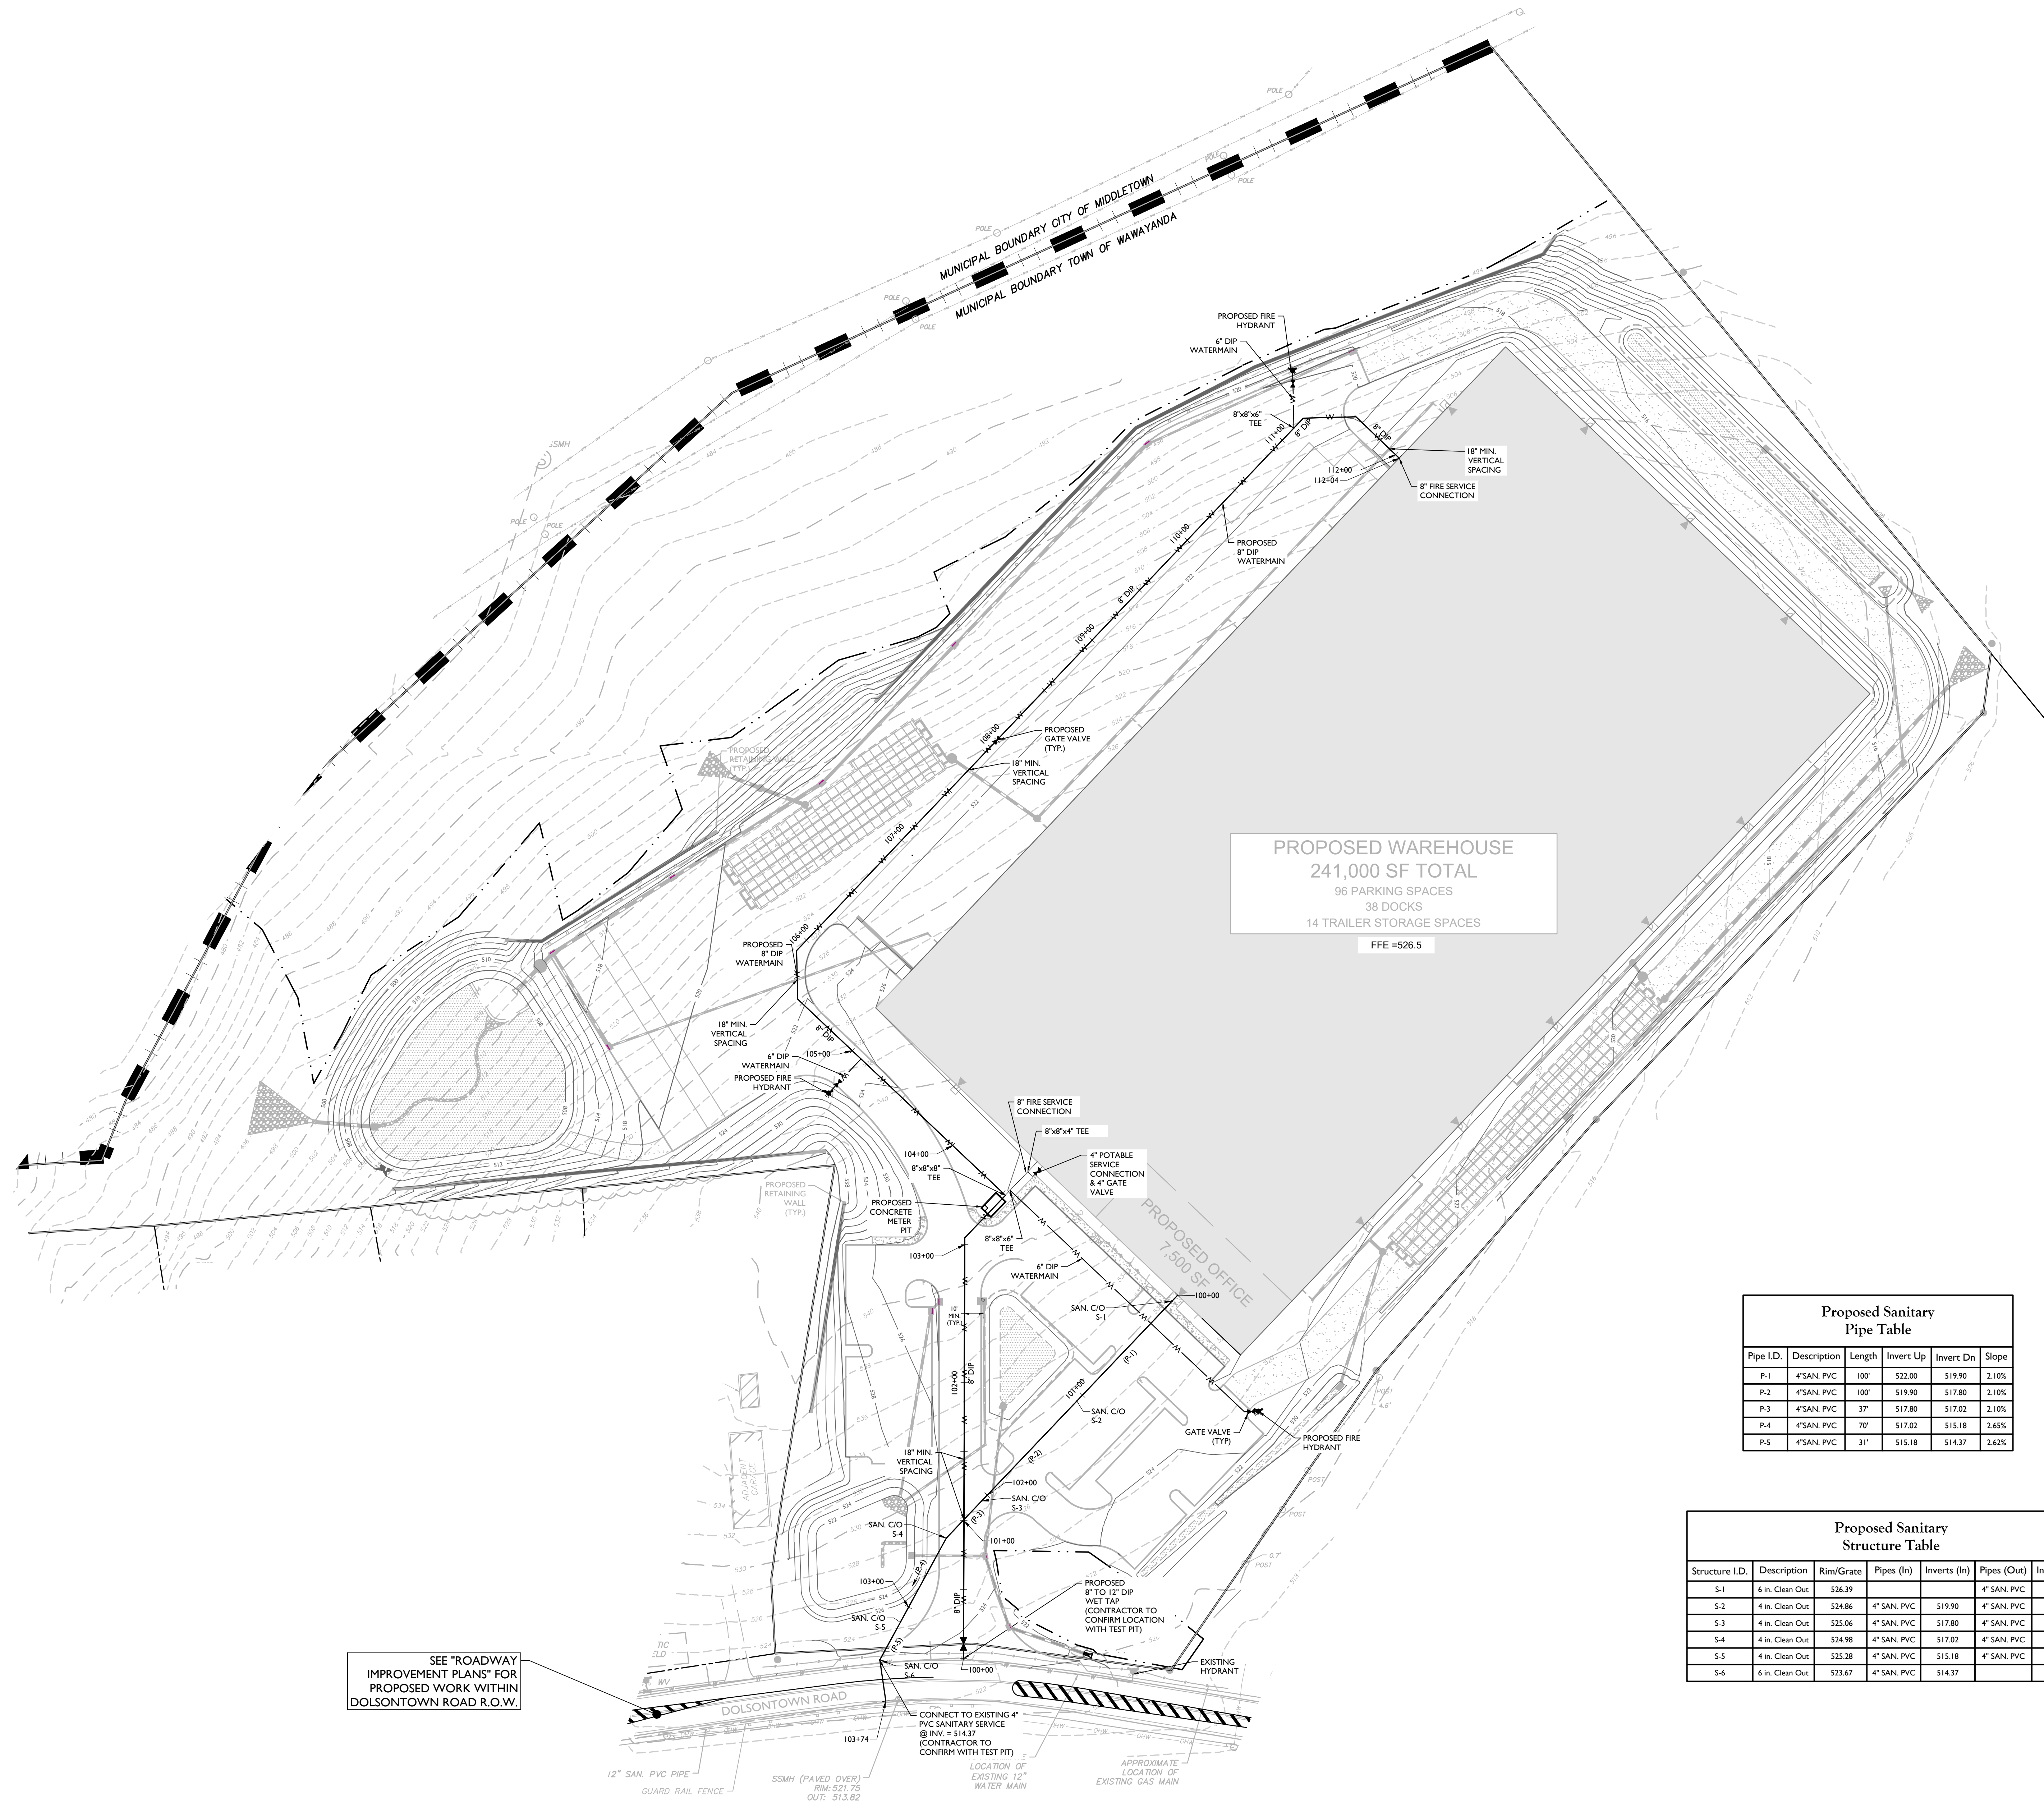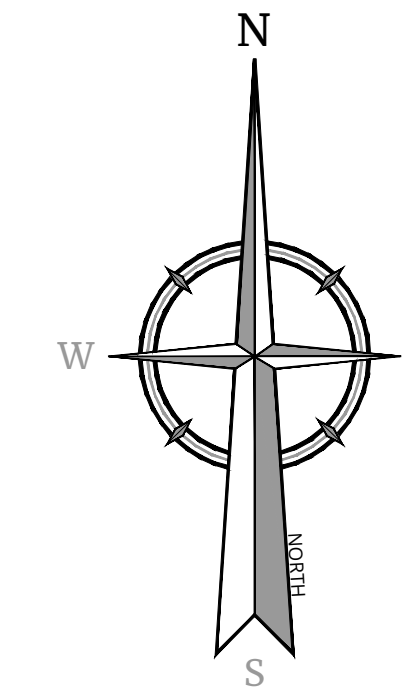

PROPOSED WAREHOUSE
241,000 SF TOTAL
96 PARKING SPACES
38 DOCKS
14 TRAILER STORAGE SPACES
FFE #526.5

OCHD NOTE:
THIS PROJECT HAS INDICATED THE INTENTION TO PROVIDE ADEQUATE FIRE FLOW BY THE PROPOSED INSTALLATION OF SPRINKLER SYSTEMS MEETING NFPA REQUIREMENTS, AND IS THEREFORE CONSIDERED EXEMPT FROM THE NEEDED FIRE FLOW GUIDELINES OF THE INSURANCE SERVICES OFFICE (ISO). THE PROPOSED SPRINKLER SYSTEM DESIGN HAS NOT BEEN EVALUATED BY THE ORANGE COUNTY DEPARTMENT OF HEALTH FOR COMPLIANCE WITH NFPA REQUIREMENTS.

Proposed Sanitary Pipe Table


| Pipe I.D. | Description | Length | Invert Up | Invert Dn | Slope |
|-----------|-------------|--------|-----------|-----------|-------|
| P-1 | 4" SAN. PVC | 100' | \$22.00 | \$19.90 | 2.10% |
| P-2 | 4" SAN. PVC | 100' | \$19.90 | \$17.80 | 2.10% |
| P-3 | 4" SAN. PVC | 37' | \$17.80 | \$17.02 | 2.10% |
| P-4 | 4" SAN. PVC | 70' | \$17.02 | \$15.18 | 2.65% |
| P-5 | 4" SAN. PVC | 31' | \$15.18 | \$14.37 | 2.62% |

Proposed Sanitary Structure Table

| Structure I.D. | Description | Rim/Grate | Pipes (In) | Inverts (In) | Pipes (Out) | Inverts (Out) |
|----------------|-----------------|-----------|-------------|--------------|-------------|---------------|
| S-1 | 6 in. Clean Out | \$26.39 | | | 4" SAN. PVC | \$22.00 |
| S-2 | 4 in. Clean Out | \$24.86 | 4" SAN. PVC | \$19.90 | 4" SAN. PVC | \$19.90 |
| S-3 | 4 in. Clean Out | \$25.06 | 4" SAN. PVC | \$17.80 | 4" SAN. PVC | \$17.80 |
| S-4 | 4 in. Clean Out | \$24.98 | 4" SAN. PVC | \$17.02 | 4" SAN. PVC | \$17.02 |
| S-5 | 4 in. Clean Out | \$25.28 | 4" SAN. PVC | \$15.18 | 4" SAN. PVC | \$15.18 |
| S-6 | 6 in. Clean Out | \$23.67 | 4" SAN. PVC | \$14.37 | | |

LEGEND

| EXISTING | PROPOSED |
|---|---|
| TRaverse LINE CENTER LINE OR BASELINE (LABEL AS SUCH) 12+00 | TRaverse LINE CENTER LINE OR BASELINE (LABEL AS SUCH) 12+00 |
| RIGHT OF WAY LINE | RIGHT OF WAY LINE |
| PROPERTY LINE | PROPERTY LINE |
| EDGE OF PAVEMENT | EDGE OF PAVEMENT |
| CURB | CURB |
| DEPRESSED CURB | DEPRESSED CURB |
| SIDWALK | SIDWALK |
| FENCES | FENCES |
| TREELINE | TREELINE |
| ROADWAY SIGNS | ROADWAY SIGNS |
| WETLAND LINE | WETLAND LINE |
| MUNICIPAL BOUNDARY LINE | MUNICIPAL BOUNDARY LINE |
| 8" INLET | 8" INLET |
| 4" INLET | 4" INLET |
| STORM MANHOLE | STORM MANHOLE |
| SANITARY MANHOLE | SANITARY MANHOLE |
| FLARED END SECTION | FLARED END SECTION |
| HEADWALL | HEADWALL |
| HYDRANT | HYDRANT |
| POLE MOUNTED LIGHT | POLE MOUNTED LIGHT |
| CONTOURS | CONTOURS |
| SPOT ELEVATION | SPOT ELEVATION |
| DIRECTION OF OVERLAND FLOW | DIRECTION OF OVERLAND FLOW |
| TOP OF CURB ELEVATION | TOP OF CURB ELEVATION |
| BOTTOM OF CURB ELEVATION | BOTTOM OF CURB ELEVATION |
| TOP OF DEPRESSED CURB ELEVATION | TOP OF DEPRESSED CURB ELEVATION |
| CATV | CATV |
| WATER MAIN | WATER MAIN |
| GAS MAIN | GAS MAIN |
| TELEPHONE CONDUIT | TELEPHONE CONDUIT |
| ELECTRIC CONDUIT | ELECTRIC CONDUIT |
| SANITARY PIPE | SANITARY PIPE |
| STORM PIPE | STORM PIPE |

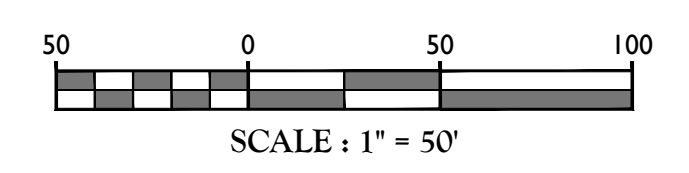

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SITE PLAN
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TAX LOTS:
6-1-1
TOWN OF WAWAYANDA
ORANGE COUNTY
NEW YORK STATE






























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SCALE: AS SHOWN
DATE: 06/24/2020
PROJECT NUMBER: 20000096A
DRAWING NAME: C-UTL
DRAWN BY: CPM
CHECKED BY: JED

SHEET TITLE:
UTILITIES PLAN

SHEET NUMBER:
08 of 17

TOWN OF WAWAYANDA
PLANNING BOARD

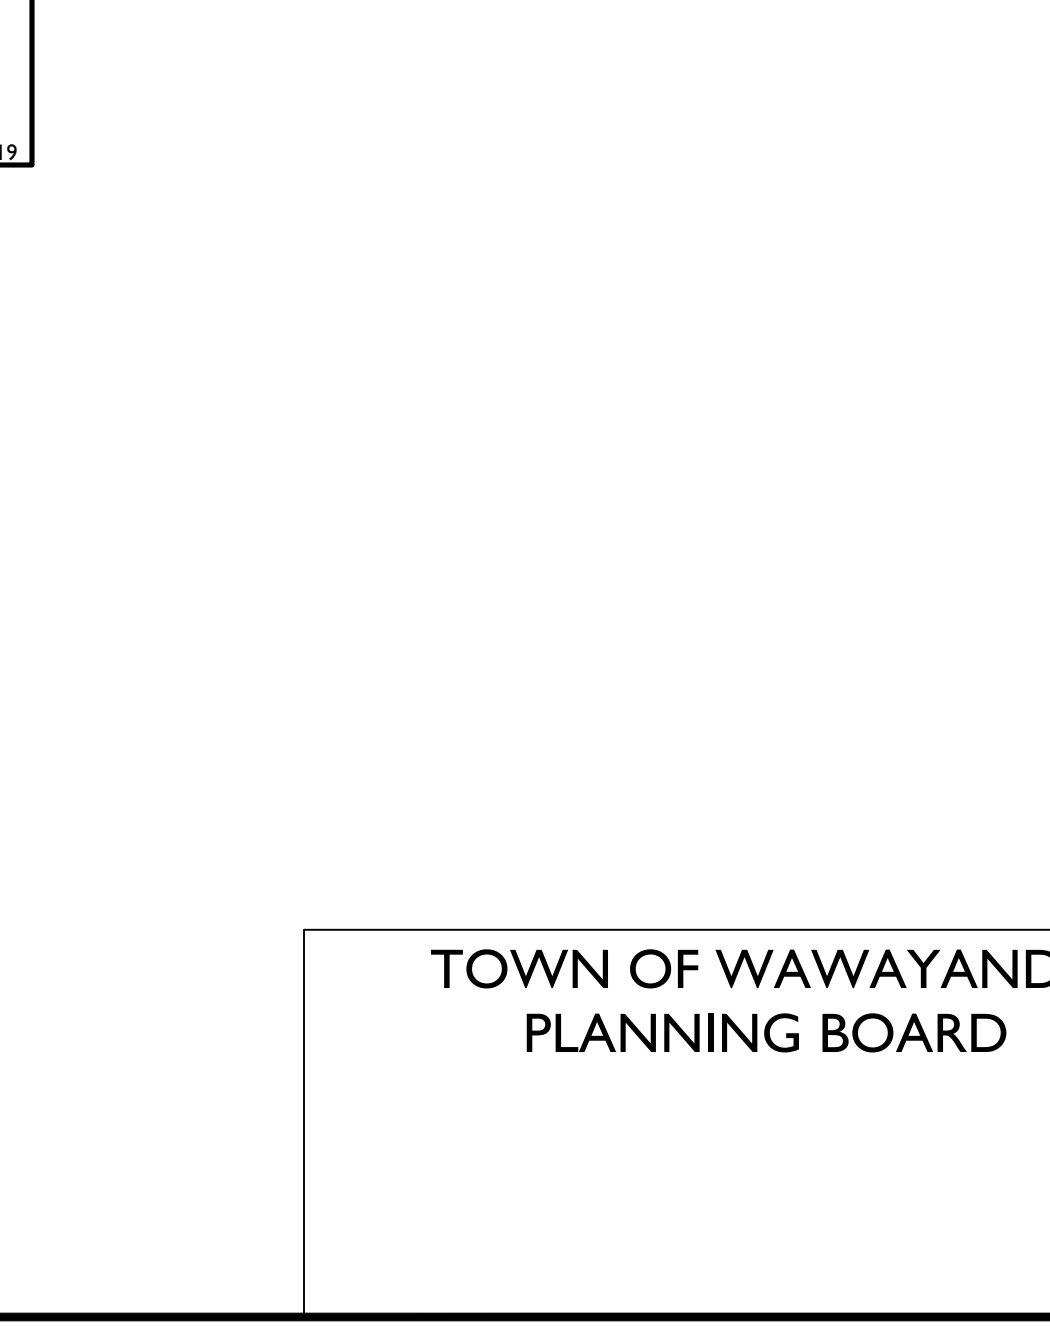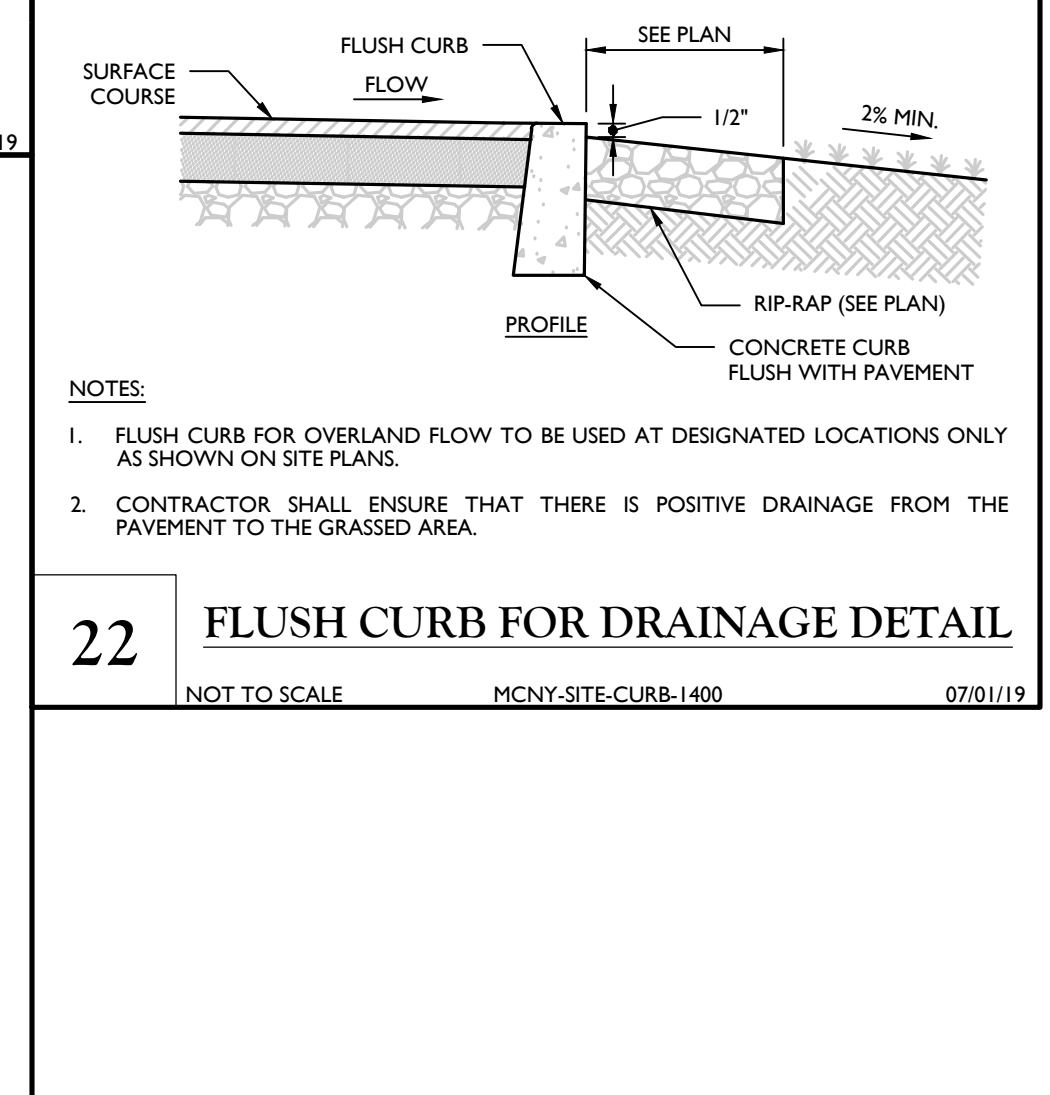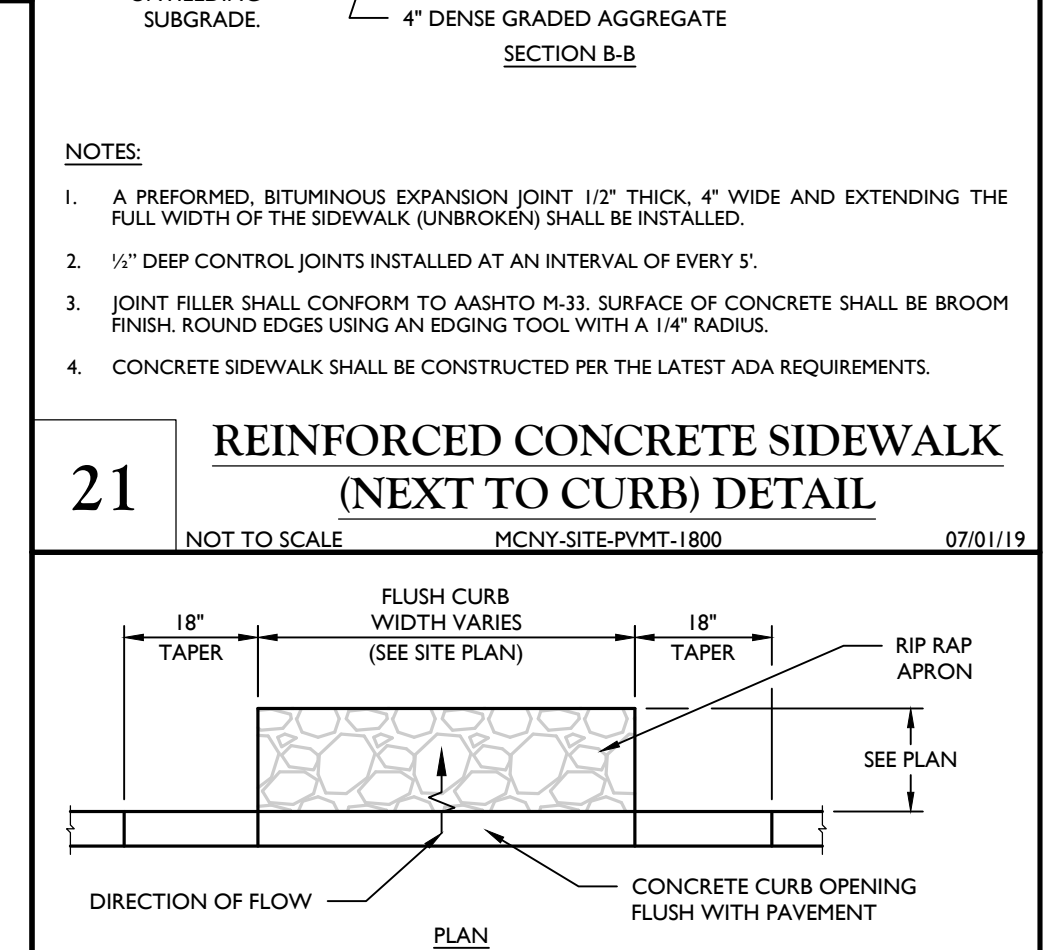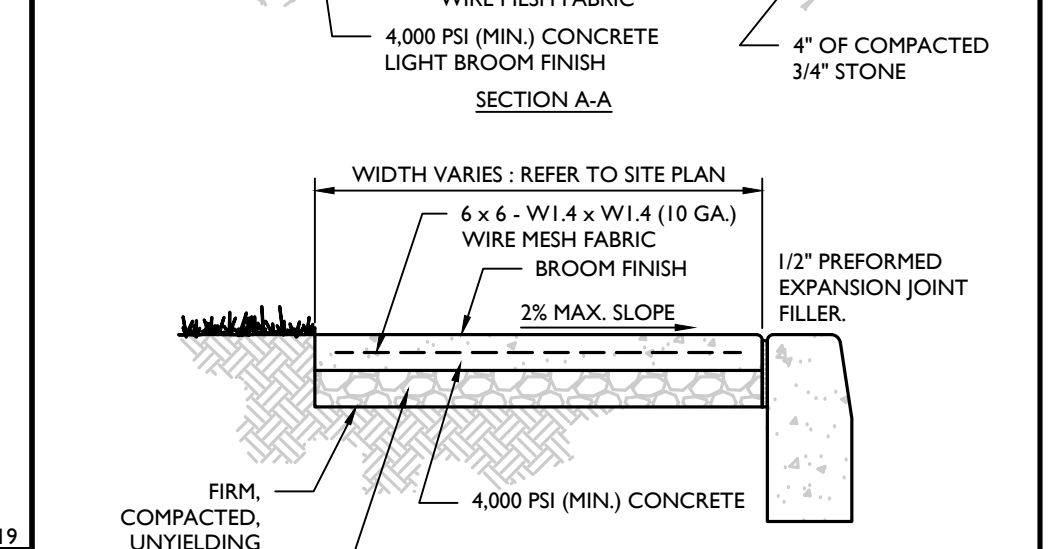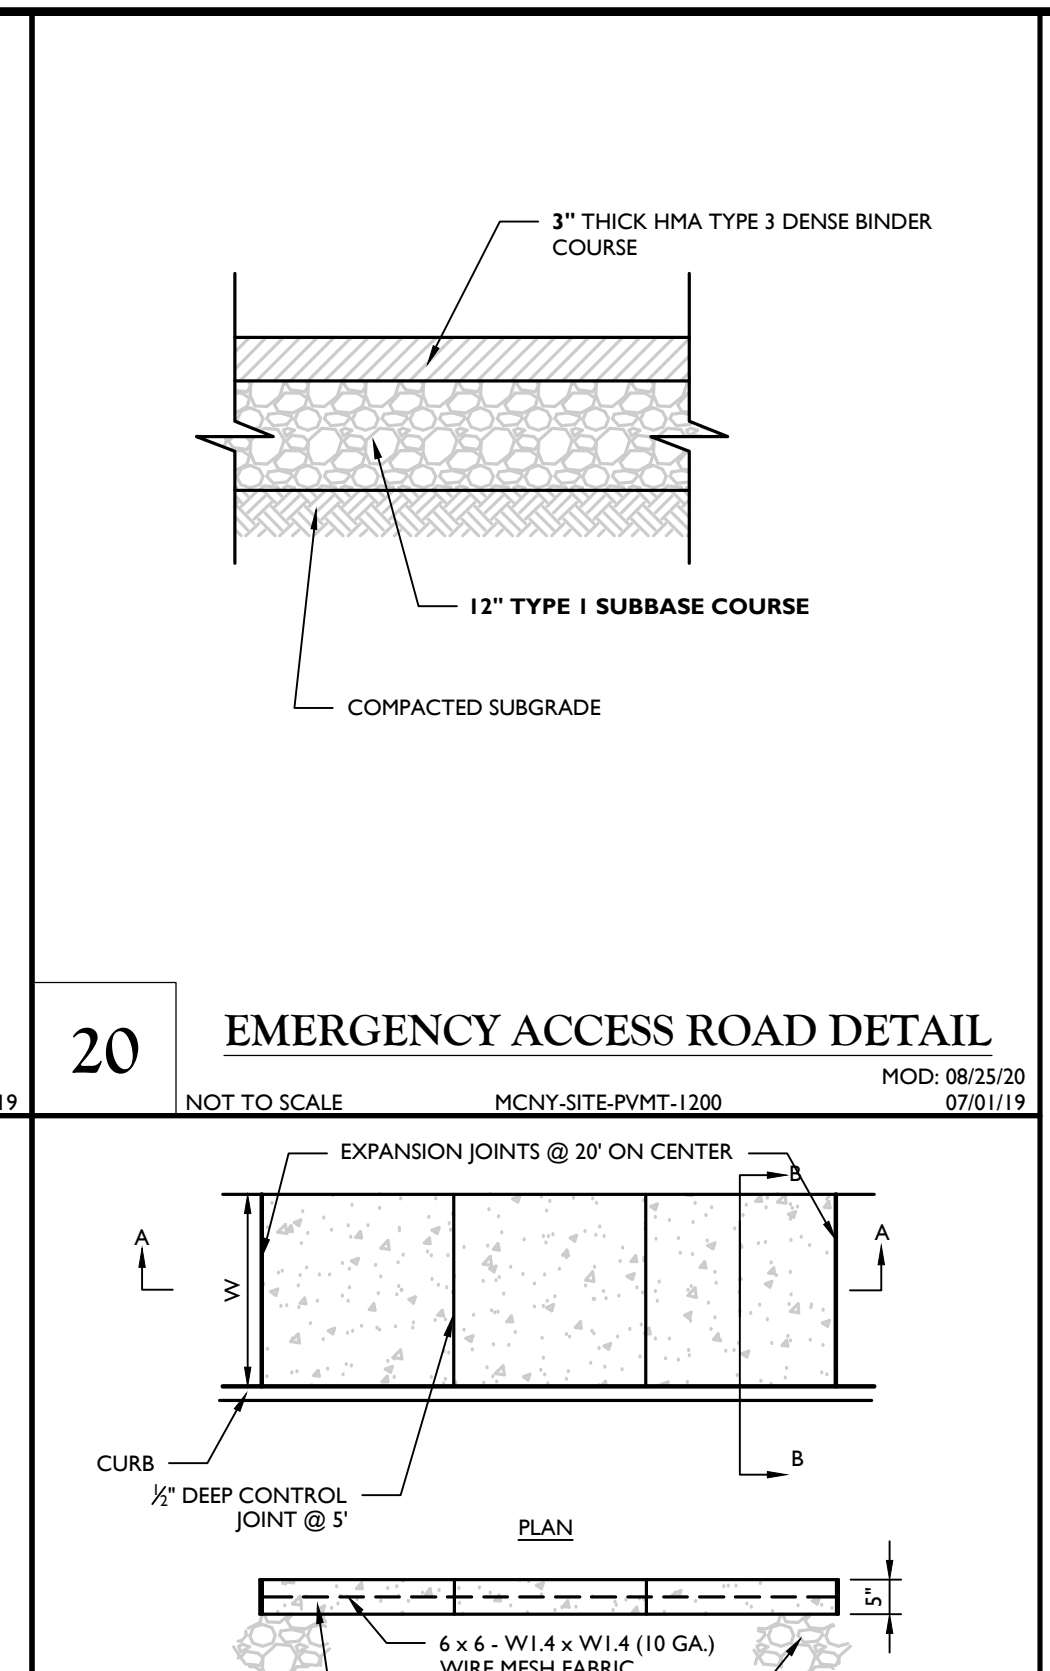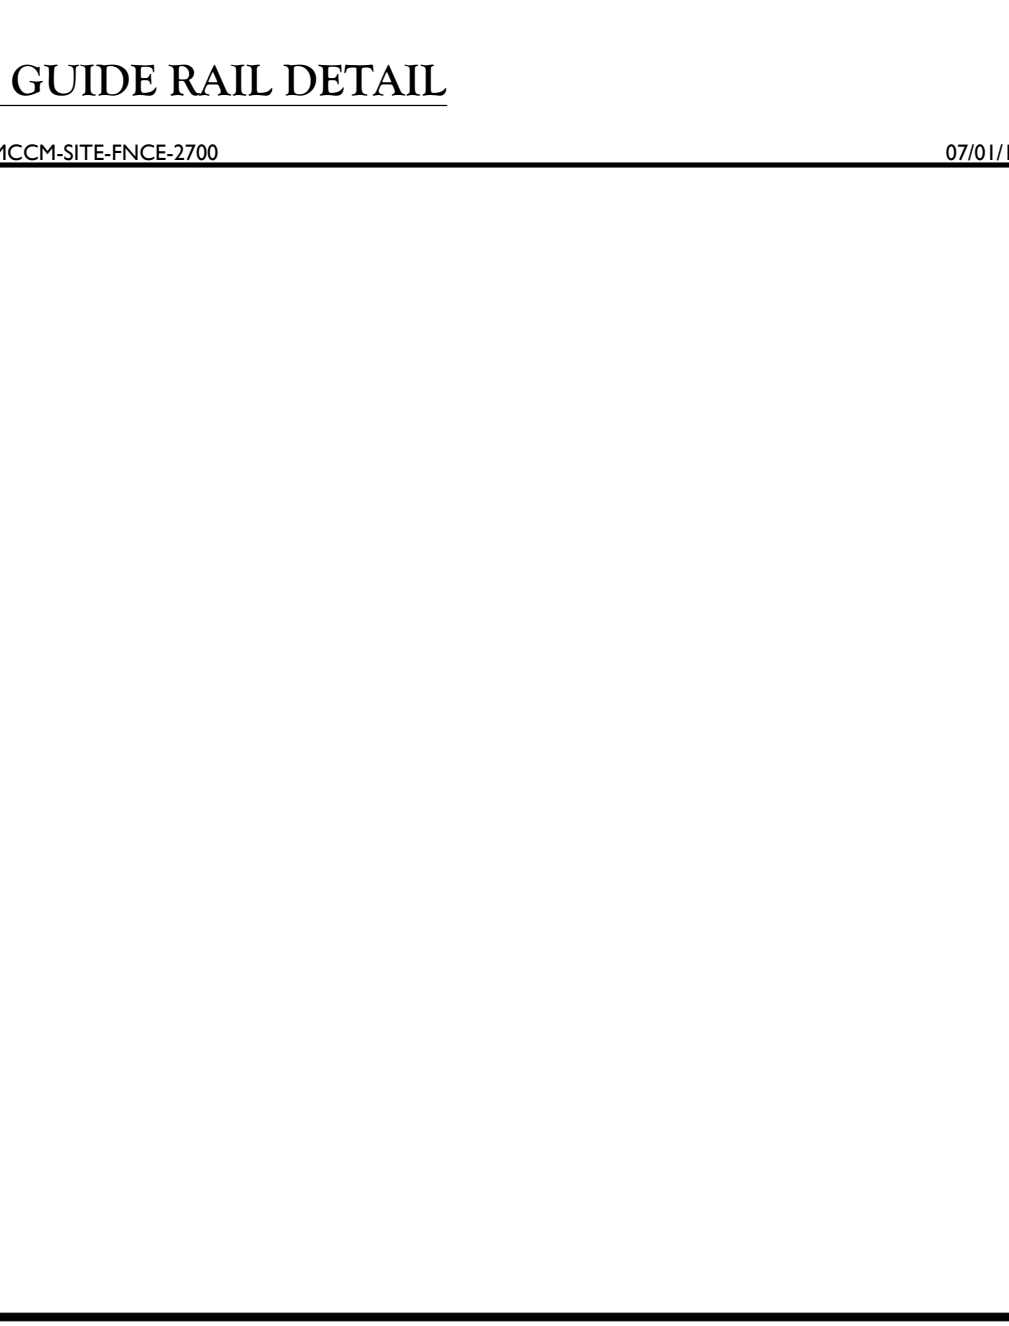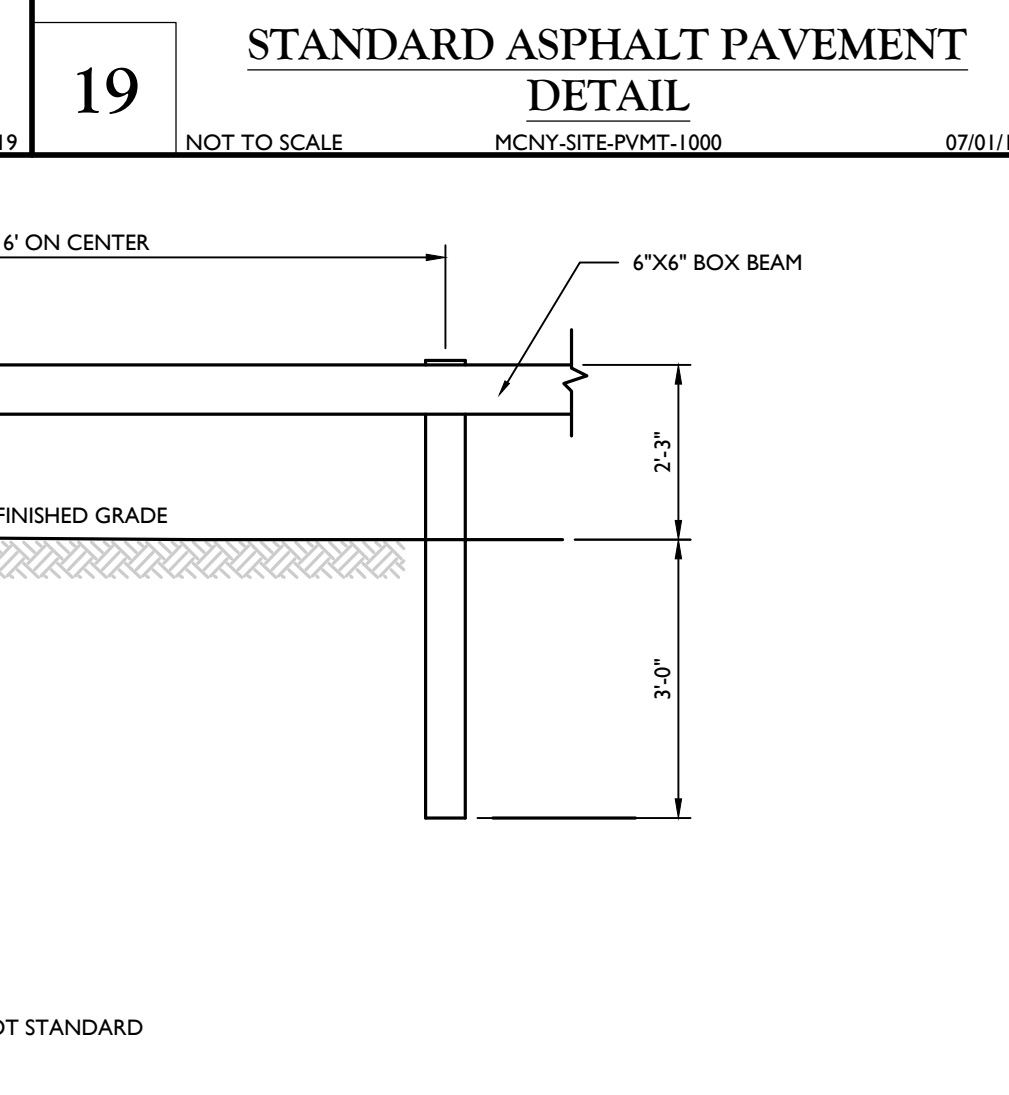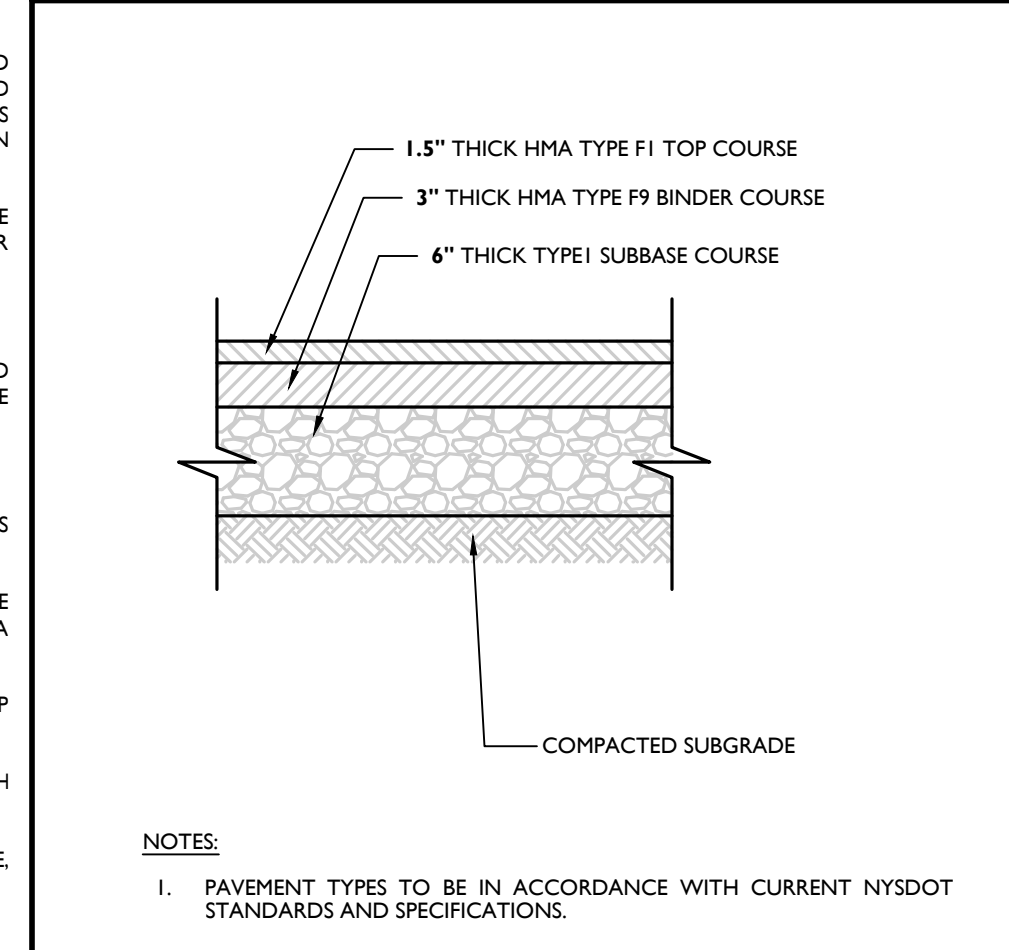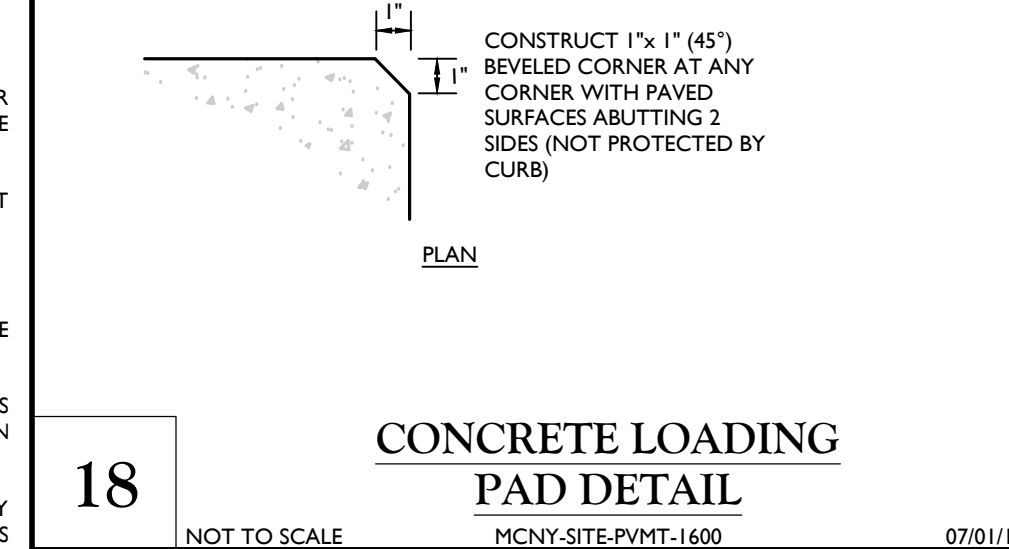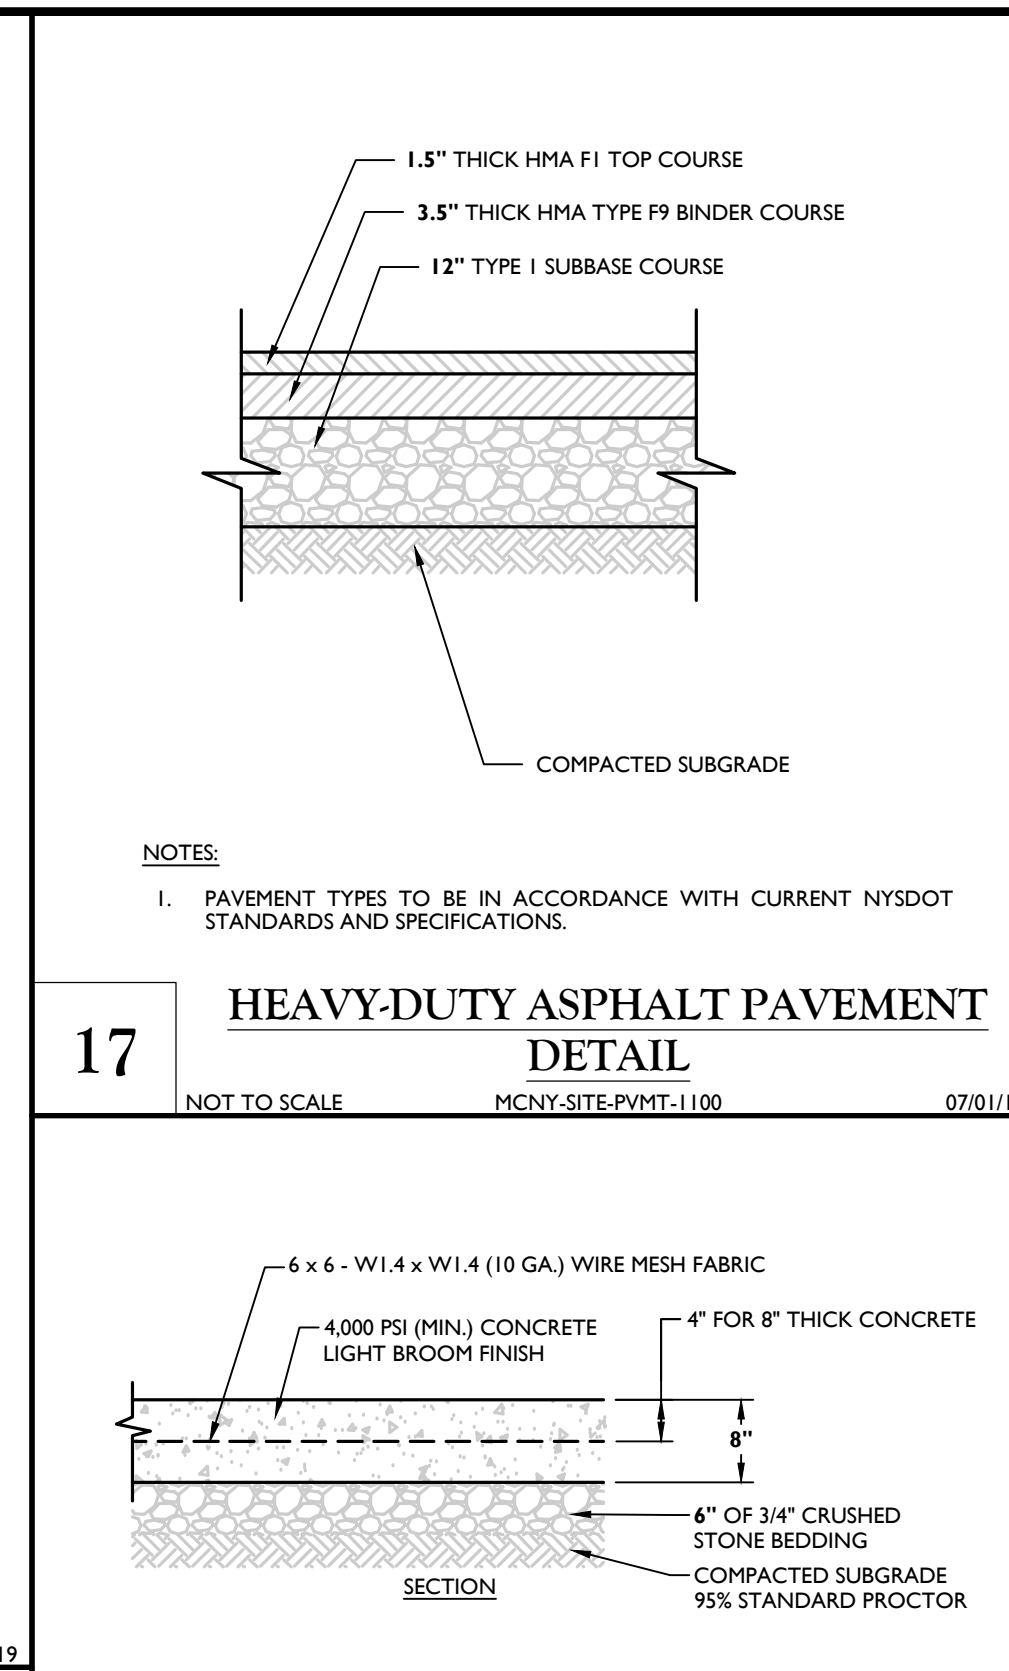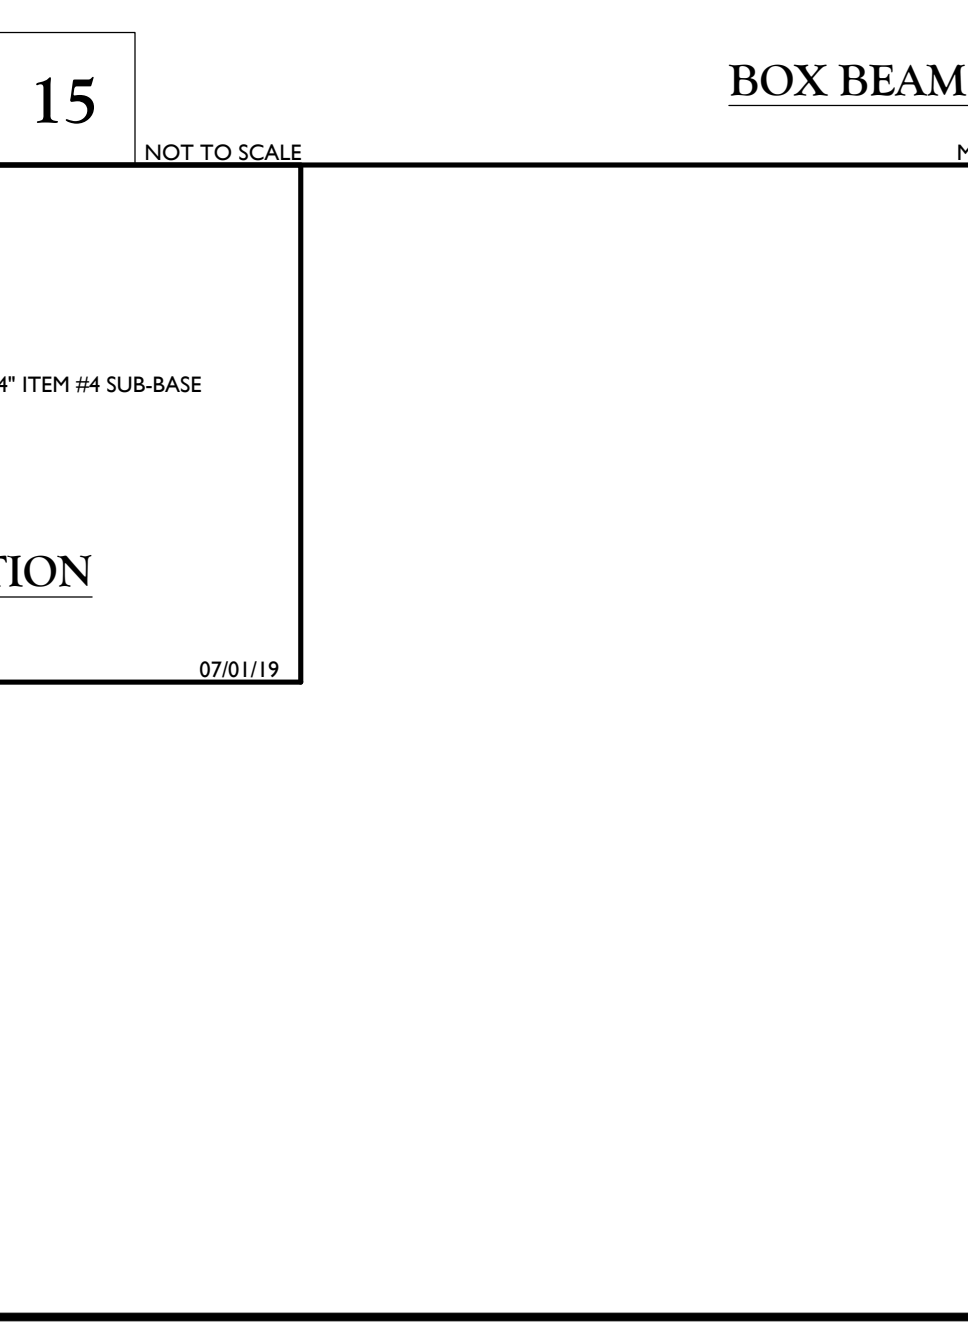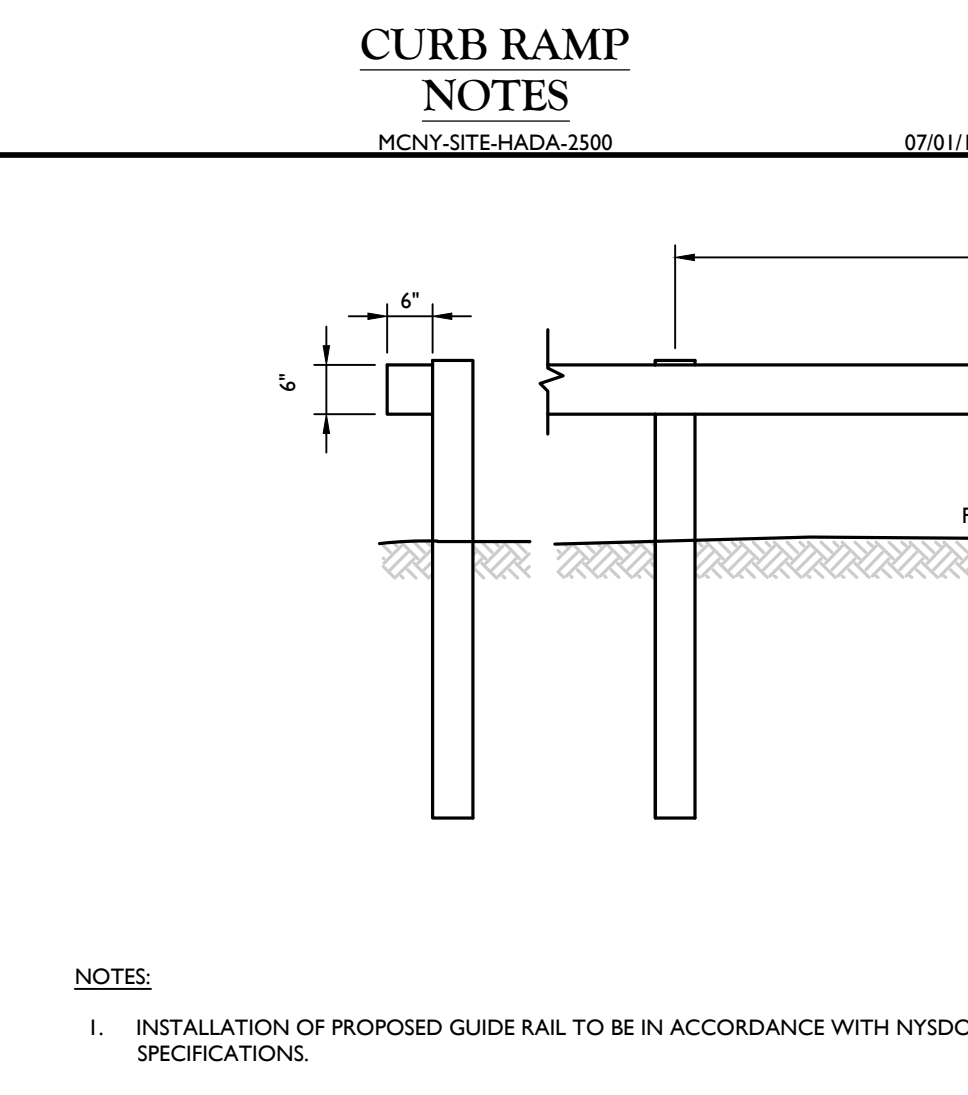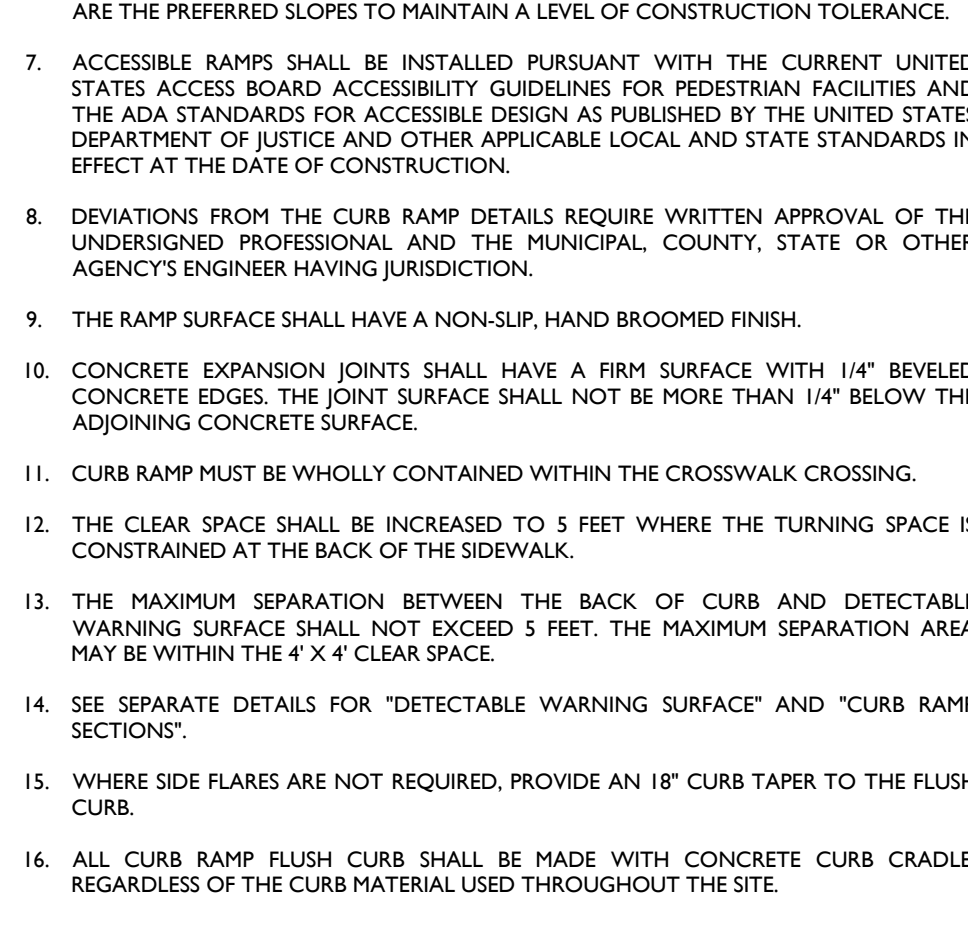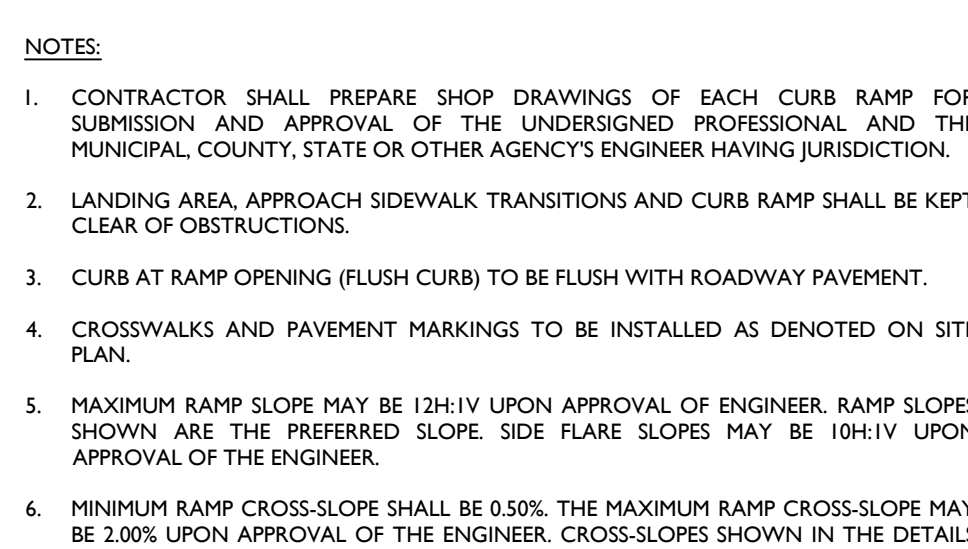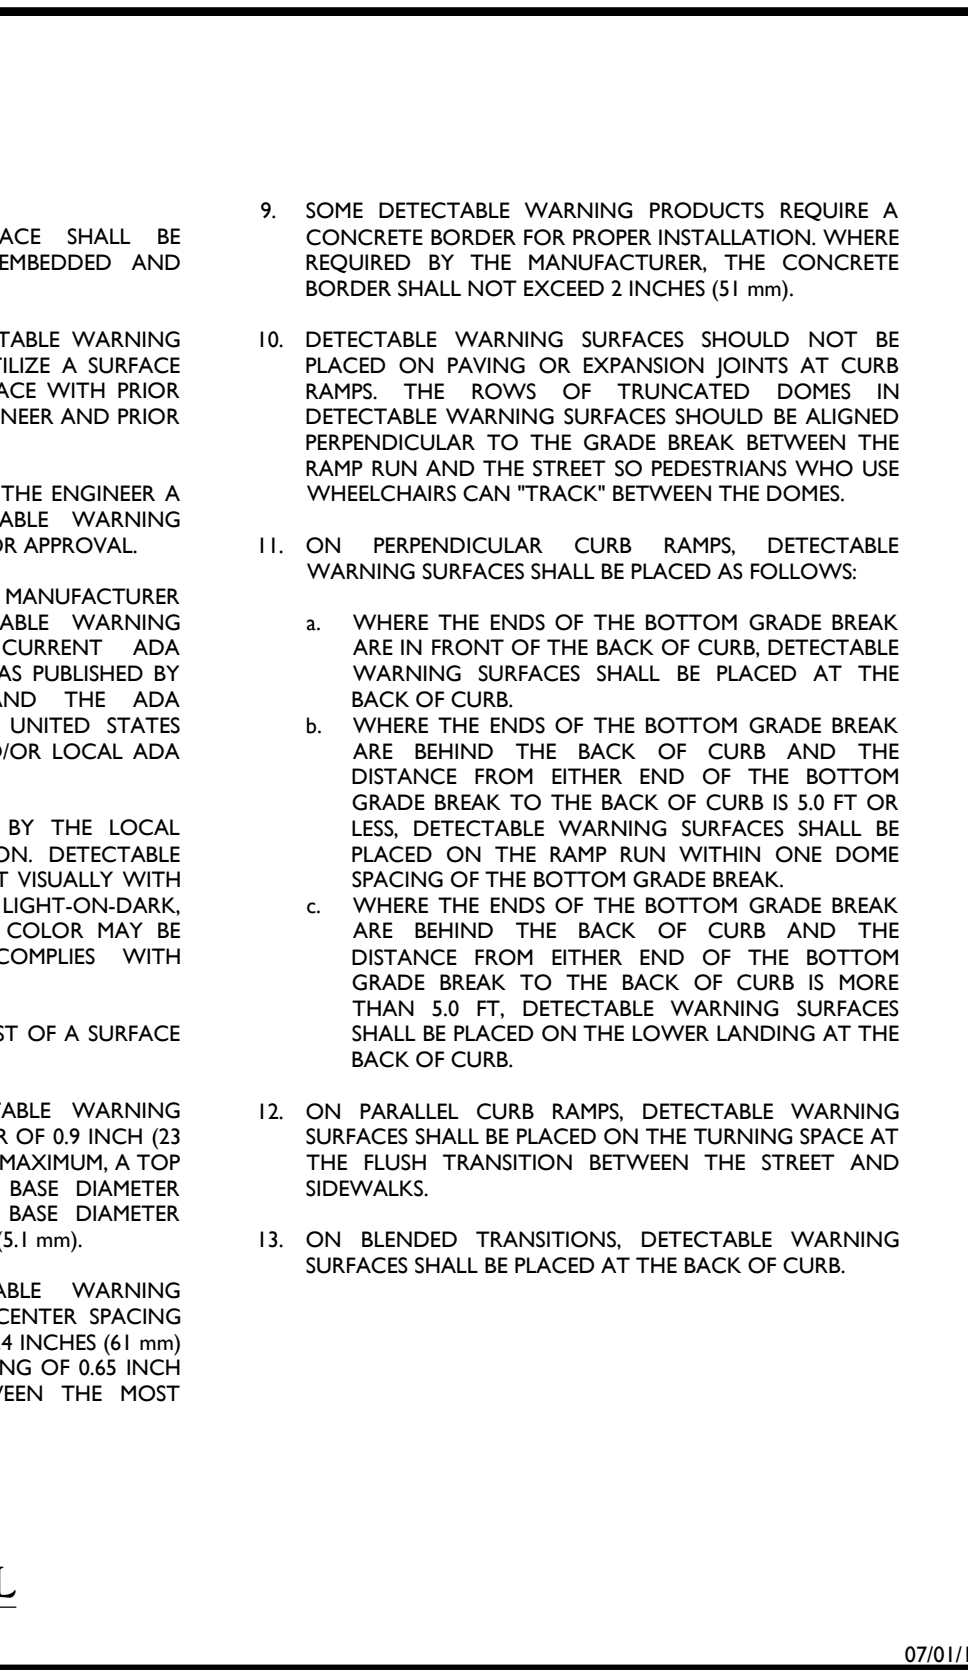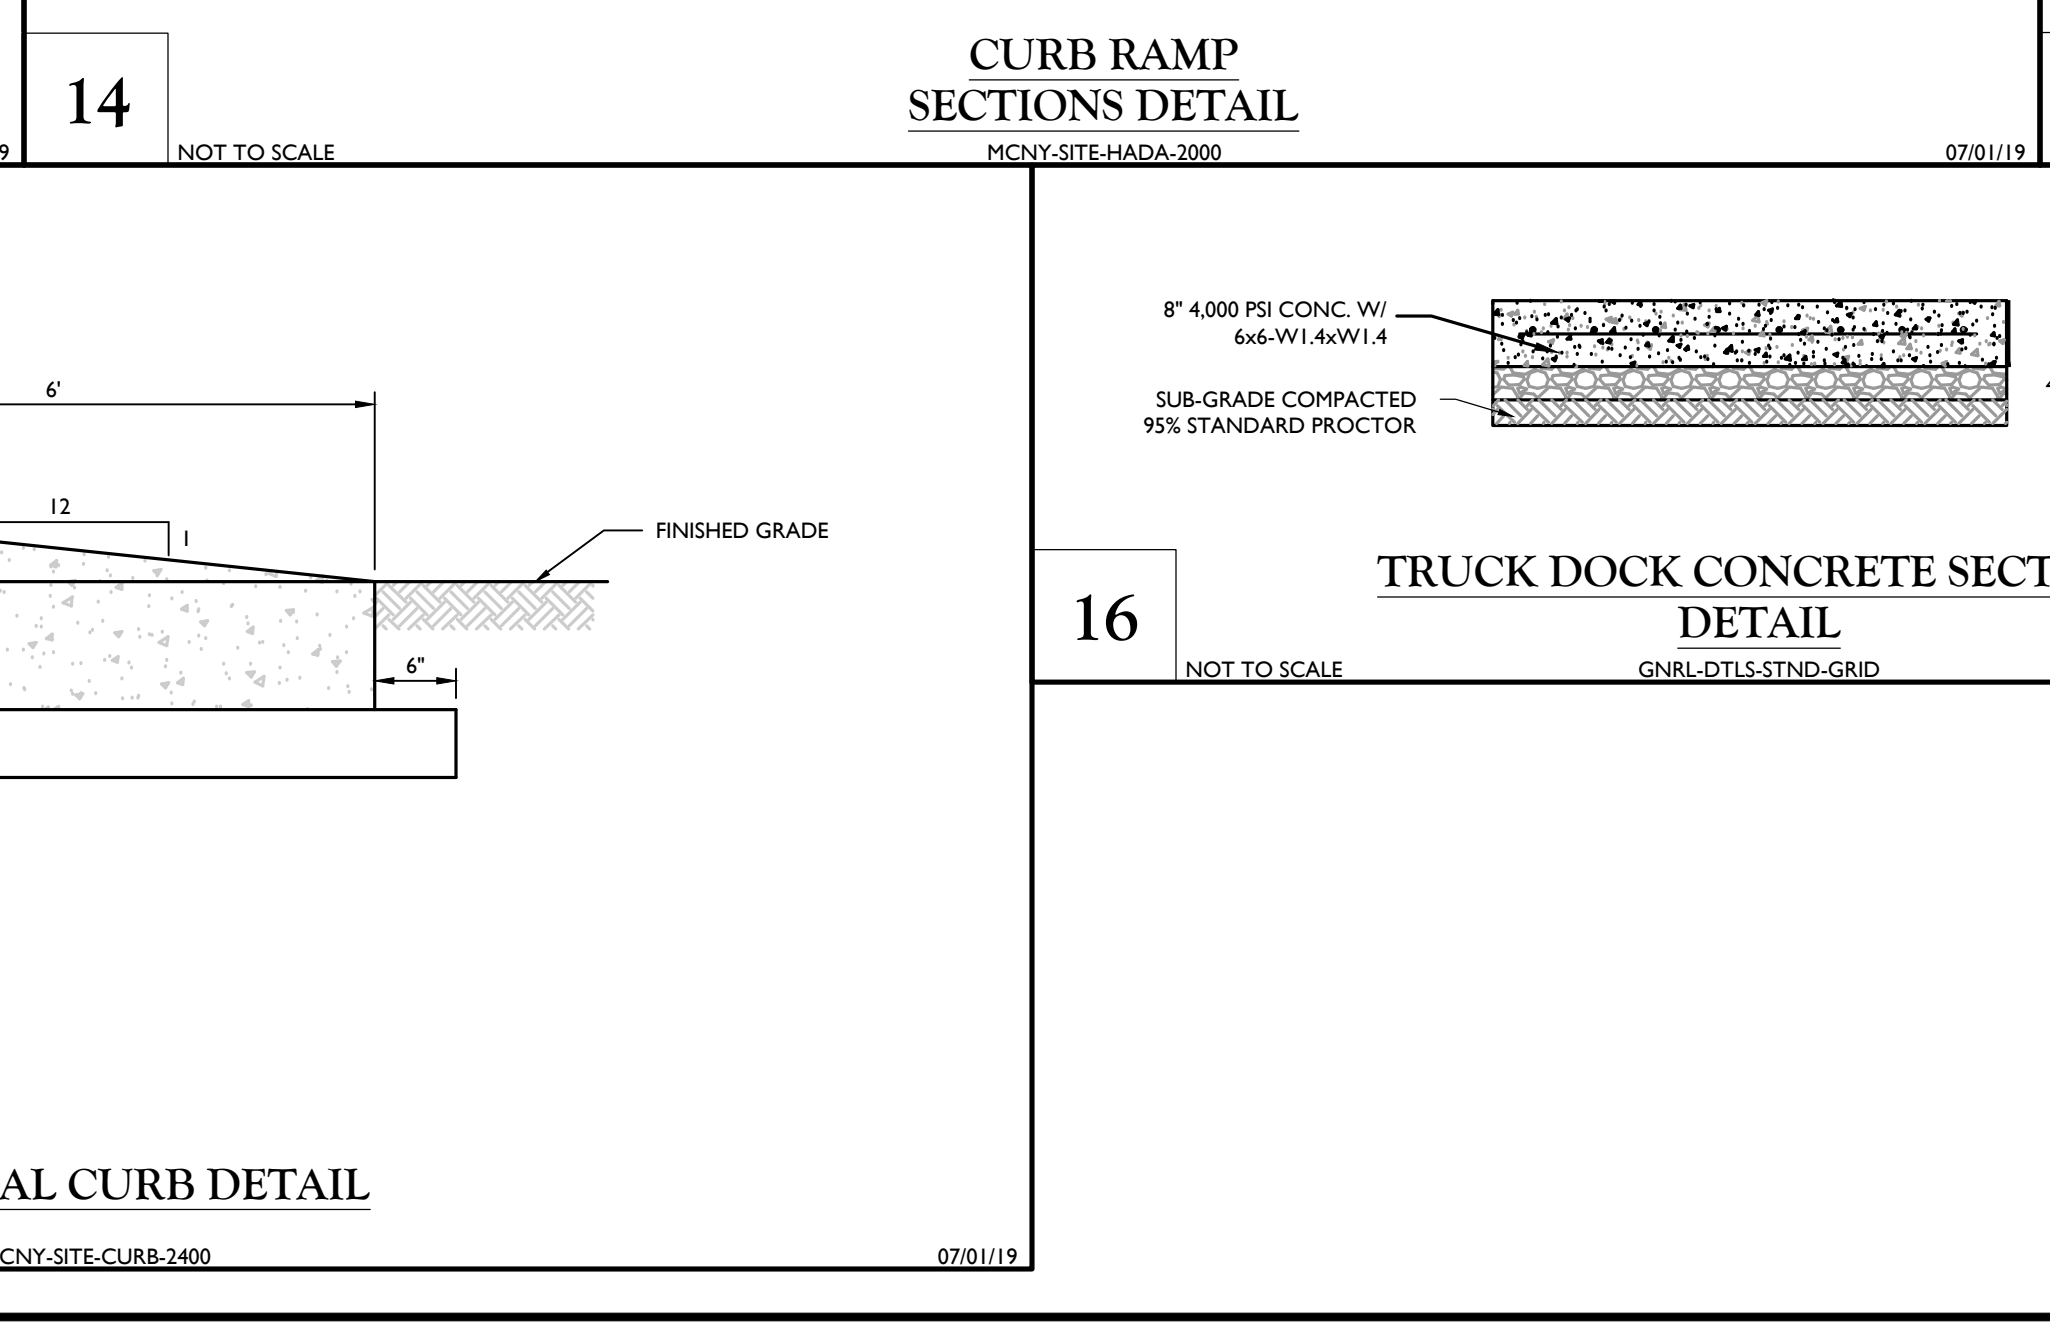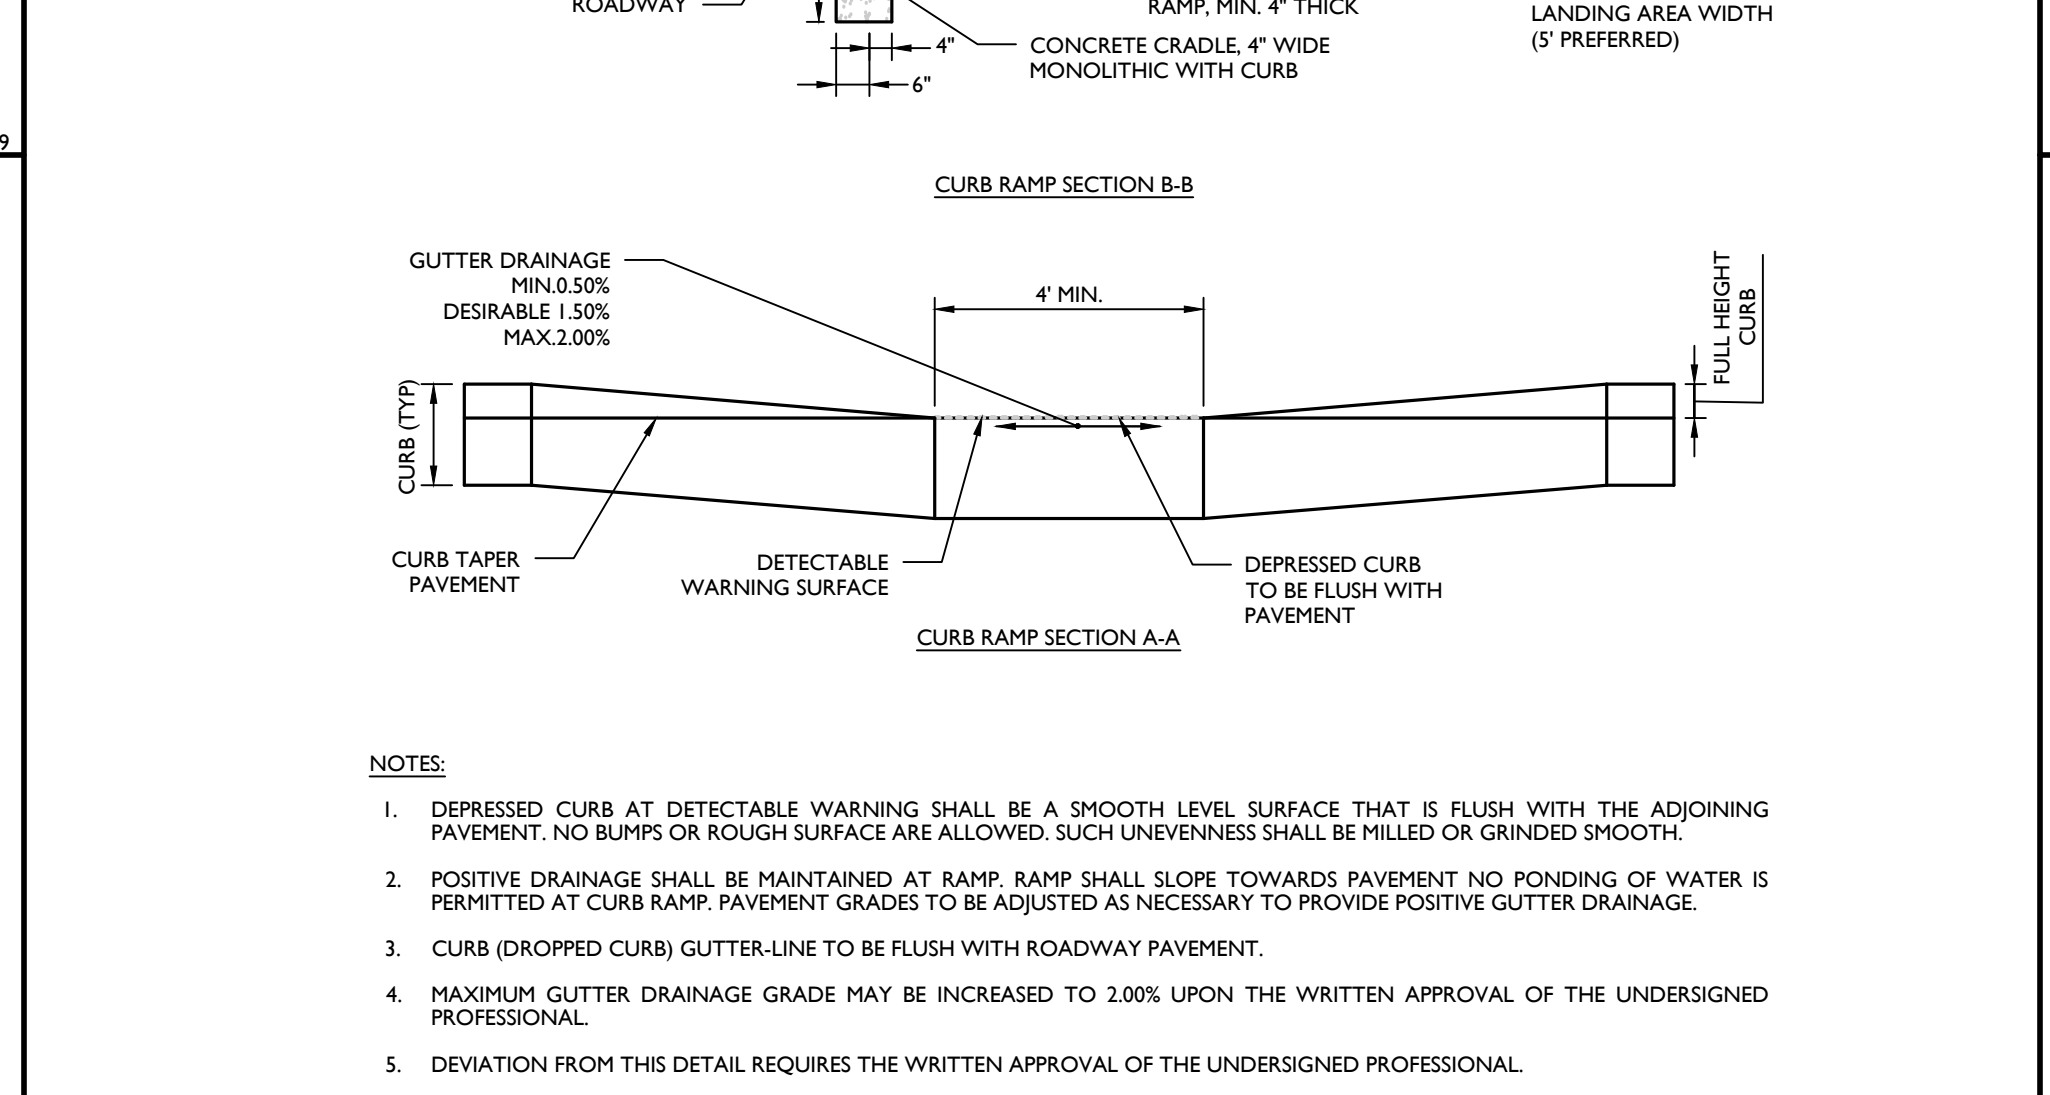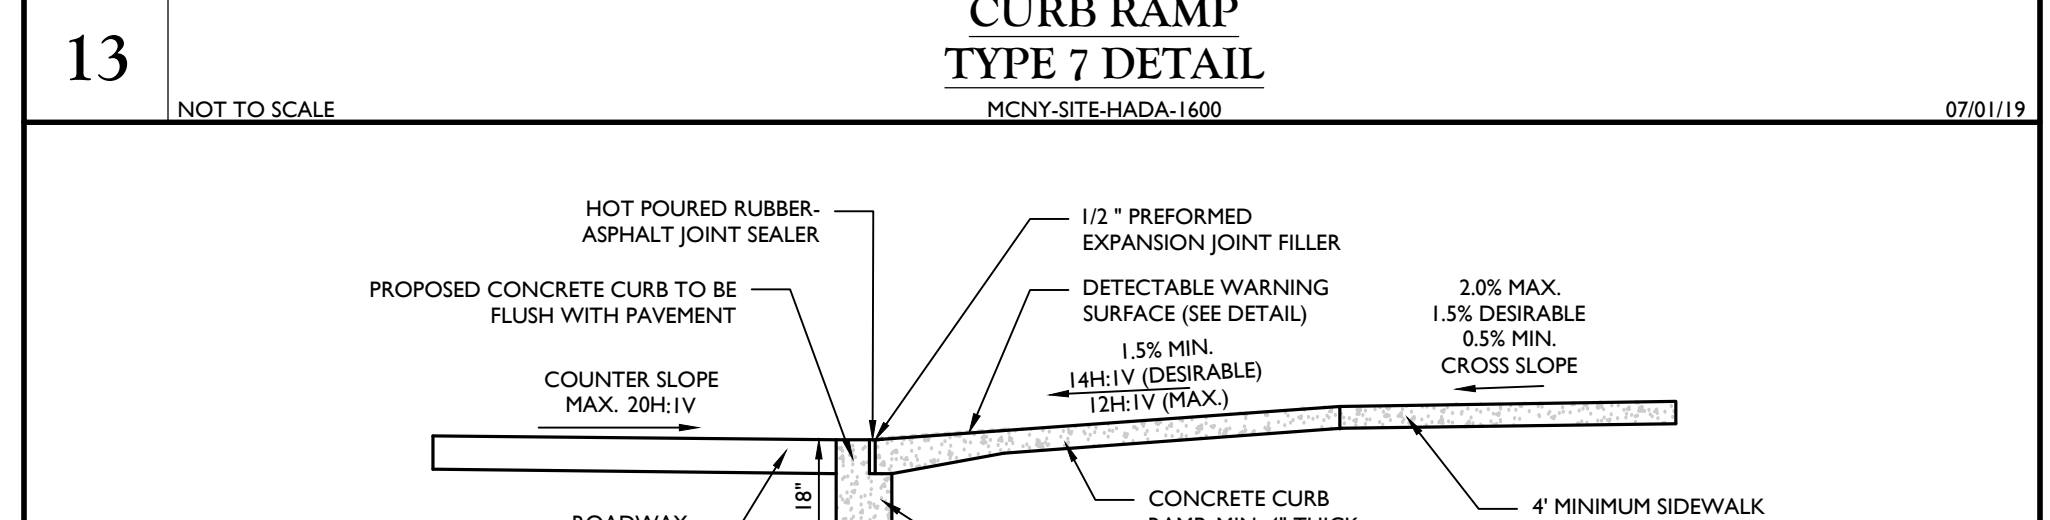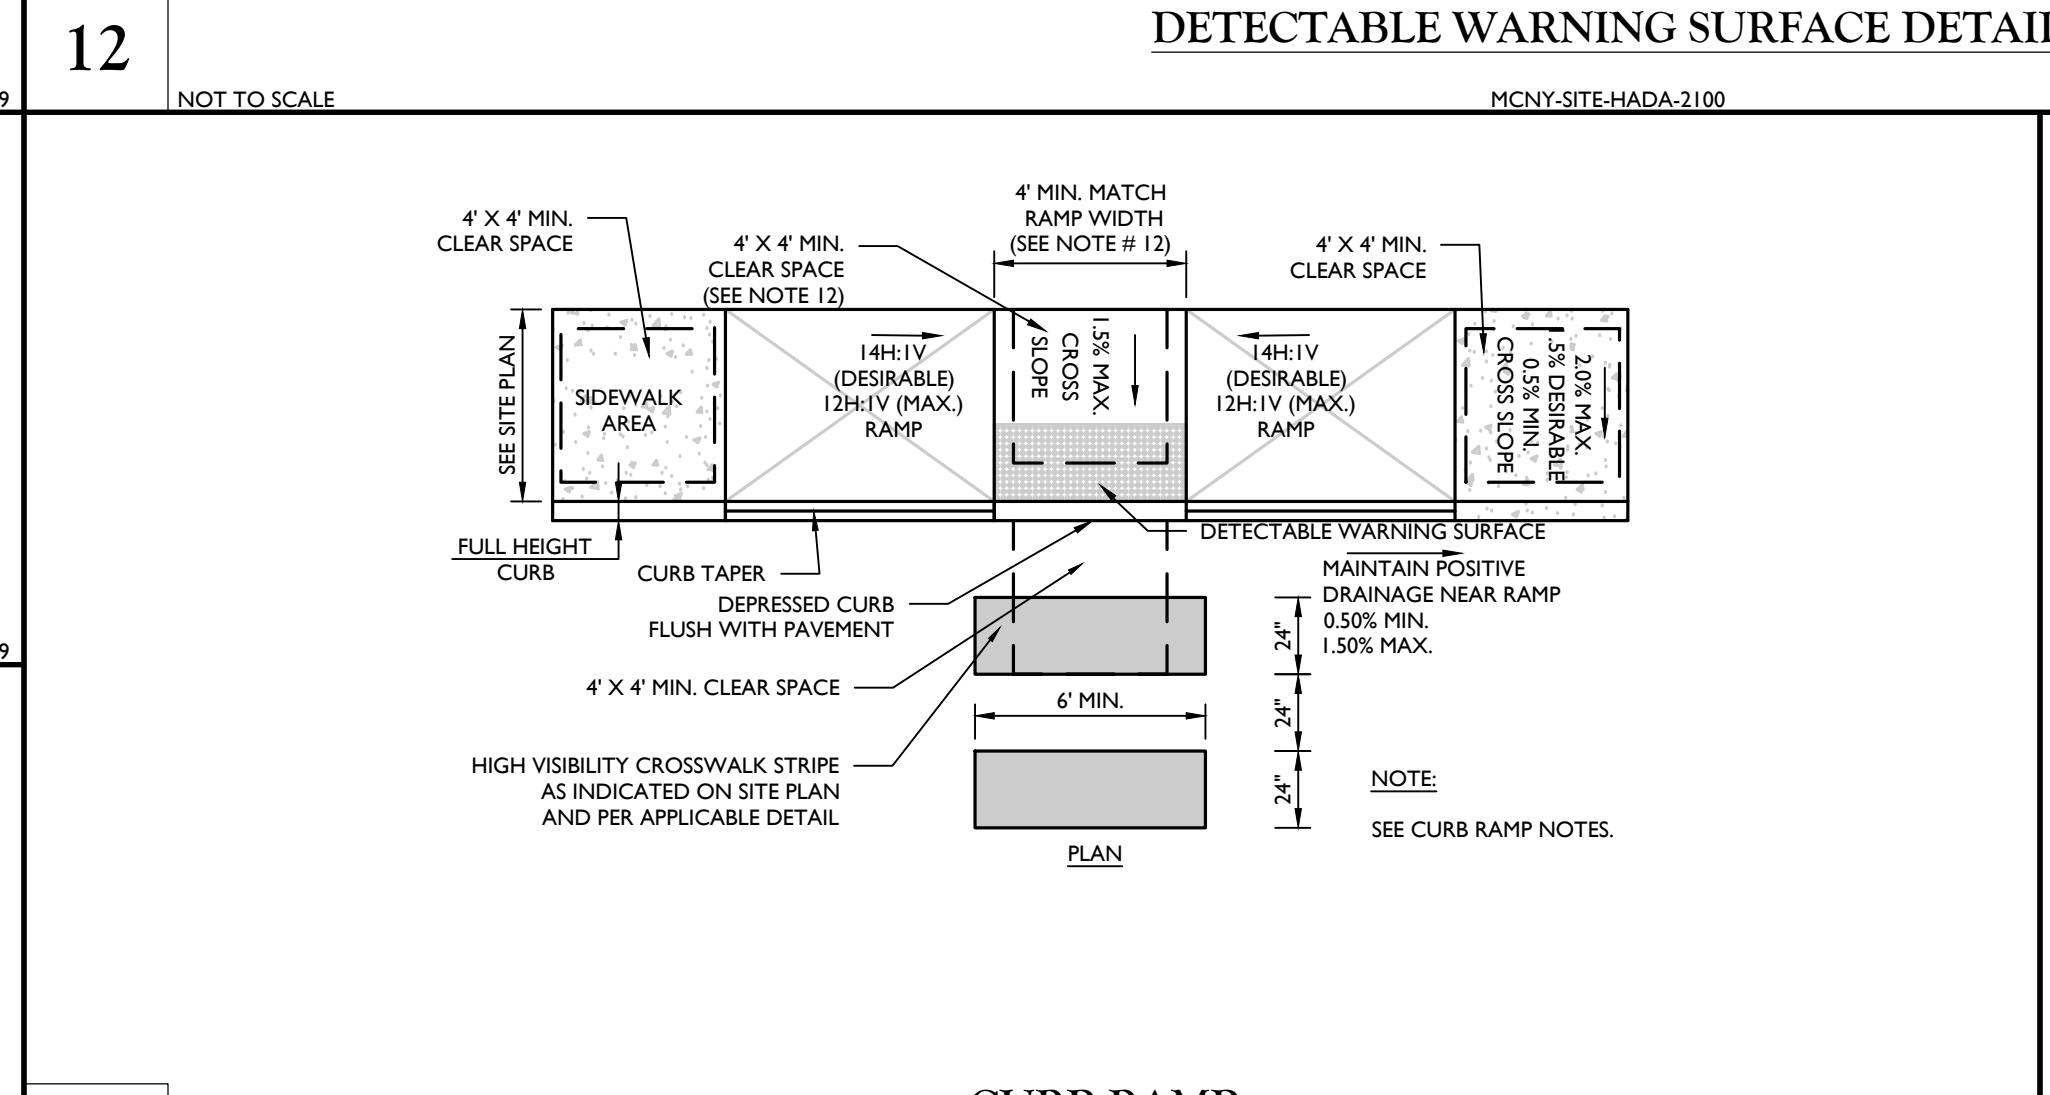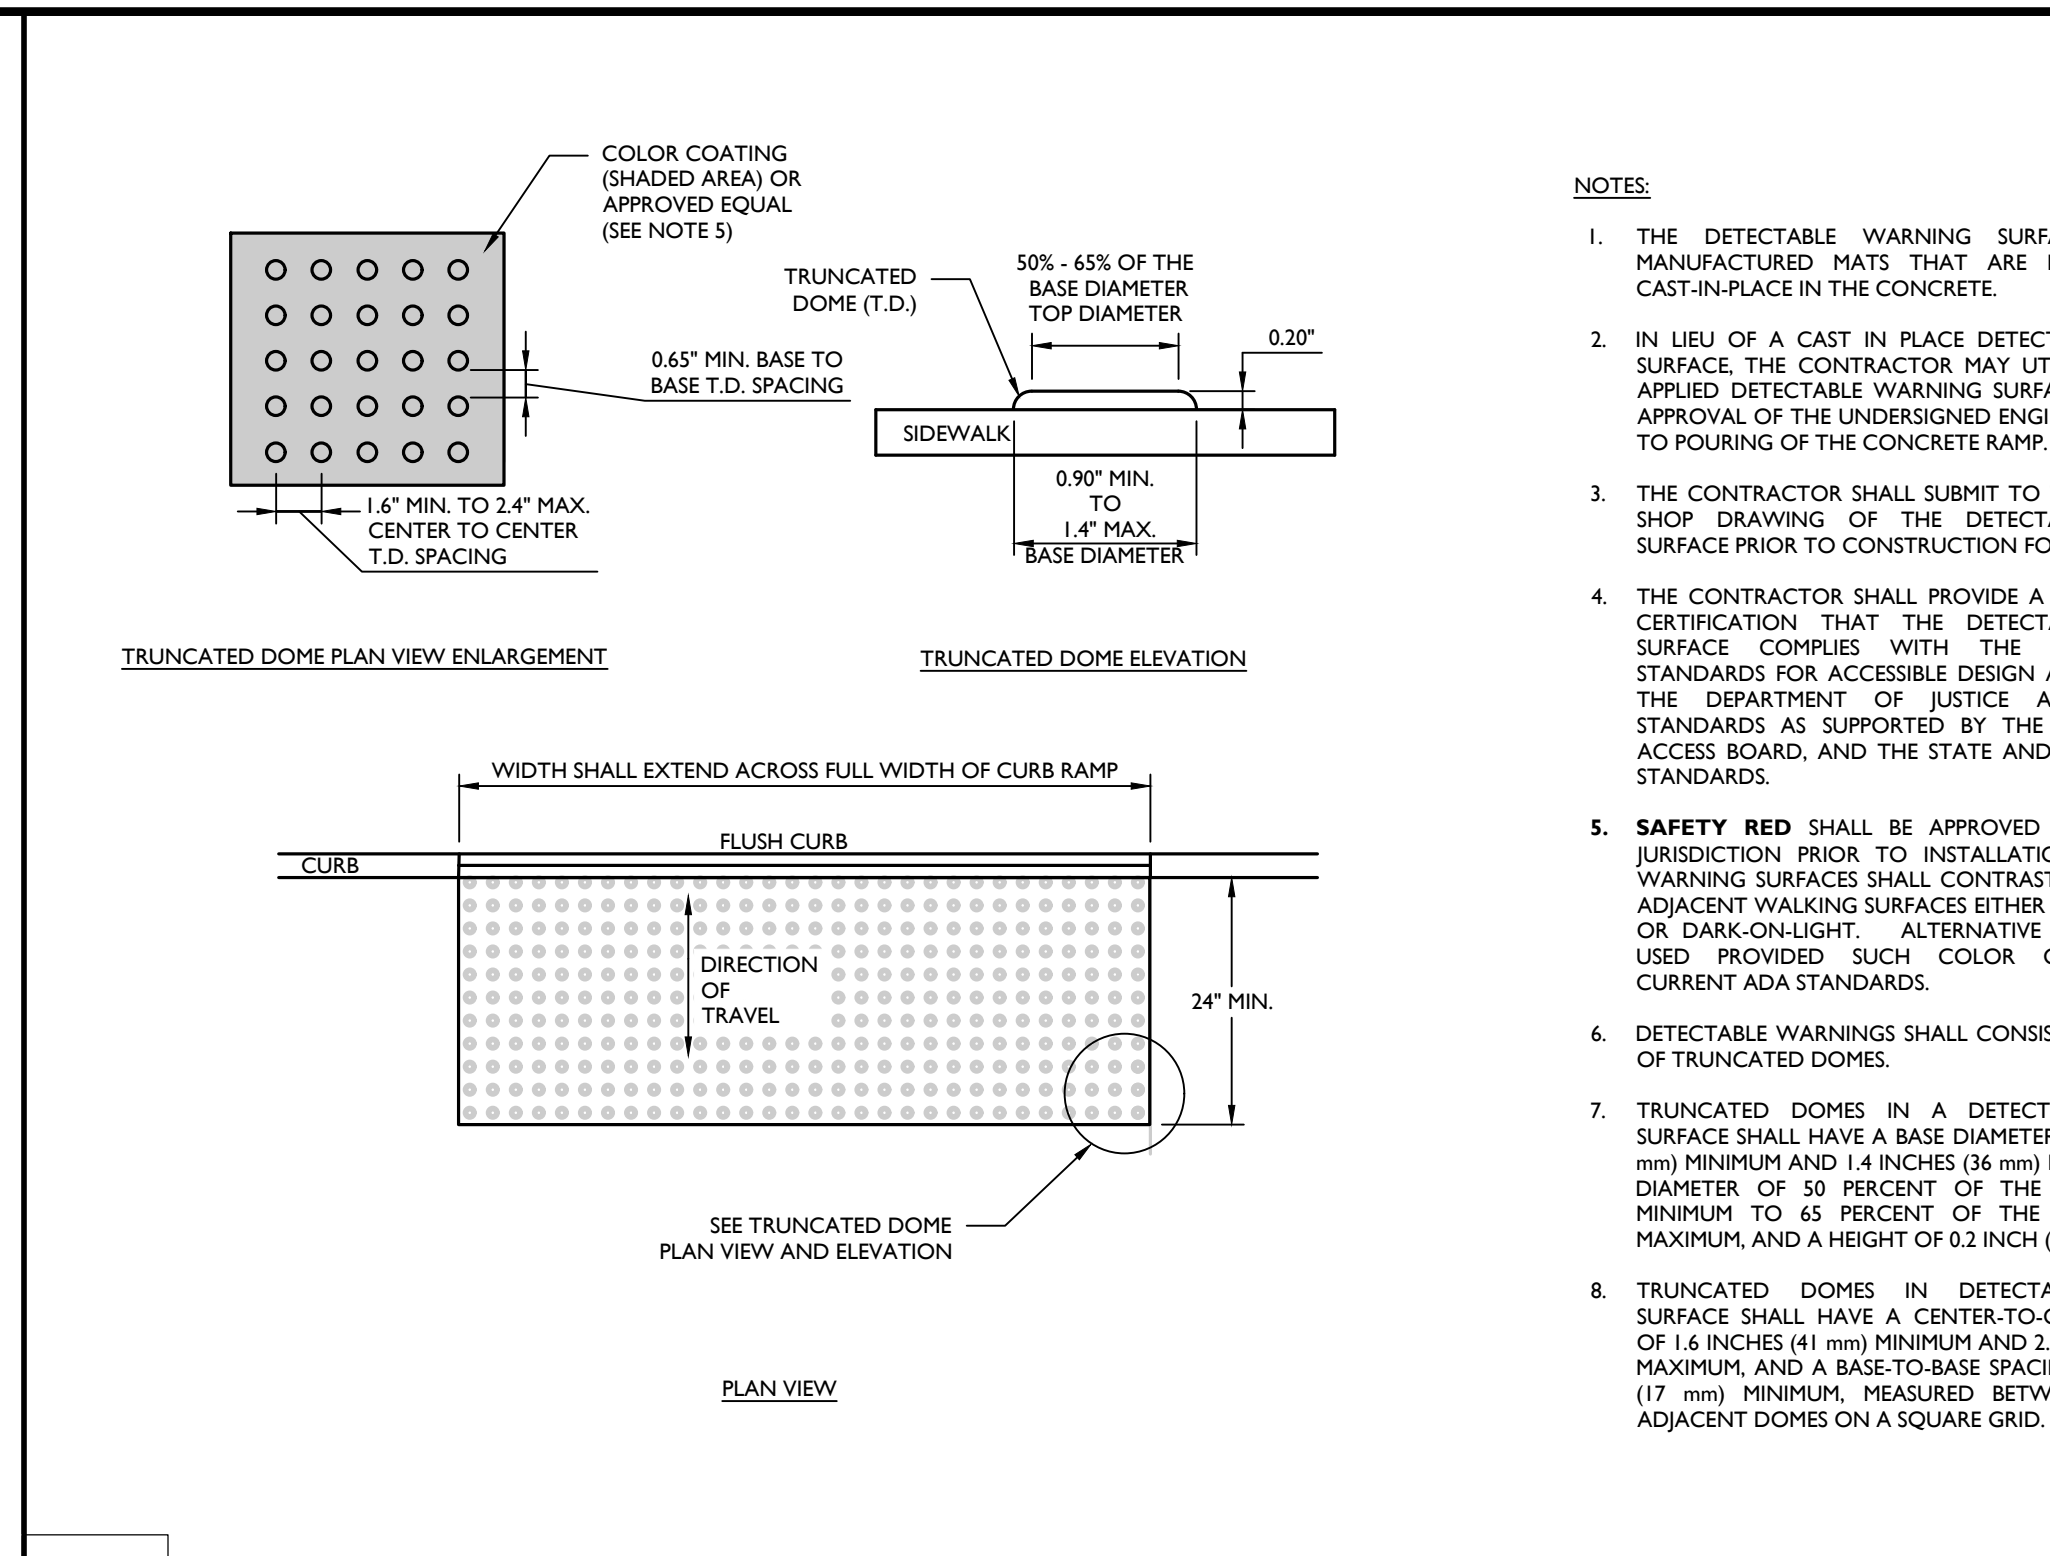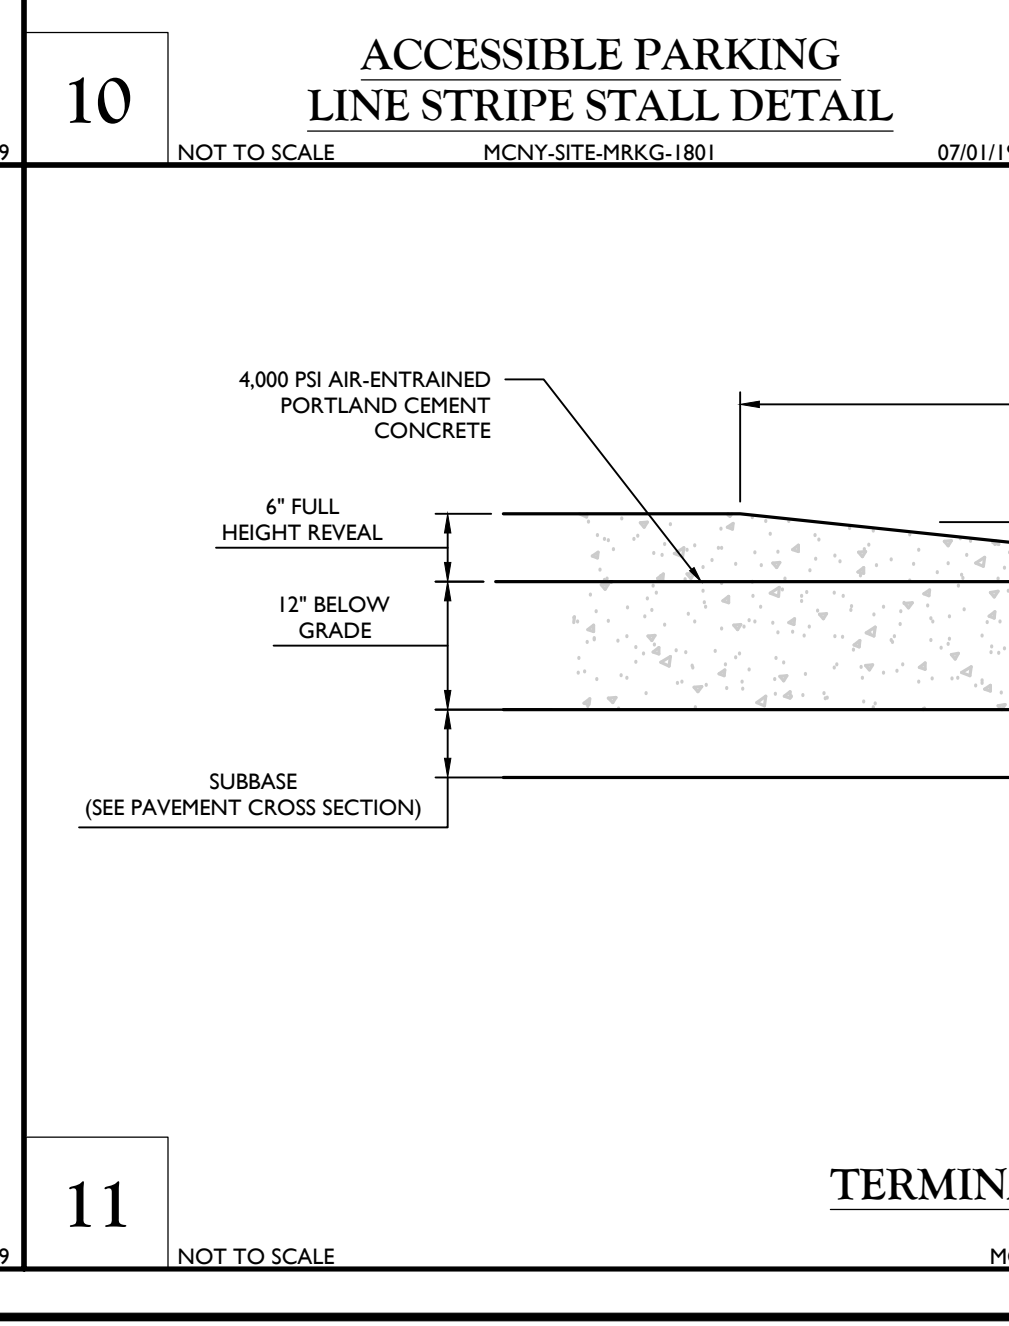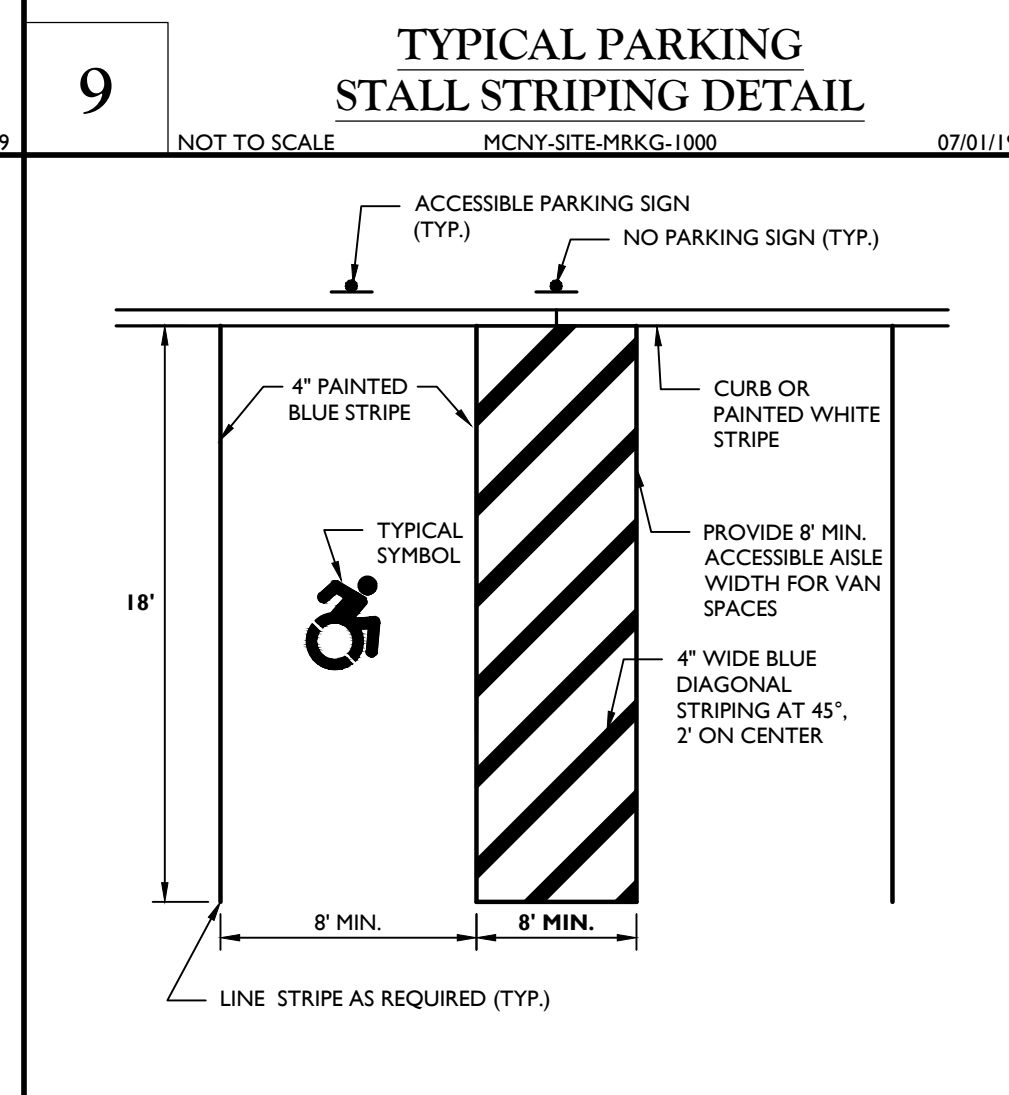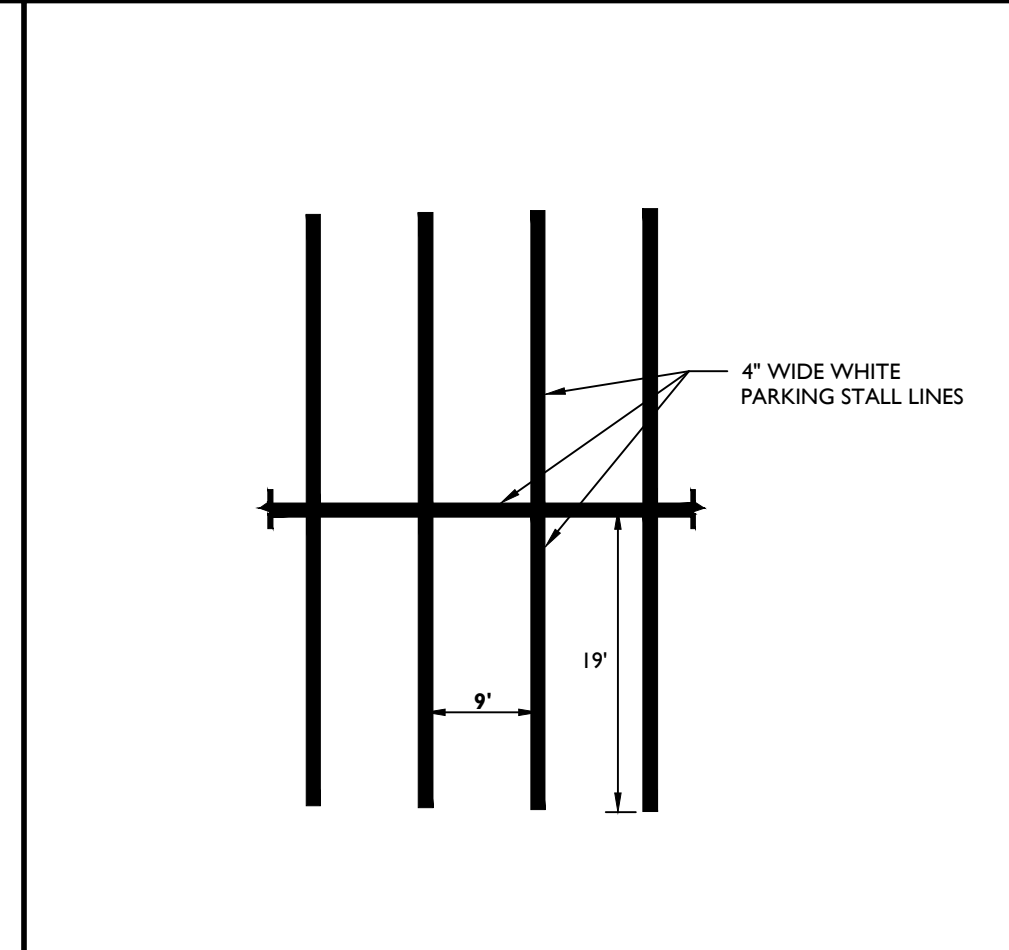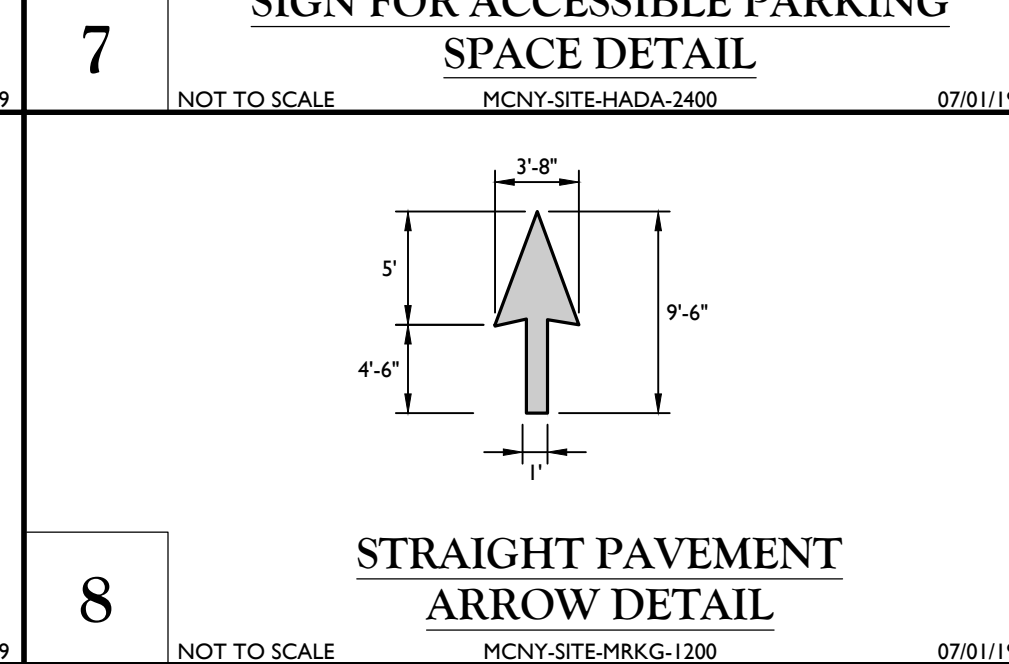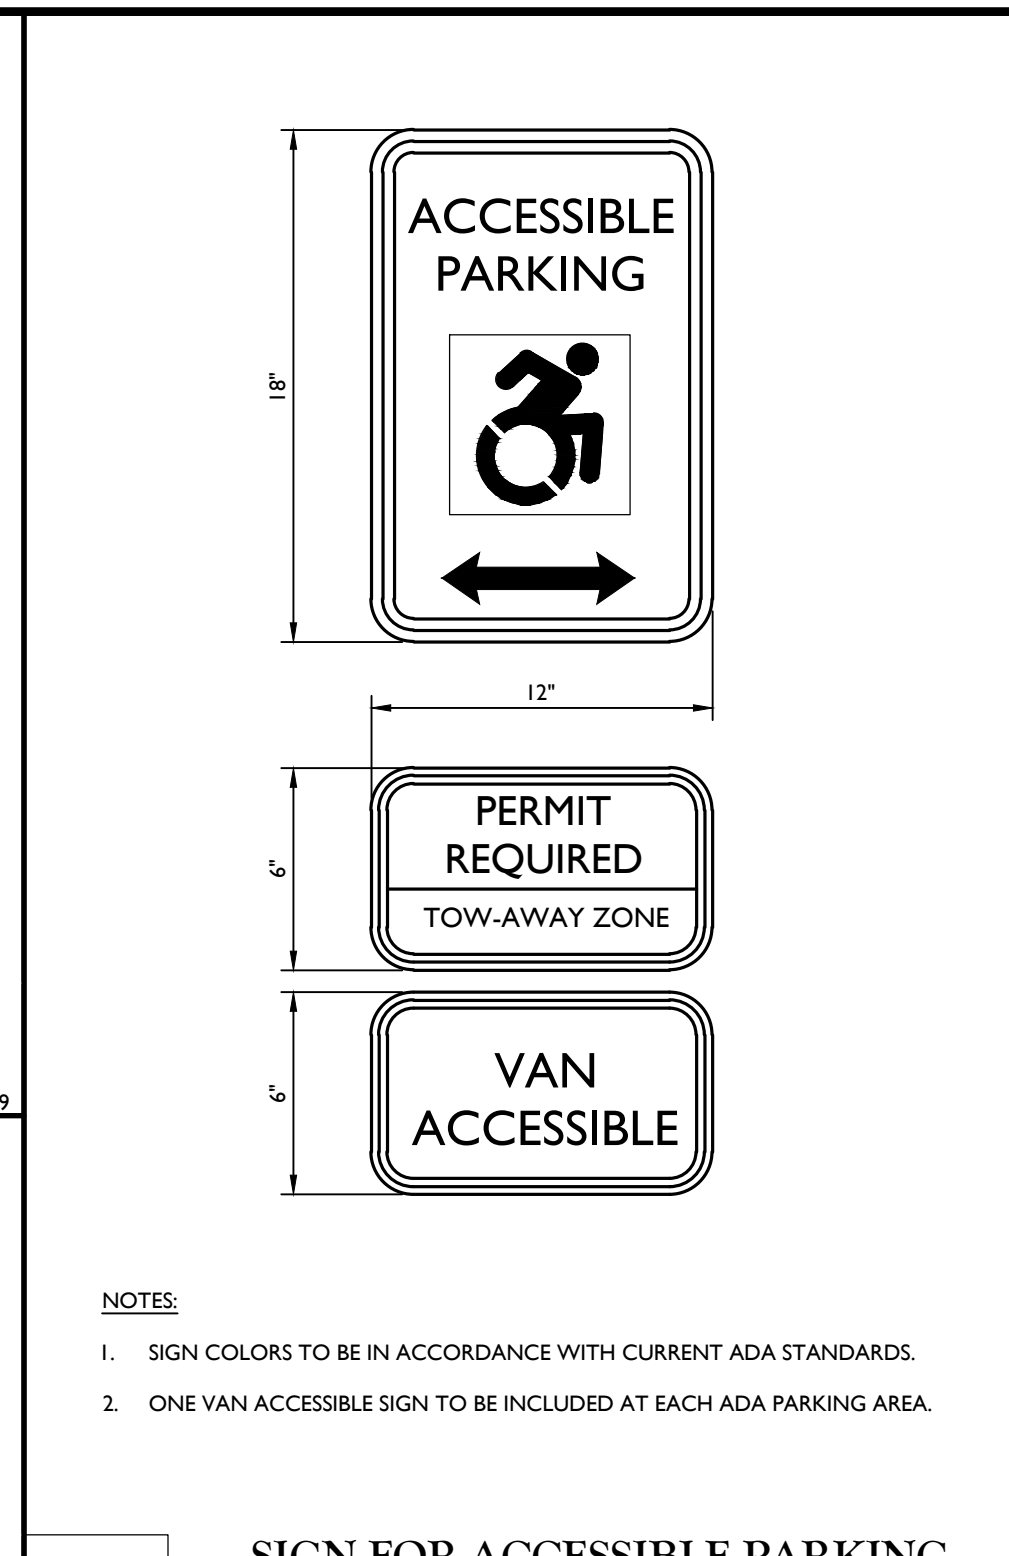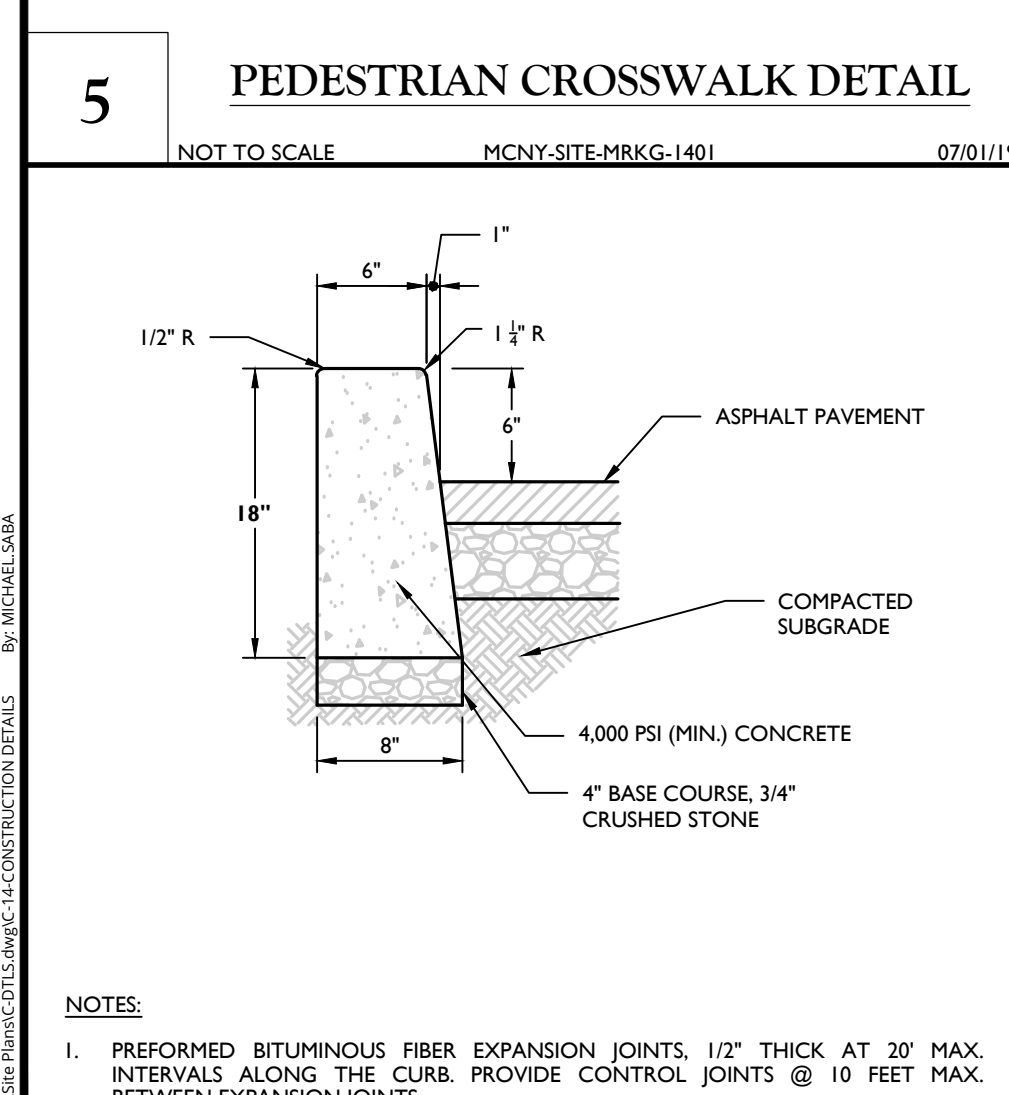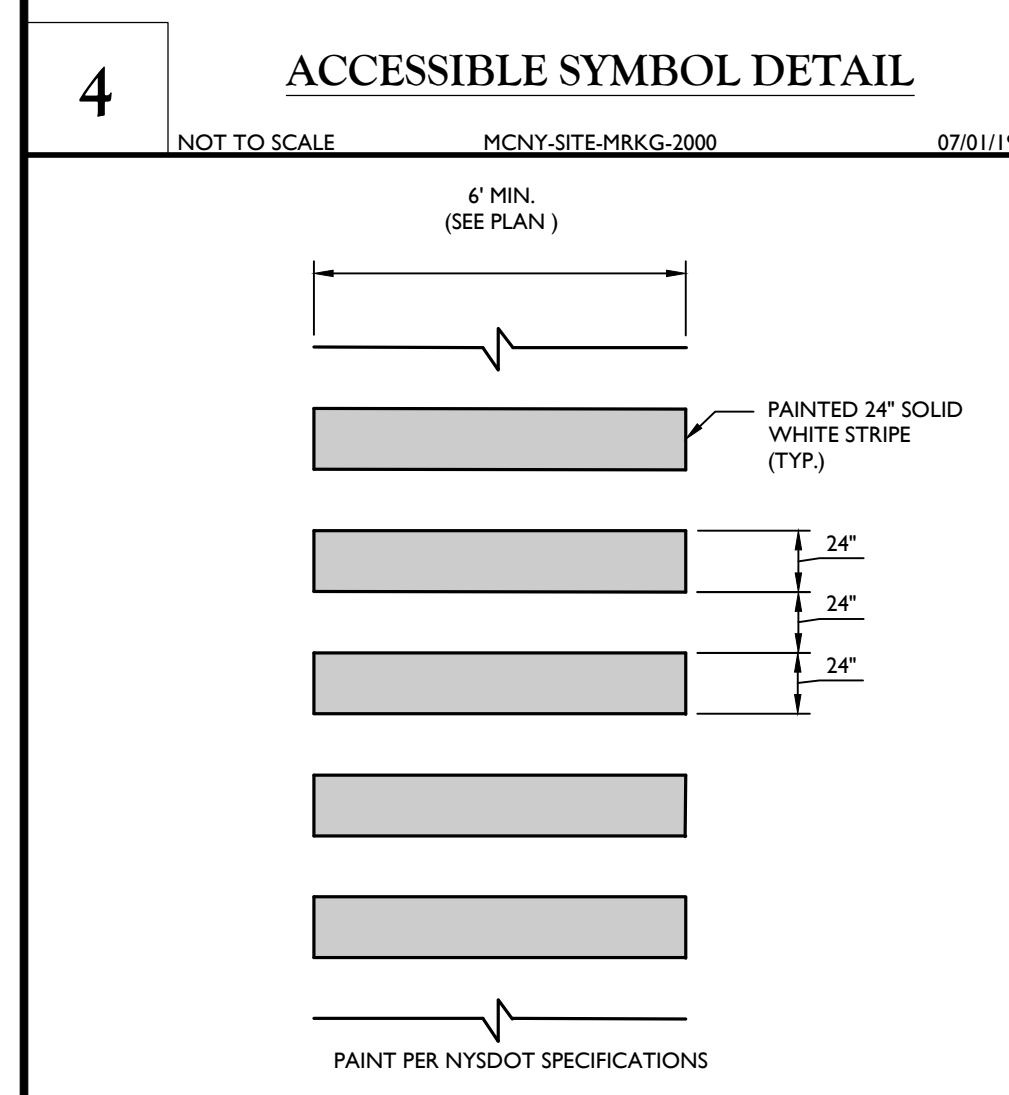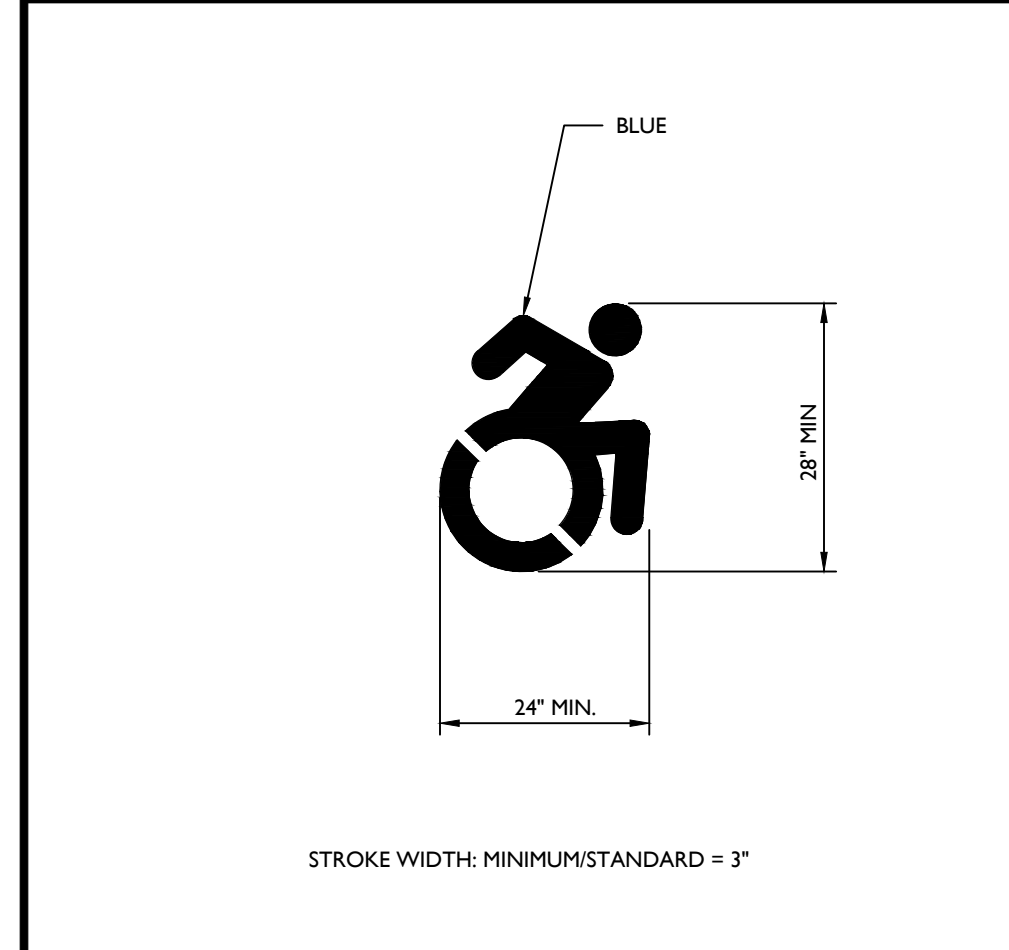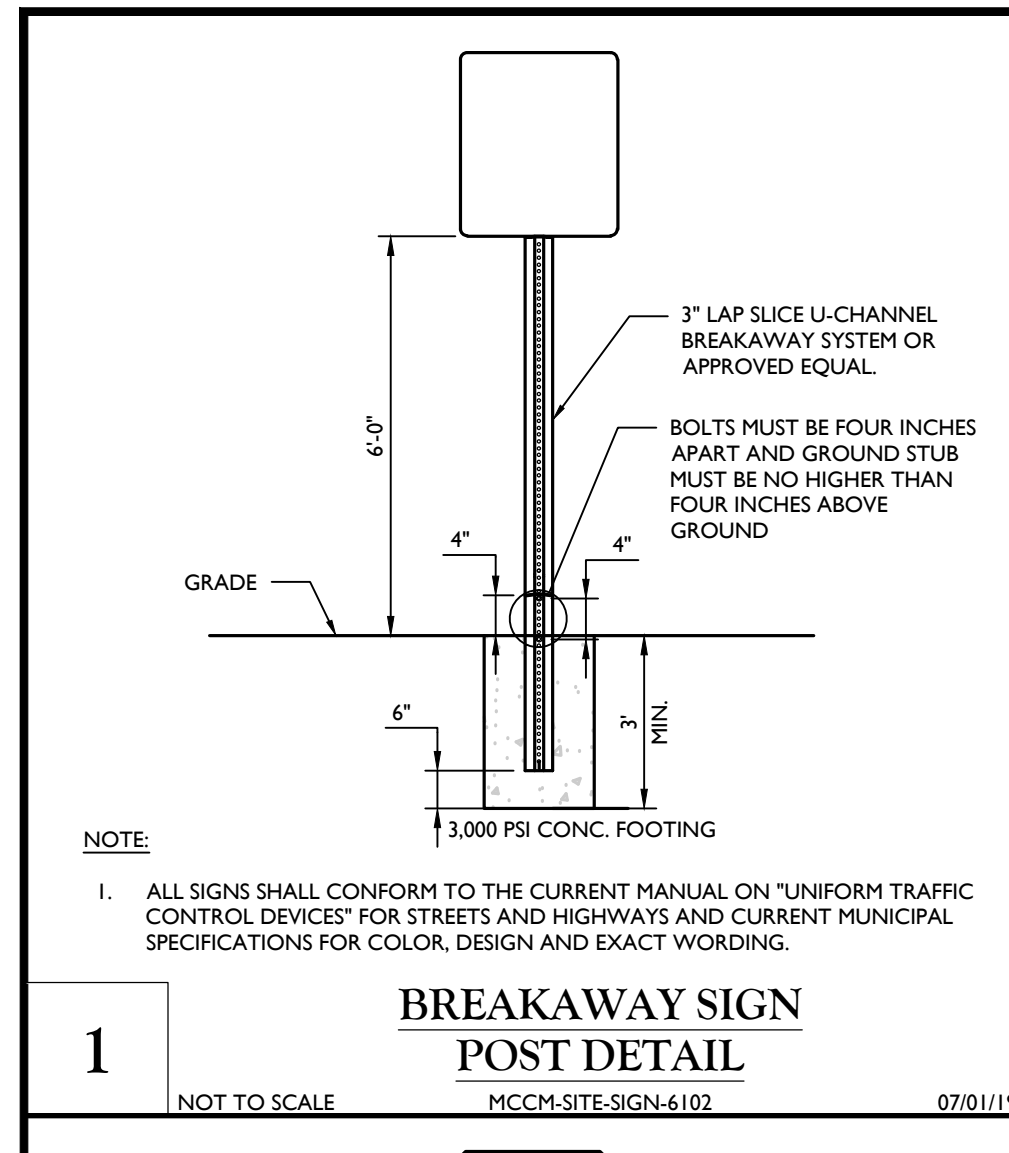

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Phone: 845.564.4495
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| REV | DATE | DESCRIPTION | DRAWN BY | DATE | DESCRIPTION |
|-----|----------|--|----------|------|-------------|
| 1 | 07/01/19 | ISSUED FOR PRELIMINARY BOARD COMMENTS | CPM | | |
| 2 | 08/01/21 | ISSUED FOR SITE ENTRANCE AND RAMPWAY IMPROVEMENT PLANS | CPM | | |
| 3 | 08/01/21 | ISSUED FOR LOCAL COMMENTS | CPM | | |
| 4 | 08/01/21 | ISSUED FOR LOCAL COMMENTS | CPM | | |
| 5 | 08/01/21 | ISSUED FOR LOCAL COMMENTS | CPM | | |
| 6 | 08/01/21 | ISSUED FOR LOCAL COMMENTS | CPM | | |
| 7 | 08/01/21 | ISSUED FOR LOCAL COMMENTS | CPM | | |
| 8 | 08/01/21 | ISSUED FOR LOCAL COMMENTS | CPM | | |
| 9 | 08/01/21 | ISSUED FOR LOCAL COMMENTS | CPM | | |
| 10 | 08/01/21 | ISSUED FOR LOCAL COMMENTS | CPM | | |
| 11 | 08/01/21 | ISSUED FOR LOCAL COMMENTS | CPM | | |
| 12 | 08/01/21 | ISSUED FOR LOCAL COMMENTS | CPM | | |
| 13 | 08/01/21 | ISSUED FOR LOCAL COMMENTS | CPM | | |
| 14 | 08/01/21 | ISSUED FOR LOCAL COMMENTS | CPM | | |
| 15 | 08/01/21 | ISSUED FOR LOCAL COMMENTS | CPM | | |
| 16 | 08/01/21 | ISSUED FOR LOCAL COMMENTS | CPM | | |
| 17 | 08/01/21 | ISSUED FOR LOCAL COMMENTS | CPM | | |
| 18 | 08/01/21 | ISSUED FOR LOCAL COMMENTS | CPM | | |
| 19 | 08/01/21 | ISSUED FOR LOCAL COMMENTS | CPM | | |
| 20 | 08/01/21 | ISSUED FOR LOCAL COMMENTS | CPM | | |
| 21 | 08/01/21 | ISSUED FOR LOCAL COMMENTS | CPM | | |
| 22 | 08/01/21 | ISSUED FOR LOCAL COMMENTS | CPM | | |

REGISTERED LANDSCAPE ARCHITECT
JUSTIN ERIC DATES
NEW YORK REGISTERED LANDSCAPE ARCHITECT
LICENSE NUMBER: 001964-01
COLLIERS ENGINEERING & DESIGN CT, P.C.

SITE PLAN FOR RDM GROUP 1081 DOLSONTOWN ROAD

TAX LOTS: 6-1-1

TOWN OF WAWAYANDA ORANGE COUNTY NEW YORK STATE

Colliers Engineering & Design
555 Hudson Valley Avenue, Suite 101, New Windsor, NY 12553
Phone: 845.564.4495
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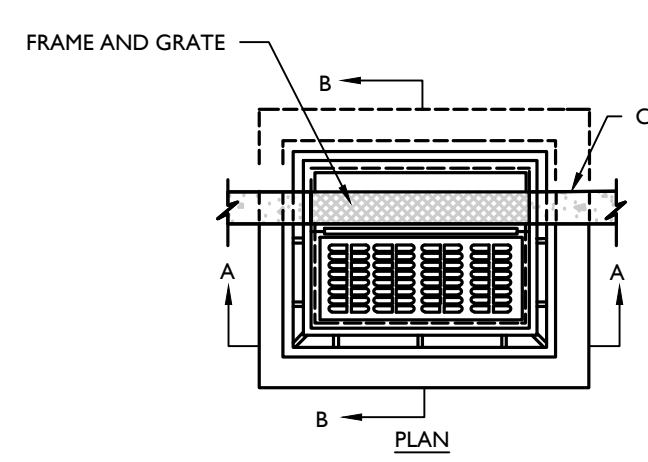
SCALE: AS SHOWN DATE: 06/24/2020 DRAWN BY: CPM CHECKED BY: JED
PROJECT NUMBER: 20000069A DRAWING NAME: C-0115
SHEET TITLE: CONSTRUCTION DETAILS
SHEET NUMBER: 14 of 17

TOWN OF WAWAYANDA PLANNING BOARD

NOTE: DO NOT SCALE DRAWINGS FOR CONSTRUCTION.

NOTES:


- 1. INVERTS TO BE ELIMINATED IN BOTTOM OF TERMINAL INLETS. MINIMUM DIFFERENCE IN INVERTS TO BE 0.1 FEET.
2. THIS INLET SHALL BE CONSTRUCTED OF PRECAST CONCRETE OR SOLID CONCRETE BLOCK. IF CONCRETE BLOCK IS USED, THE BOTTOM SHALL BE AS SHOWN FOR CONCRETE & THE OUTSIDE OF THE WALLS SHALL BE PLASTERED WITH 1/2" COAT OF 1:2 CEMENT SAND MORTAR. THE INSIDE WALL JOINTS SHALL BE STRUCK AND POINTED.
3. PROVIDE 7/8" DIA. X 7' X 12', 12" O.C. COPOLYMER POLYPROPYLENE PLASTIC STEPS WITH 1/2" DIA. GRADE 60 STEEL REINFORCEMENT BY M.A. INDUSTRIES, P52-PP OR P52-B WITH PRECAST PRESS FIT INSERTS, 12" O.C. OR APPROVED EQUIVALENT.
4. INLET FRAME AND GRATES TO BE CAMPBELL FOUNDRY # 2617, OR APPROVED EQUAL.
5. WHEN DEPTH IS GREATER THAN 12" THE WALLS SHOULD BE 8" THICK CONCRETE OR SOLID CONCRETE BLOCK AND THE FOOTING SHALL BE EXTENDED TO 12" BEYOND THE OUTSIDE WALLS.
6. ALL CONCRETE TO BE 4000 PSI.
7. IN ACID SOILS, TWO COATS OF BITUMASTIC WATER PROOFING SHALL BE APPLIED PER MANUFACTURER'S SPECIFICATION.
8. INLETS SHALL BE CONSTRUCTED IN ACCORDANCE WITH H-20 LOADING REQUIREMENTS.



SINGLE CATCH BASIN DETAIL

NOTES:

- 1. INVERTS TO BE ELIMINATED IN BOTTOM OF TERMINAL INLETS. MINIMUM DIFFERENCE IN INVERTS TO BE 0.1 FEET.
2. THIS INLET SHALL BE CONSTRUCTED OF PRECAST CONCRETE OR SOLID CONCRETE BLOCK. IF CONCRETE BLOCK IS USED, THE BOTTOM SHALL BE AS SHOWN FOR CONCRETE & THE OUTSIDE OF THE WALLS SHALL BE PLASTERED WITH 1/2" COAT OF 1:2 CEMENT SAND MORTAR. THE INSIDE WALL JOINTS SHALL BE STRUCK AND POINTED.
3. PROVIDE 7/8" DIA. X 7' X 12', 12" O.C. COPOLYMER POLYPROPYLENE PLASTIC STEPS WITH 1/2" DIA. GRADE 60 STEEL REINFORCEMENT BY M.A. INDUSTRIES, P52-PP OR P52-B WITH PRECAST PRESS FIT INSERTS, 12" O.C. OR APPROVED EQUIVALENT.
4. INLET FRAME AND GRATES TO BE CAMPBELL FOUNDRY PATTERN # 2618 OR APPROVED EQUAL.
5. WHEN DEPTH IS GREATER THAN 12" THE WALLS SHOULD BE 8" THICK CONCRETE OR 8" SOLID CONCRETE BLOCK AND THE FOOTING SHALL BE EXTENDED TO 12" BEYOND THE OUTSIDE WALLS.
6. ALL CONCRETE TO BE 4000 PSI.
7. IN ACID SOILS, TWO COATS OF BITUMASTIC WATER PROOFING SHALL BE APPLIED PER MANUFACTURER'S SPECIFICATION.
8. INLETS SHALL BE CONSTRUCTED IN ACCORDANCE WITH H-20 LOADING REQUIREMENTS.

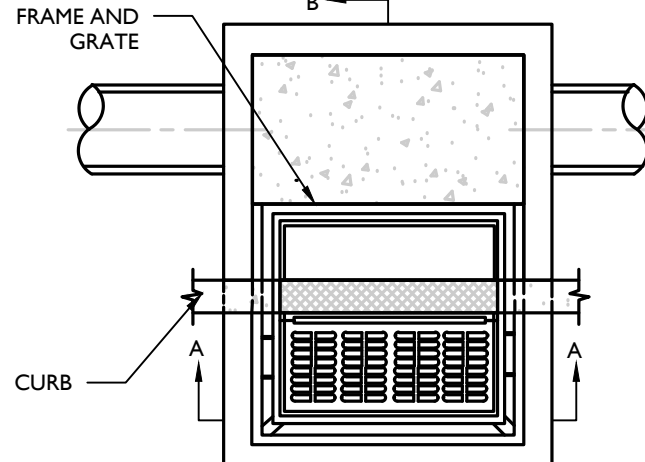


EXTENDED CATCH BASIN DETAIL

PLANTING SOIL NOTE:

Table with 2 columns: PARAMETER and VALUE. Lists soil characteristics like PH RANGE (5.2 TO 7.00), ORGANIC MATTER (1.5 TO 4.0%), MAGNESIUM (35 LBS. PER ACRE, MINIMUM), PHOSPHORUS (P2O5) (75 LBS. PER ACRE, MINIMUM), POTASSIUM (K2O) (85 LBS. PER ACRE, MINIMUM), SOLUBLE SALTS (500 ppm), CLAY (10 TO 25%), SILT (30 TO 55%), SAND (35 TO 60%).

Table with 5 columns: SYSTEM, OUTLET NAME, OUTLET SIZE, BED ELEVATION, 100 YR PEAK ELEVATION, TOP OF BERM ELEVATION, EMERGENCY SPILLWAY EL. Lists outlet details for P-3B, P-2D, and P-1B.

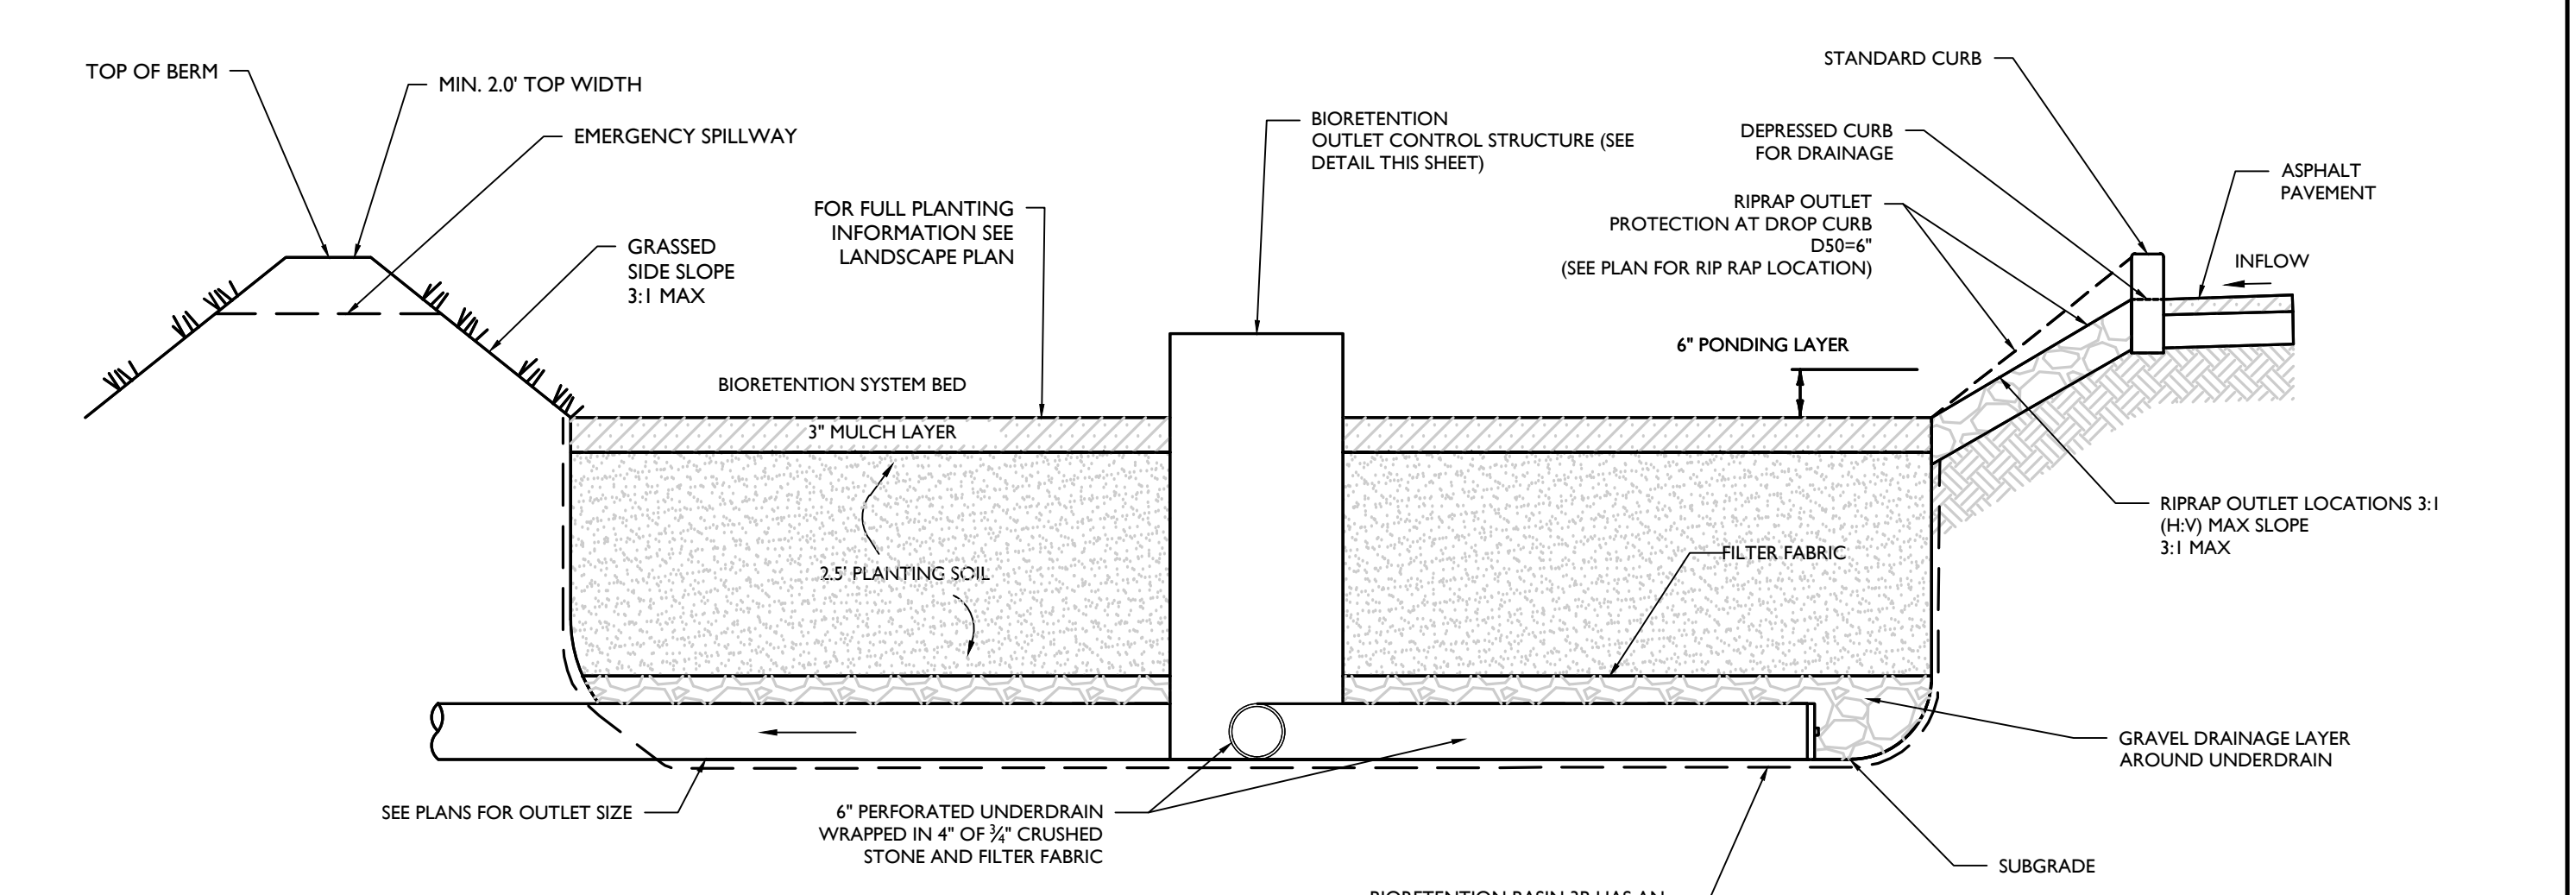


- NOTES:
1. SEE PLAN FOR DROP CURB LOCATIONS AND BIORETENTION AREA CONFIGURATION.
2. PLANTING SOIL TO BE IN ACCORDANCE WITH NEW YORK STATE STANDARDS AND SPECIFICATIONS FOUND WITHIN THE PROJECT SWPPP.

BIORETENTION SYSTEM CROSS SECTION DETAIL

NOTES:

- 1. REINFORCING IN THE "C" PORTION SHALL BE THE SAME AS SPECIFIED FOR CONCRETE PIPE ASTM C76 AND AASHTO M170 CLASS III FOR THE SIZE OF CONNECTING PIPE.
2. ALL CONCRETE SHALL BE 4000 PSI.
3. VARIATIONS IN MANUFACTURING DIMENSIONS SHALL BE AS CALLED FOR IN ASTM C76 AND AASHTO M170.
4. PIPE END SECTION CONNECTION SHALL MATCH JOINTS OF STANDARD PIPE DETAILS.

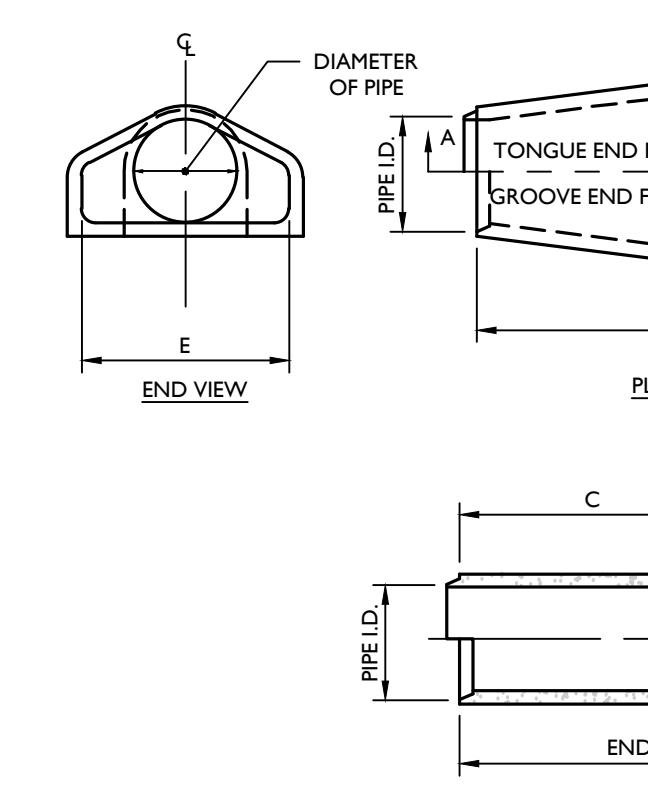


HDPE FLARED END SECTION DETAIL

PLANTING SOIL NOTE:

THE PLANTING SOIL SHOULD BE A SANDY LOAM, LOAMY SAND, LOAM (USDA), OR A LOAM/SAND MIX (SHOULD CONTAIN A MINIMUM 35 TO 60% SAND, BY VOLUME). THE CLAY CONTENT FOR THESE SOILS SHOULD BE LESS THAN 25% BY VOLUME. SOILS SHOULD FALL WITHIN THE SM, OR ML CLASSIFICATIONS OF THE UNIFIED SOIL CLASSIFICATION SYSTEM (USCS). A PERMEABILITY OF AT LEAST 1.0 FEET PER DAY (0.279 M) IS REQUIRED (A CONSERVATIVE VALUE OF 0.5 FEET PER DAY IS USED FOR DESIGN). THE SOIL SHOULD BE FREE OF STONES, STUMPS, ROOTS, OR OTHER WOODY MATERIAL OVER 1" IN DIAMETER, AND BRUSH OR SEED FROM NOXIOUS WEEDS. PLACEMENT OF THE PLANTING SOIL SHOULD BE IN LIFTS OF 12" TO 18" LOOSELY COMPACTED (TAMPED LIGHTLY WITH A DOZER OR BACKHOE BUCKET). THE SPECIFIC CHARACTERISTICS ARE AS FOLLOWS:

Table with 2 columns: PARAMETER and VALUE. Lists soil characteristics like PH RANGE (5.2 TO 7.00), ORGANIC MATTER (1.5 TO 4.0%), MAGNESIUM (35 LBS. PER ACRE, MINIMUM), PHOSPHORUS (P2O5) (75 LBS. PER ACRE, MINIMUM), POTASSIUM (K2O) (85 LBS. PER ACRE, MINIMUM), SOLUBLE SALTS (500 ppm), CLAY (10 TO 25%), SILT (30 TO 55%), SAND (35 TO 60%).

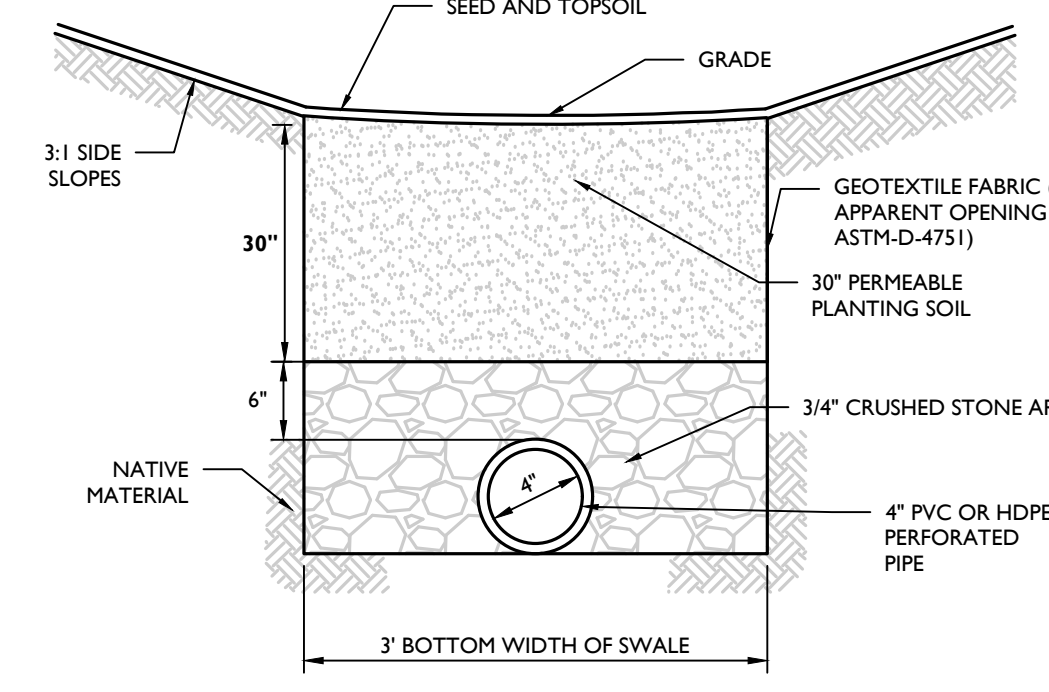


DRY SWALE DETAIL

- NOTES:
1. DRAINAGE SWALE TO HAVE A MAX. LONGITUDINAL SLOPE OF 2%.
2. PLANTING SOIL TO BE IN ACCORDANCE WITH NEW YORK STATE STANDARDS AND SPECIFICATIONS FOUND WITHIN THE PROJECT SWPPP.

NOTES:

- 1. SEE PLAN FOR DROP CURB LOCATIONS AND BIORETENTION AREA CONFIGURATION.
2. PLANTING SOIL TO BE IN ACCORDANCE WITH NEW YORK STATE STANDARDS AND SPECIFICATIONS FOUND WITHIN THE PROJECT SWPPP.

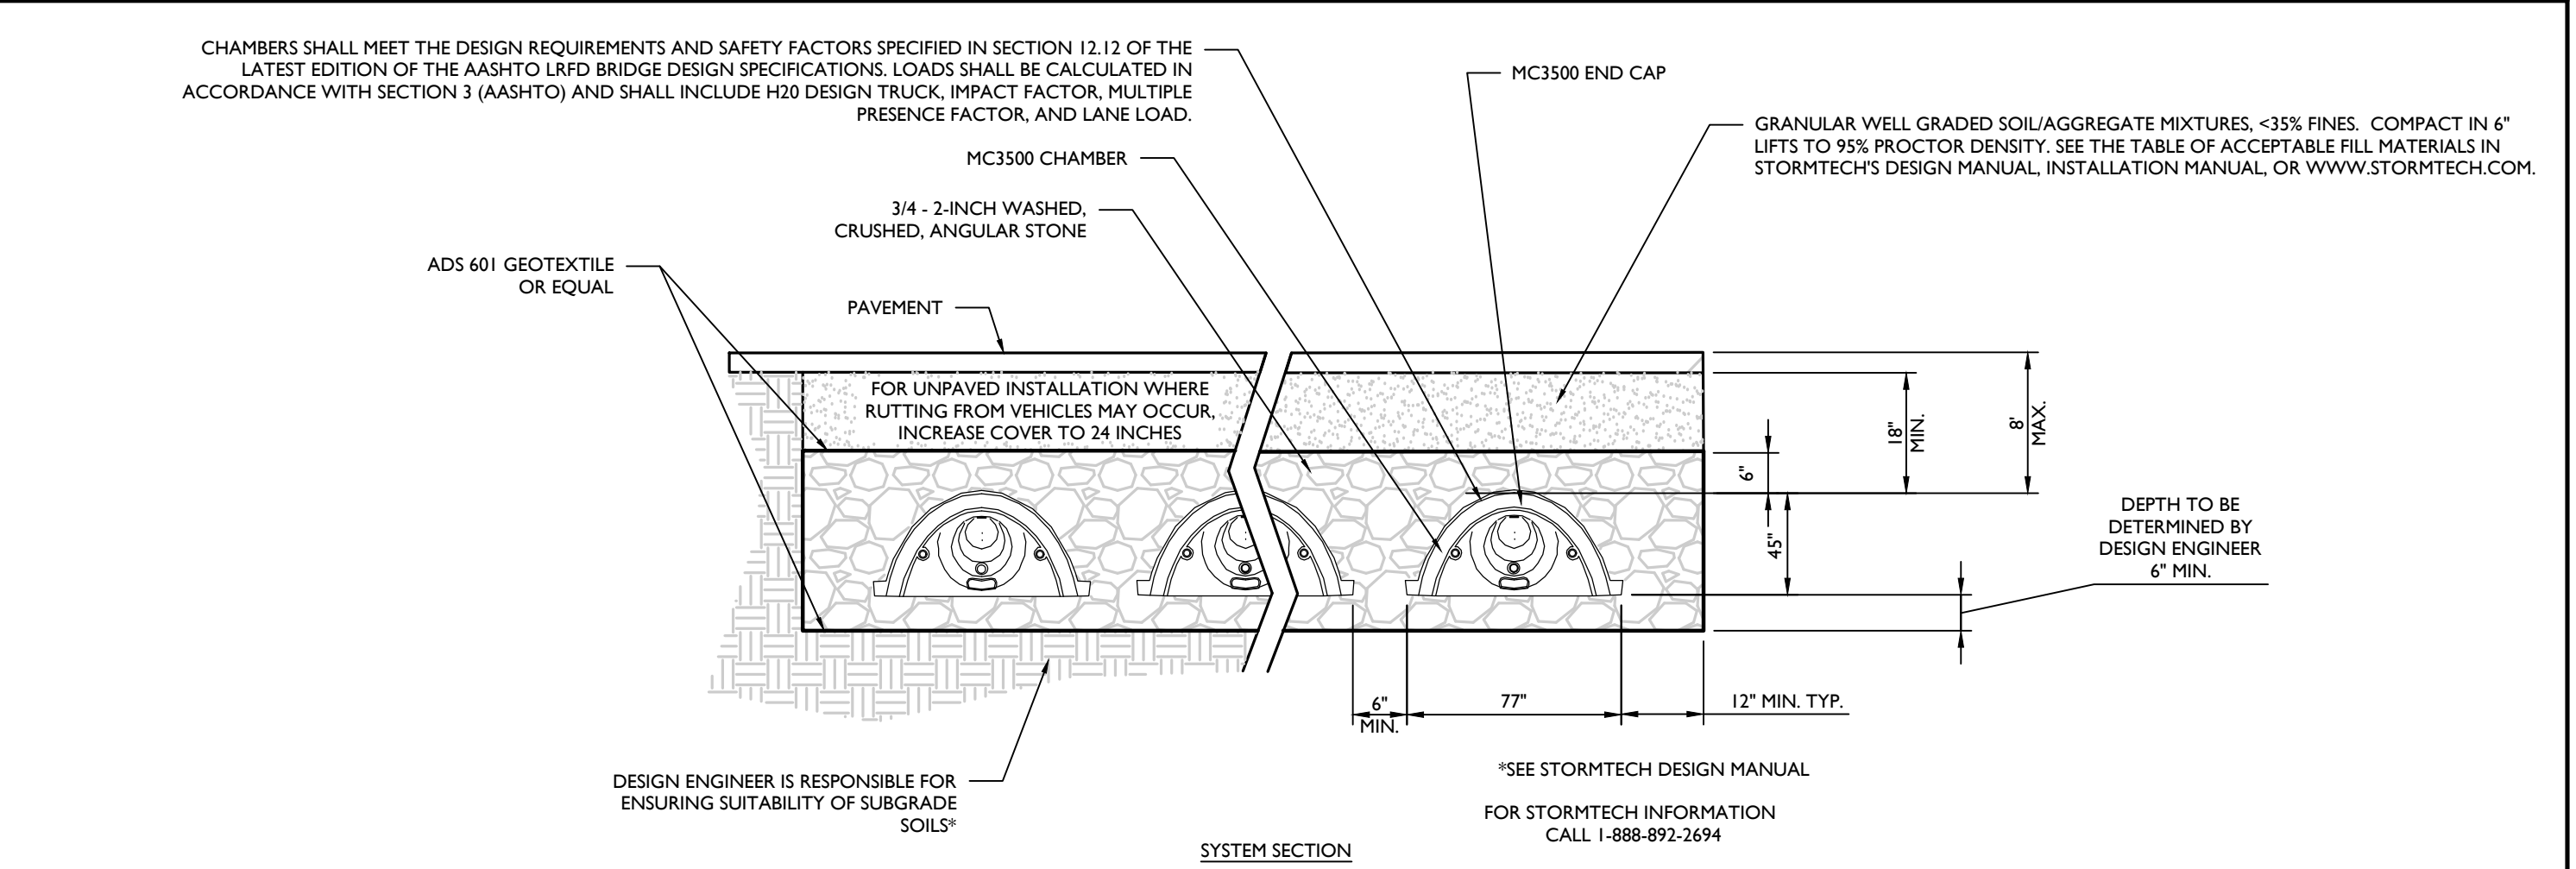


STORMTECH SC-740 STORM CHAMBER INSPECTION PORT DETAIL

- STORMTECH NOTES:
1. CHAMBERS SHALL BE STORMTECH MC3500.
2. CHAMBERS SHALL BE MADE FROM VIRGIN, IMPACT-MODIFIED POLYPROPYLENE COPOLYMERS.
3. CHAMBER ROWS SHALL PROVIDE CONTINUOUS, UNOBSTRUCTED INTERNAL SPACE WITH NO INTERNAL SUPPORT PANELS THAT WOULD IMPIDE FLOW.
4. THE STRUCTURAL DESIGN OF THE CHAMBERS, THE STRUCTURAL BACKFILL AND THE INSTALLATION REQUIREMENTS SHALL ENSURE THAT THE LOAD FACTORS SPECIFIED IN THE AASHTO LRFD BRIDGE DESIGN SPECIFICATIONS, SECTION 12.12 ARE MET FOR: 1) LONG-DURATION DEAD LOADS AND 2) SHORT-DURATION LIVE LOADS, BASED ON THE AASHTO DESIGN TRUCK WITH CONSIDERATION FOR IMPACT AND MULTIPLE VEHICLE PRESENCES.
5. ONLY CHAMBERS THAT ARE APPROVED BY THE ENGINEER WILL BE ALLOWED. THE CONTRACTOR SHALL SUBMIT (1 SETS) OF THE FOLLOWING TO THE ENGINEER FOR APPROVAL BEFORE DELIVERING CHAMBERS TO THE PROJECT SITE:
- A STRUCTURAL EVALUATION BY A REGISTERED STRUCTURAL ENGINEER THAT DEMONSTRATES THAT THE LOAD FACTORS SPECIFIED IN THE AASHTO LRFD BRIDGE DESIGN SPECIFICATIONS, SECTION 12.12 ARE MET.
- STRUCTURAL CROSS SECTION DETAIL ON WHICH THE STRUCTURAL CROSS SECTION IS BASED.
6. THE INSTALLATION OF CHAMBERS SHALL BE IN ACCORDANCE WITH THE MANUFACTURER'S LATEST INSTALLATION INSTRUCTIONS.
7. THE STONE USED FOR FILLING THE SUBSURFACE SYSTEM MUST BE CLEAN WASHED STONE FREE OF ALL SEDIMENT, FINES, AND DUST. THE CONTRACTOR MAY BE REQUIRED TO WASH THE STONE ON SITE UNTIL IT IS CLEAN TO THE TOUCH LEAVING NO RESIDUE BEHIND PRIOR TO PLACEMENT IN THE SYSTEM FOOTPRINT.
8. THE PROPOSED SUBSURFACE STORMWATER SYSTEM BOTTOM MUST BE PROTECTED FROM STORMWATER OUF AT ALL TIMES DURING CONSTRUCTION. THE CONTRACTOR IS RESPONSIBLE FOR ENSURING THE INFILTRATION CAPACITY OF THE VIRGIN SOIL IS NOT COMPROMISED.
9. VEHICLE TRAFFIC MUST AVOID THE SUBSURFACE SYSTEM FOOTPRINT DURING CONSTRUCTION.

STORMTECH SUBSURFACE DETAIL

NOTES:


- 1. ALL PIPE SYSTEMS AND BACKFILL SHALL BE INSTALLED IN ACCORDANCE WITH ASTM D3231.
2. MINIMUM COVER FOR HDPE PIPES IS 12" UP TO 48" DIAMETER PIPE AND 34" OF COVER FOR UP TO 60" DIAMETER PIPE. PIPE COVER IS MEASURED FROM TOP OF PIPE TO THE BOTTOM OF FLEXIBLE PAVEMENT, OR TO THE TOP OF RIGID PAVEMENT, OR TO THE GROUND SURFACE.
3. MINIMUM TRENCH WIDTH PER MANUFACTURER'S RECOMMENDATIONS.

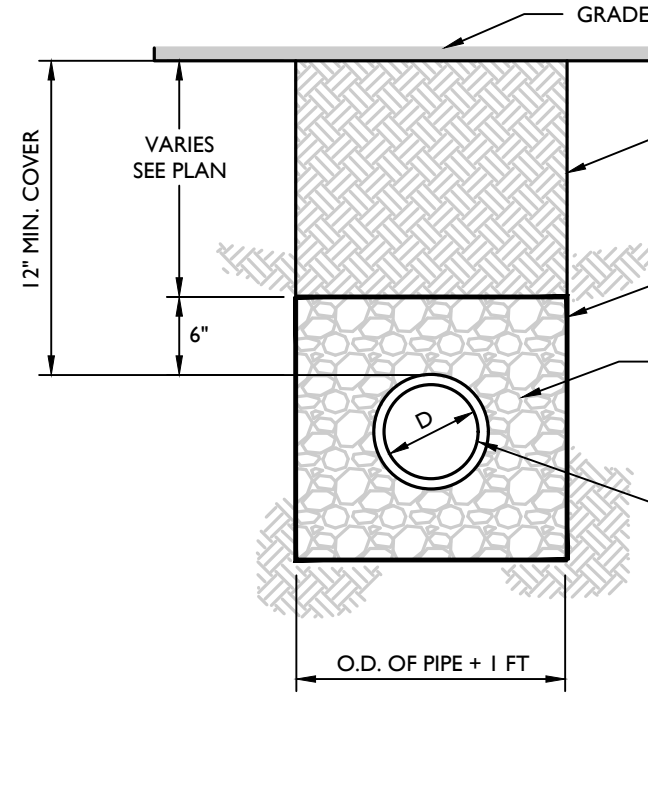

UNDERDRAIN DETAIL

NOTES:

- 1. ALL PIPE SYSTEMS AND BACKFILL SHALL BE INSTALLED IN ACCORDANCE WITH ASTM D3231.
2. MINIMUM COVER FOR HDPE PIPES IS 12" UP TO 48" DIAMETER PIPE AND 34" OF COVER FOR UP TO 60" DIAMETER PIPE. PIPE COVER IS MEASURED FROM TOP OF PIPE TO THE BOTTOM OF FLEXIBLE PAVEMENT, OR TO THE TOP OF RIGID PAVEMENT, OR TO THE GROUND SURFACE.
3. MINIMUM TRENCH WIDTH PER MANUFACTURER'S RECOMMENDATIONS.

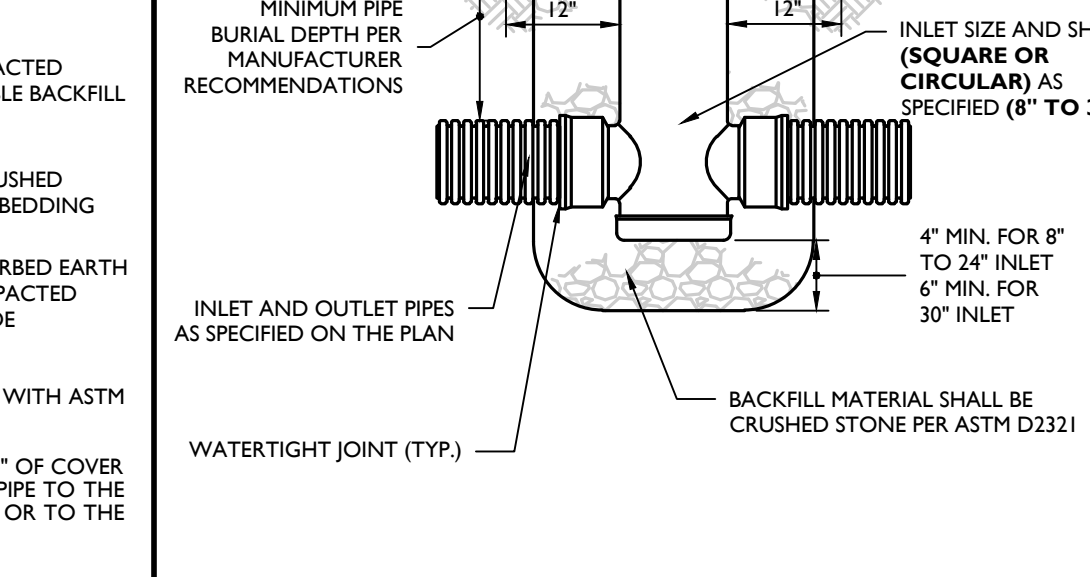

ROOF LEADER CLEANOUT DETAIL

NOTES:

- 1. ALL PIPE SYSTEMS AND BACKFILL SHALL BE INSTALLED IN ACCORDANCE WITH ASTM D3231.
2. MINIMUM COVER FOR HDPE PIPES IS 12" UP TO 48" DIAMETER PIPE AND 34" OF COVER FOR UP TO 60" DIAMETER PIPE. PIPE COVER IS MEASURED FROM TOP OF PIPE TO THE BOTTOM OF FLEXIBLE PAVEMENT, OR TO THE TOP OF RIGID PAVEMENT, OR TO THE GROUND SURFACE.
3. MINIMUM TRENCH WIDTH PER MANUFACTURER'S RECOMMENDATIONS.



YARD DRAIN (NYLOPLAST) DETAIL

NOTES:

- 1. ALL PIPE SYSTEMS AND BACKFILL SHALL BE INSTALLED IN ACCORDANCE WITH ASTM D3231.
2. MINIMUM COVER FOR HDPE PIPES IS 12" UP TO 48" DIAMETER PIPE AND 34" OF COVER FOR UP TO 60" DIAMETER PIPE. PIPE COVER IS MEASURED FROM TOP OF PIPE TO THE BOTTOM OF FLEXIBLE PAVEMENT, OR TO THE TOP OF RIGID PAVEMENT, OR TO THE GROUND SURFACE.
3. MINIMUM TRENCH WIDTH PER MANUFACTURER'S RECOMMENDATIONS.



HDPE STORM PIPE BEDDING DETAIL

Colliers Engineering & Design logo and contact information including website and phone number.

MASER logo and contact information for doing business as.

811 logo and information about utility locating services.

Table with 3 columns: REV, DATE, DESCRIPTION. Lists revision history for the drawing.

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Professional seal and signature of Justin Eric Dates, a registered landscape architect in New York State.

JUSTIN ERIC DATES
NEW YORK REGISTERED LANDSCAPE ARCHITECT
LICENSE NUMBER: 001964-01
COLLIERS ENGINEERING & DESIGN CT, P.C.

SITE PLAN
FOR
RDM GROUP 1081
DOLSONTOWN ROAD

TAX LOTS:
6-1-1
TOWN OF WAWAYANDA
ORANGE COUNTY
NEW YORK STATE

Colliers Engineering & Design logo and contact information.

Table with 4 columns: SCALE, DATE, DRAWN BY, CHECKED BY. Lists project details.

TOWN OF WAWAYANDA
PLANNING BOARD

CONSTRUCTION DETAILS
16 of 17

