




DAMIAN
FARRELL
DESIGN
GROUP

359 METTY DRIVE, SUITE 4A
ANN ARBOR, MI 48103
tel: 734.998.1331

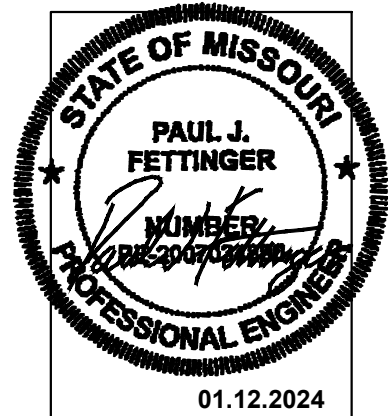

FOR PERMIT ISSUE


C3 - BRANSON MO
3125 GREEN MOUNTAIN DRIVE
BRANSON, MO 65616

| DATE | DESCRIPTION |
|------------|-------------|
| 12.28.2023 | REVIEW SET |
| 01.12.2024 | PERMIT SET |

| | |
|-----------------|--------------|
| CHECKED | DJQ/PJF |
| DRAWN | BJK |
| HEI PROJECT NO. | R23-4590.006 |

MEZZANINE LEVEL
MECHANICAL
EQUIPMENT PLAN

E2.3

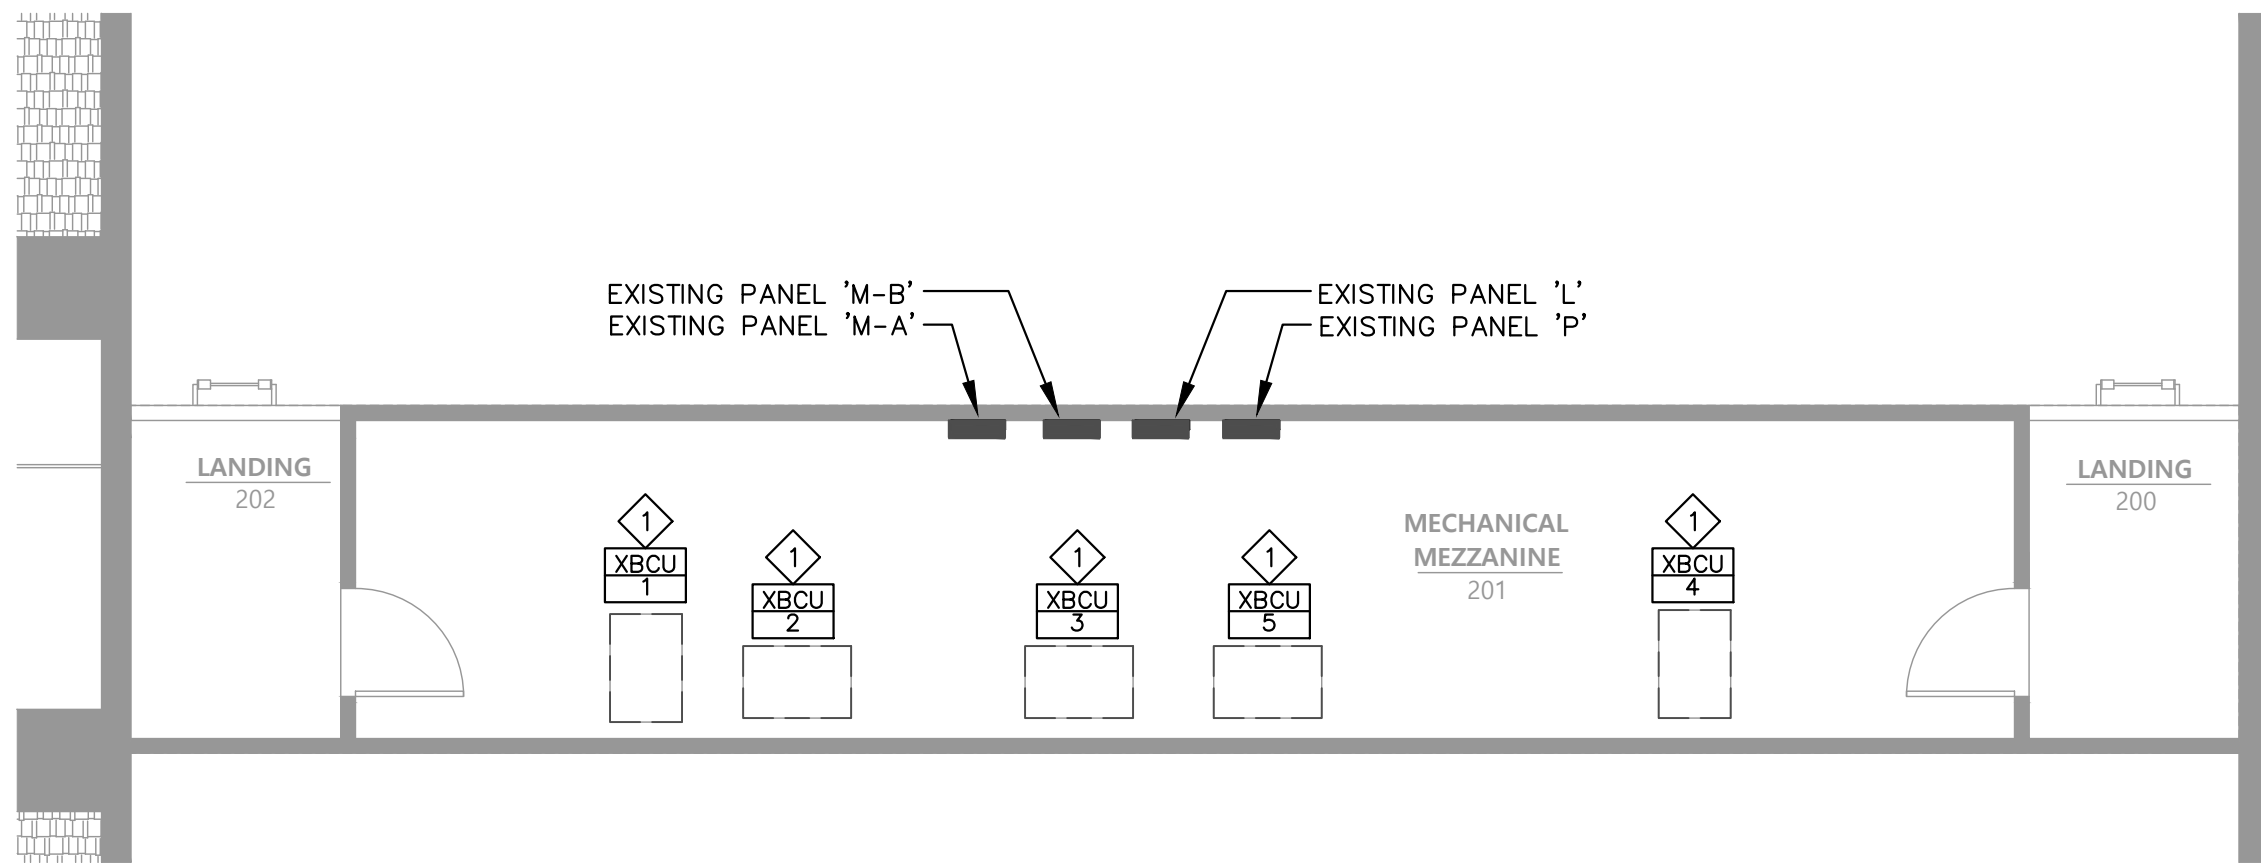

MEZZANINE LEVEL MECHANICAL EQUIPMENT POWER PLAN

1


3/16" = 1'-0"

KEY NOTES

- MECHANICAL EQUIPMENT. REFER TO MECHANICAL EQUIPMENT SCHEDULE ON SHEET E0.0 FOR ADDITIONAL INFORMATION.
- NOT USED.
- WEATHER PROOF, GFCI DUPLEX CONVENIENCE RECEPTACLE PROVIDED WITH UNIT. CONNECT TO 120V CIRCUIT AS INDICATED ON THE PLAN.
- PROVIDE DUPLEX RECEPTACLE, PORCELAIN LAMP HOLDER WITH PULL CHAIN, AND LED LIGHT BULB AT/ADJACENT TO FAN COIL UNIT.

GENERAL NOTES

- CONTRACTOR SHALL COMPLETELY REMOVE ALL EQUIPMENT, PANELBOARDS, DEVICES, FIXTURES, WIRING, CONDUIT, ETC. AND ALL ASSOCIATED SUPPORTS, BRACING, PADS, ETC. NOT BEING REUSED OR SHOWN TO REMAIN WHETHER IN THE DEMISED SPACE, ON THE ROOF OR OTHERWISE LOCATED OUTSIDE OF THE DEMISED SPACE. DO NOT ABANDON IN PLACE.
- ALL 120 VOLT BRANCH CIRCUITS IN EXCESS OF 75' SHALL HAVE CONDUCTOR SIZE INCREASED A MINIMUM OF 1 CONDUCTOR SIZE. INSTALLING CONTRACTOR SHALL DETERMINE ACTUAL CONDUCTOR SIZE TO BE INSTALLED TO ADHERE TO VOLTAGE DROP REQUIREMENTS.
- PROVIDE A NEUTRAL CONDUCTOR FOR EACH BRANCH CIRCUIT. NEUTRAL SHARING IS NOT ALLOWED. PROVIDE MULTI-BREAKER AS ALTERNATE PER NEC REQUIREMENT.
- ELECTRICAL SYSTEM SHALL BE GROUNDED AND BONDED PER NEC REQUIREMENTS AND AUTHORITY HAVING JURISDICTION.
- COORDINATE COLOR OF RECEPTACLES AND COVER PLATES WITH ARCHITECT.
- IT IS THE RESPONSIBILITY OF THE CONTRACTOR TO NOTIFY THE ARCHITECT, LANDLORD OR OWNER OF ANY DISCREPANCIES ENCOUNTERED ON THE PLANS OR IN EXISTING CONDITIONS PRIOR TO COMMENCEMENT OF WORK.

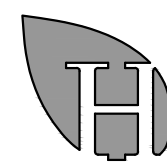

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