

LOCATION MAP


SCALE: 1"=2000'

No.	DATE	DESCRIPTION
2	04/03/20	REVISED PER MHE COMMENTS 03/10/2020
3	06/05/20	REVISED PER MHE COMMENTS 04/28/2020
4	03/03/21	REVISED PER MHE SWPPP COMMENTS 02/19/21
5	03/16/21	REVISED PER MHE SWPPP COMMENTS 03/12/21
6	04/12/21	REVISED BIO-RETENTION DETAIL
7	04/21/21	REVISED PER MHE COMMENTS
8	05/10/21	REVISED PER MHE COMMENTS
9	06/21/21	REVISED FOR OUTSIDE AGENCY SUBMISSION
10	09/17/21	REVISED PER OUTSIDE AGENCY COMMENTS
11	10/12/21	REVISED PER MHE COMMENTS
12	11/08/21	REVISED PER ACOE COMMENTS
13	11/23/21	REVISED PER ACOE COMMENTS
14	12/14/21	REVISED PER OCDOH COMMENTS
15	02/22/22	REVISED PER OCDOH COMMENTS
16	07/11/22	REVISED PER MHE COMMENTS
17	08/10/22	REVISED PER MHE COMMENTS
18	08/24/22	REVISED PER MHE COMMENTS
19	01/18/23	REVISED HEADWALL
20	01/27/23	REVISED UTILITIES
21	05/08/23	REVISED PER NEW BUILDING LAYOUT

DRAWING STATUS	ISSUE DATE: 05/08/2023		
THIS SHEET IS PART OF THE PLAN SET ISSUED FOR	SHEET NUMBER		
CONCEPT APPROVAL	N/A	OF	N/A
☑PLANNING BOARD APPROVAL	1	OF	22
OCDOH REALTY SUBDIVISION APPROVAL	N/A	OF	N/A
OCDOH WATERMAIN EXTENSION APPROVAL	1	OF	9
NYSDEC APPROVAL	1	OF	22
□NYSDOT APPROVAL	N/A	OF	N/A
OTHER	N/A	OF	2
☐FOR BID	N/A	OF	N/A
FOR CONSTRUCTION	N/A	OF	N/A
THIS PLAN SET HAS BEEN ISSUED SPECIFICALLY FOR THE APPROVAL OR ACTION NOTED ABOVE AND SHALL NOT BE USED			

FOR ANY OTHER PURPOSE. THIS SHEET SHALL BE CONSIDERED INVALID UNLESS

ACCOMPANIED BY ALL SHEETS OF THE DENOTED PLAN SET(S).

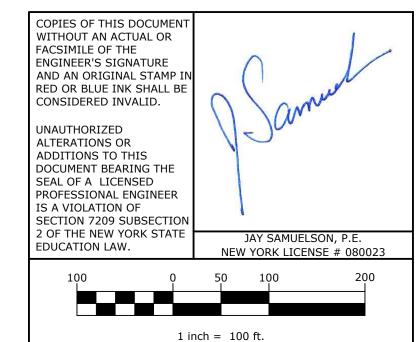



71 CLINTON STREET MONTGOMERY, NY 12549 Ph: (845) 457-7727 WWW.EP-PC.COM


OVERALL SITE PLAN


599 E. MAIN ST. - RDM WAREHOUSE (LOT 2) 599 EAST MAIN STREET TOWN OF WALLKILL


ORANGE COUNTY, NEW YORK 980.1504


1"=100' **C-100**


TOWN OF WALLKILL PB SHEET 1 OF 27

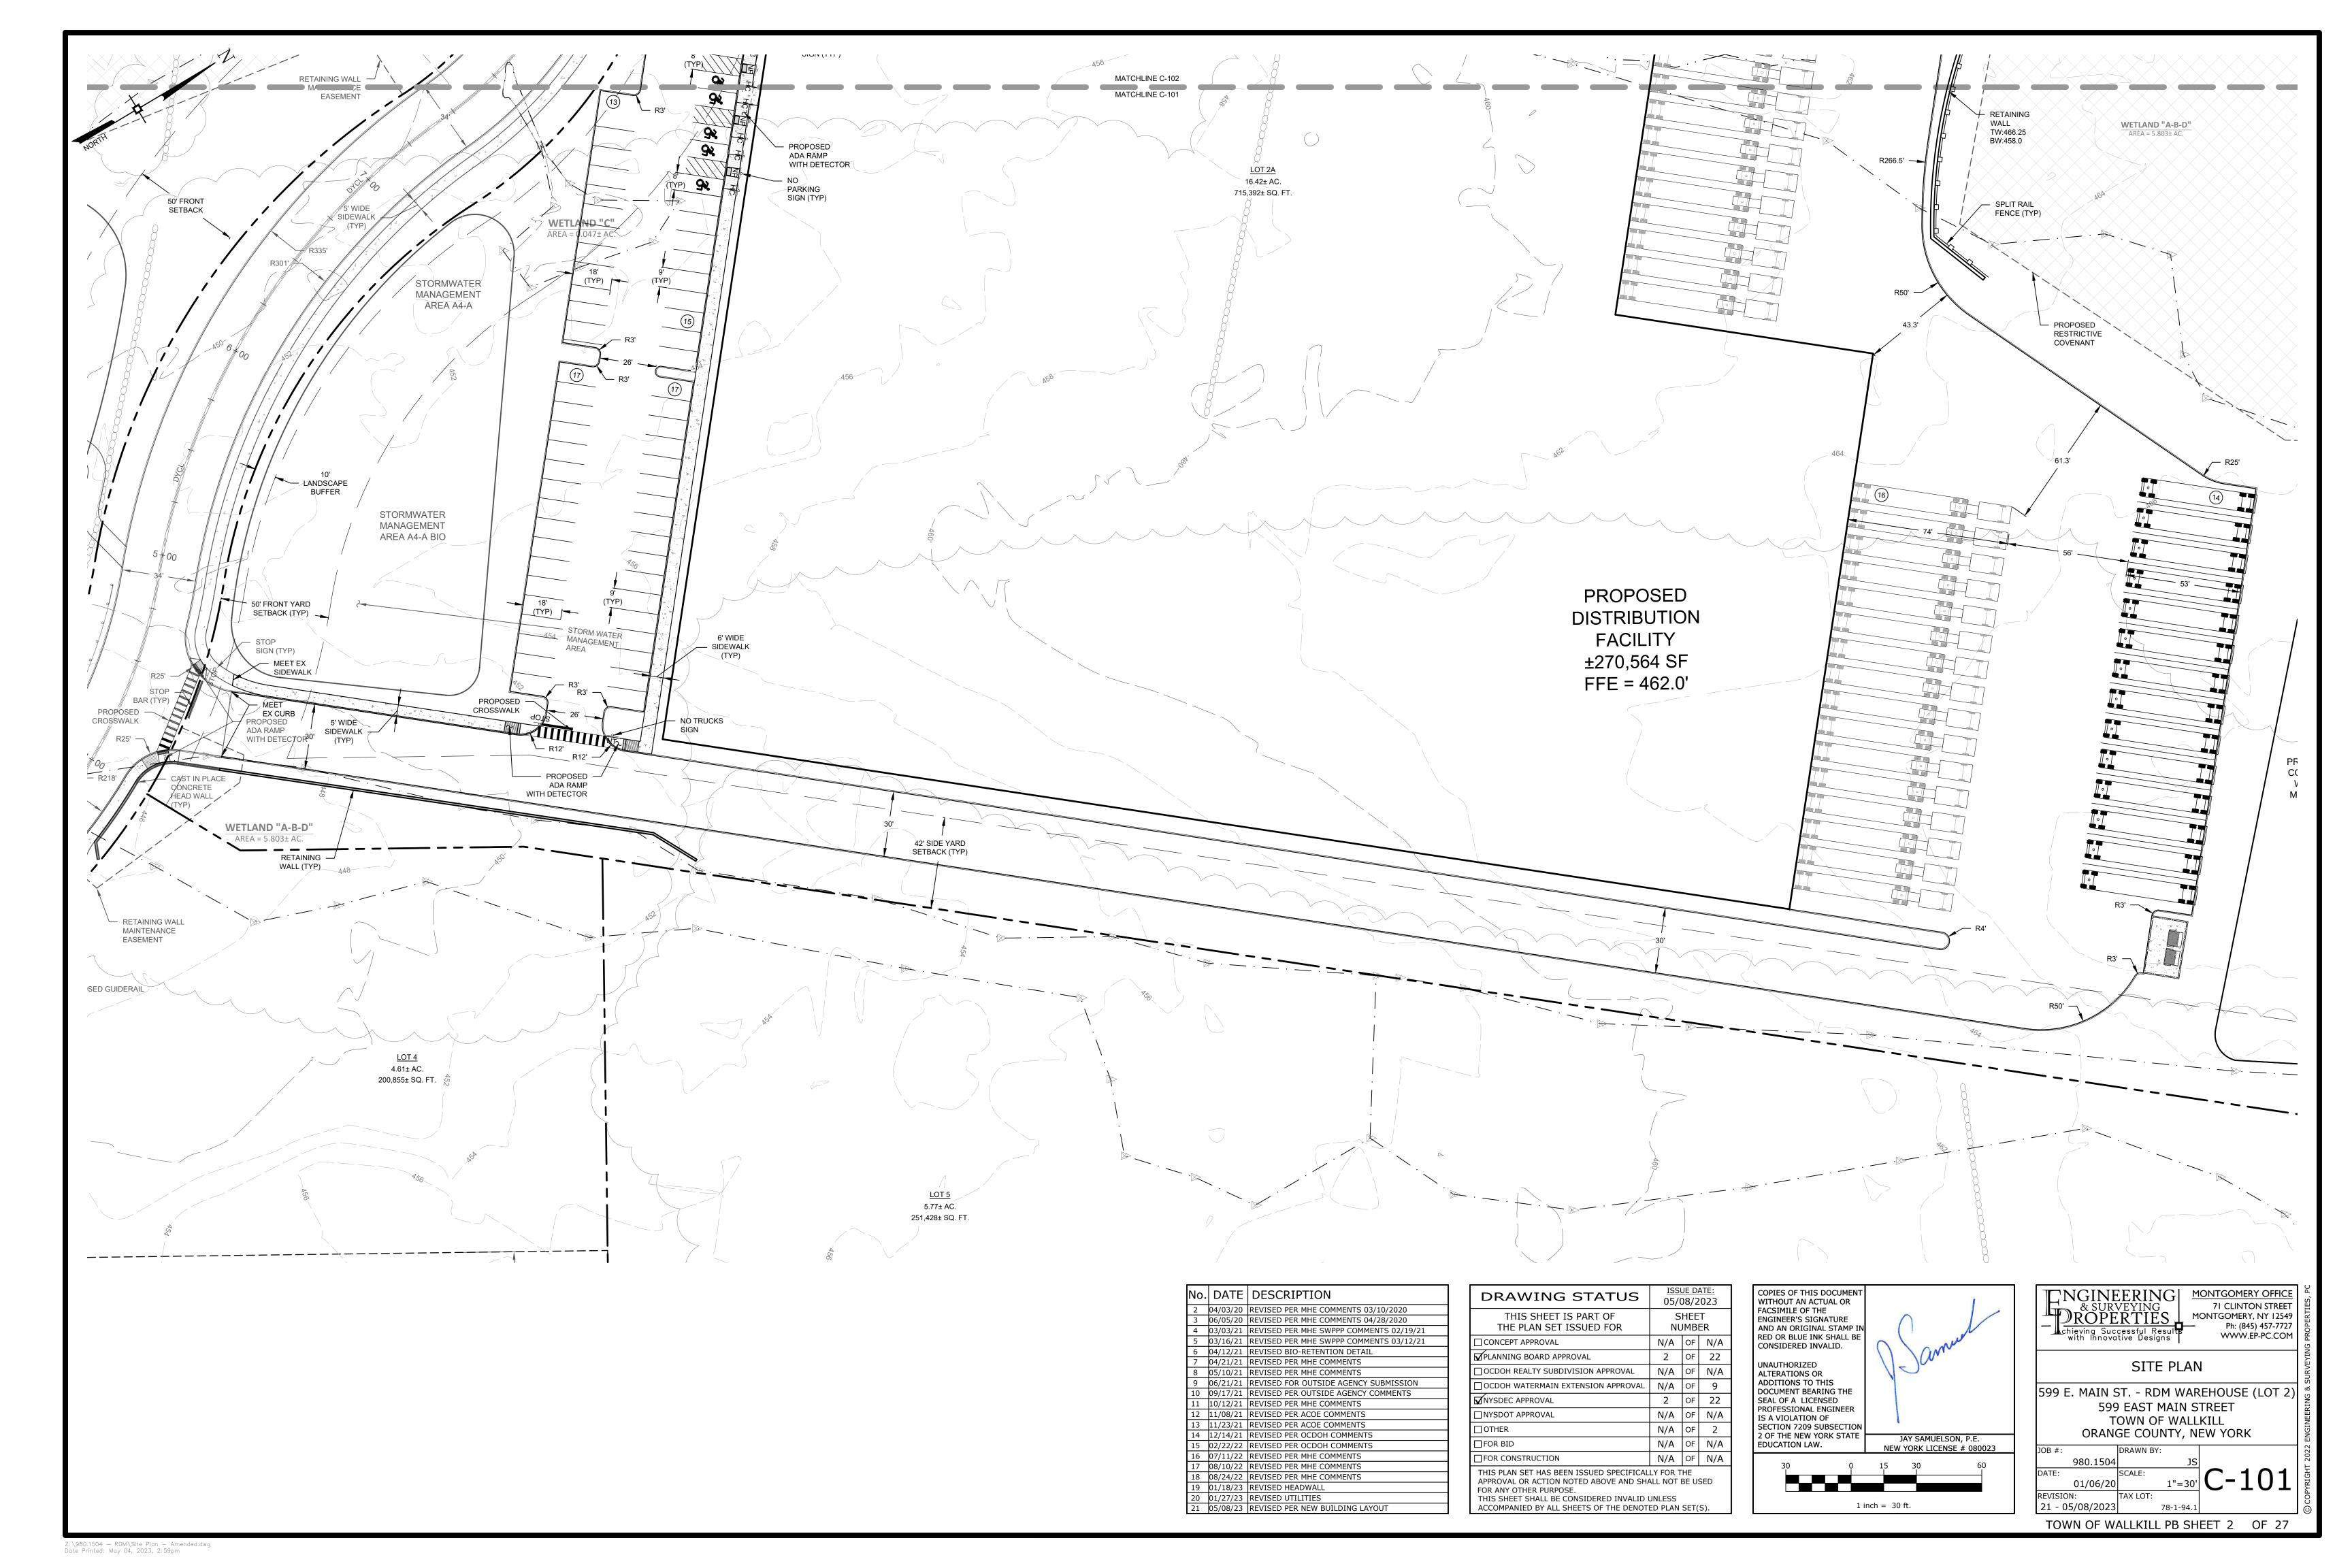


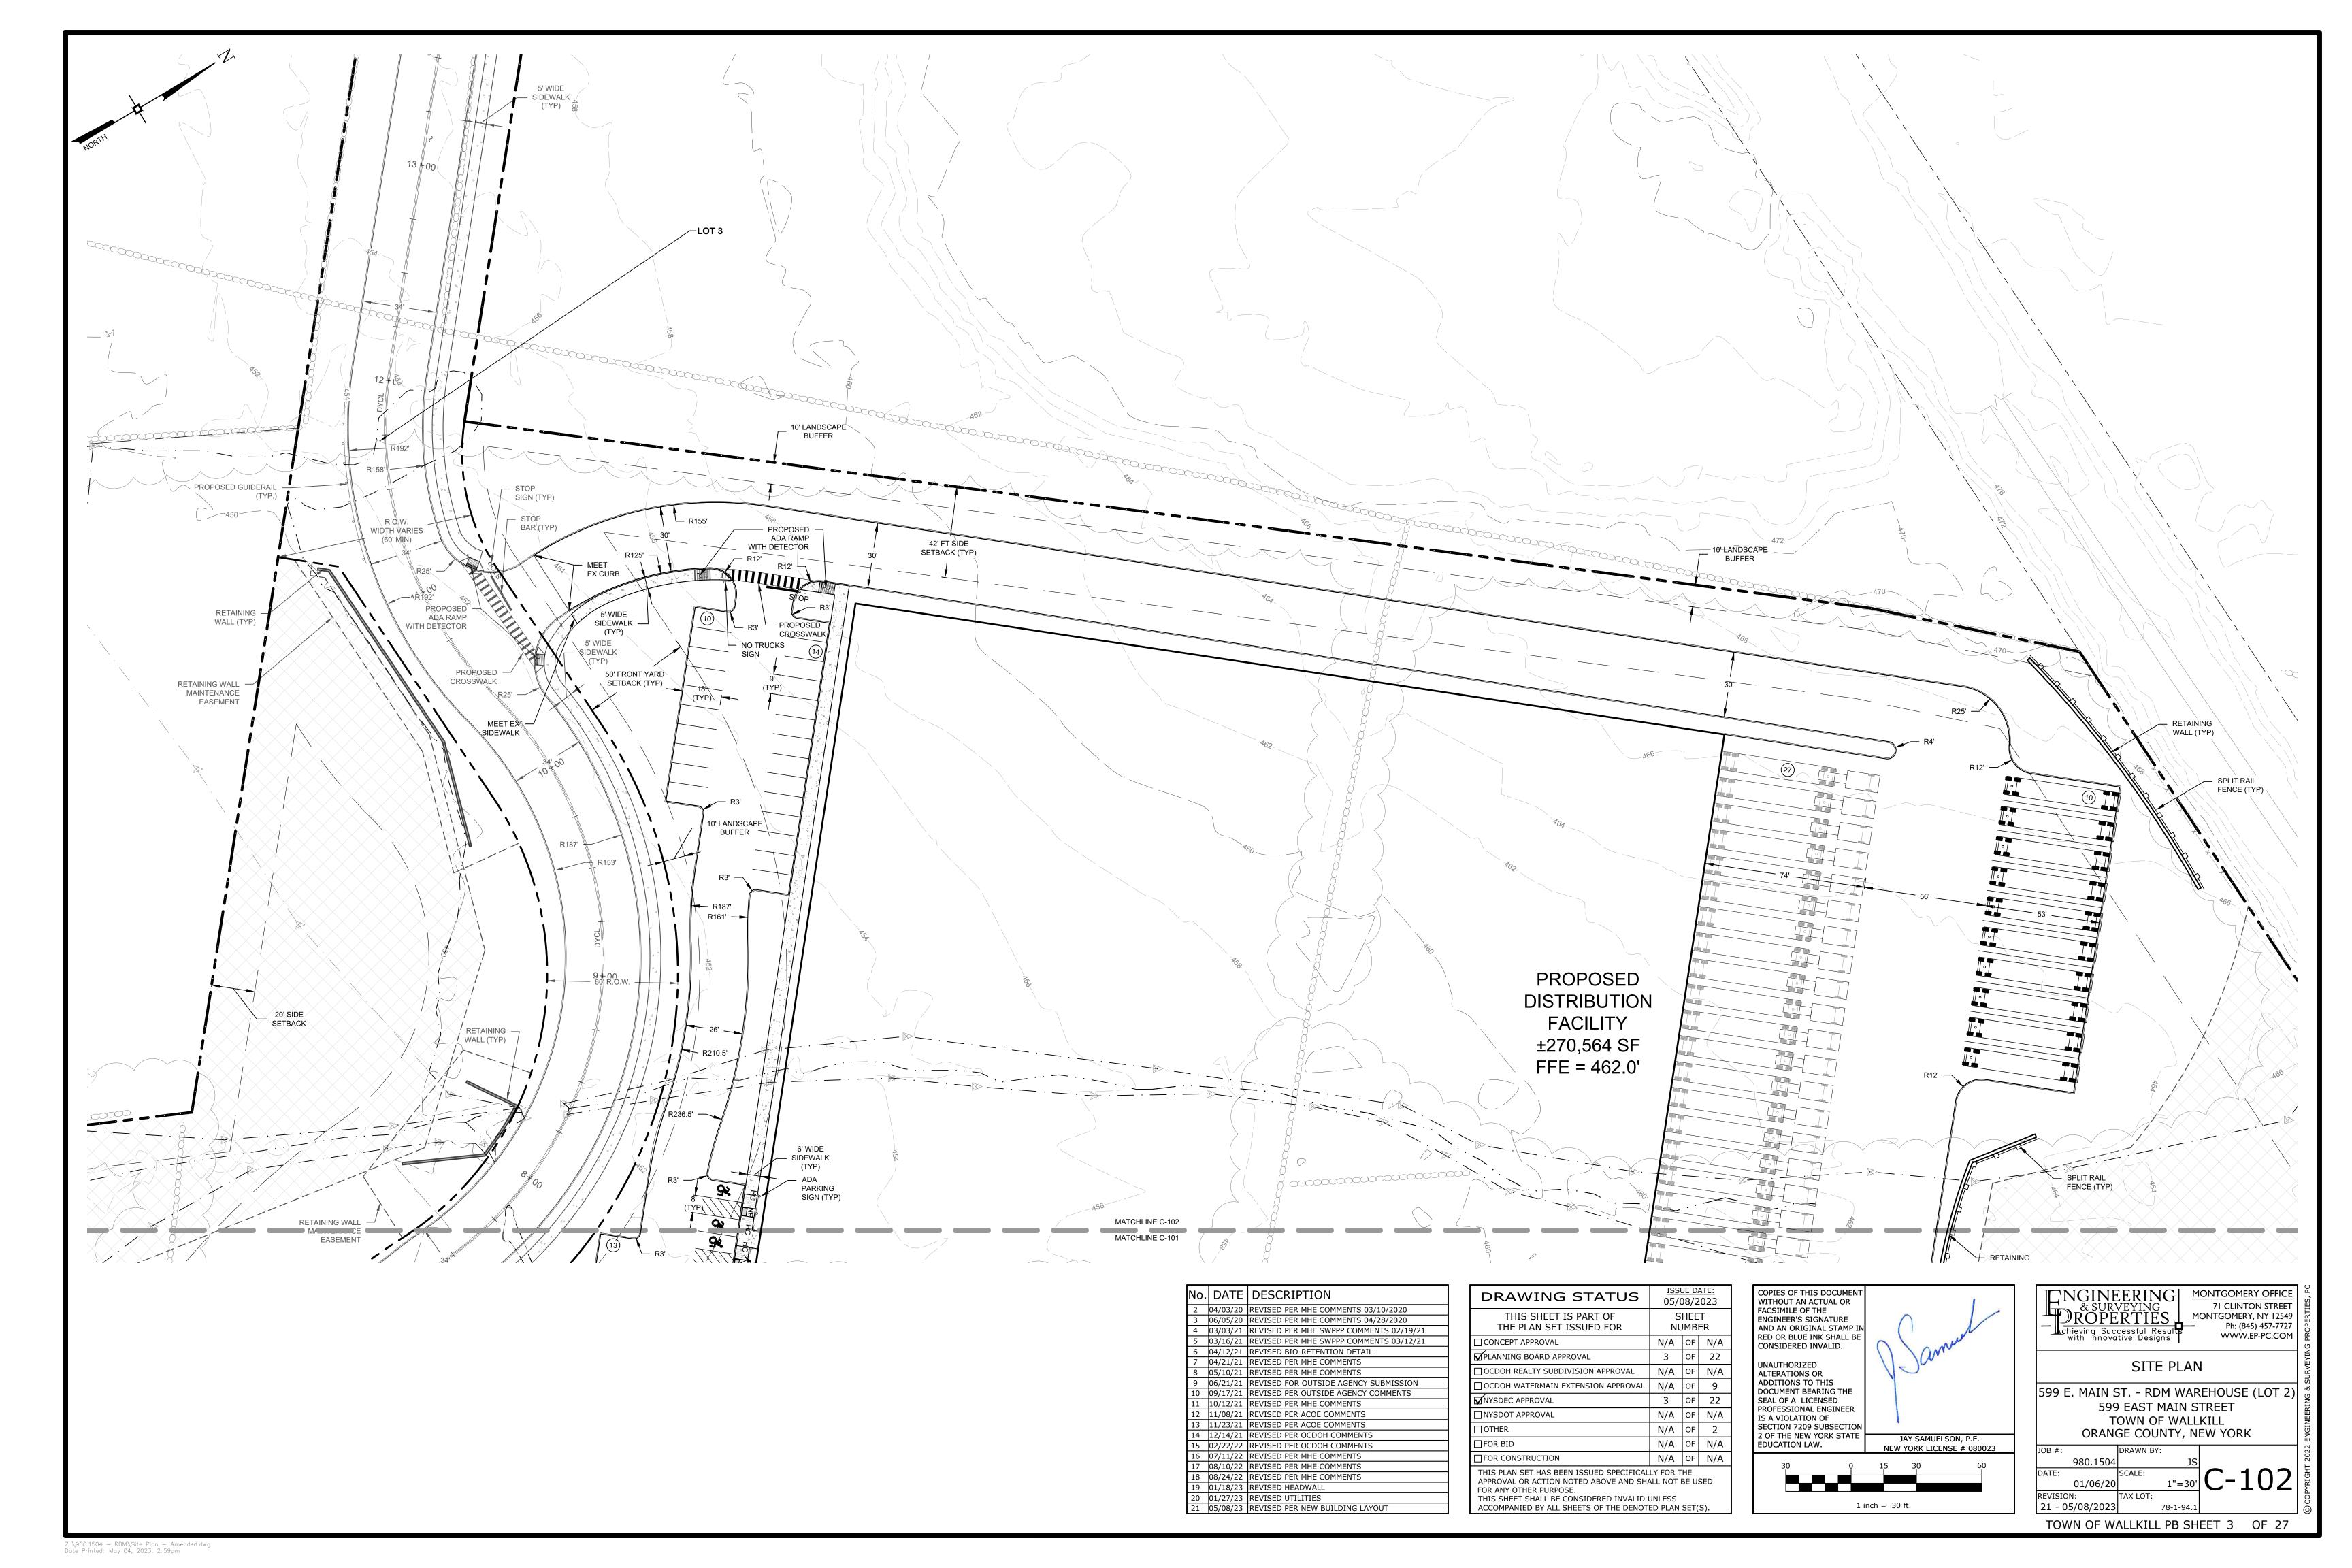


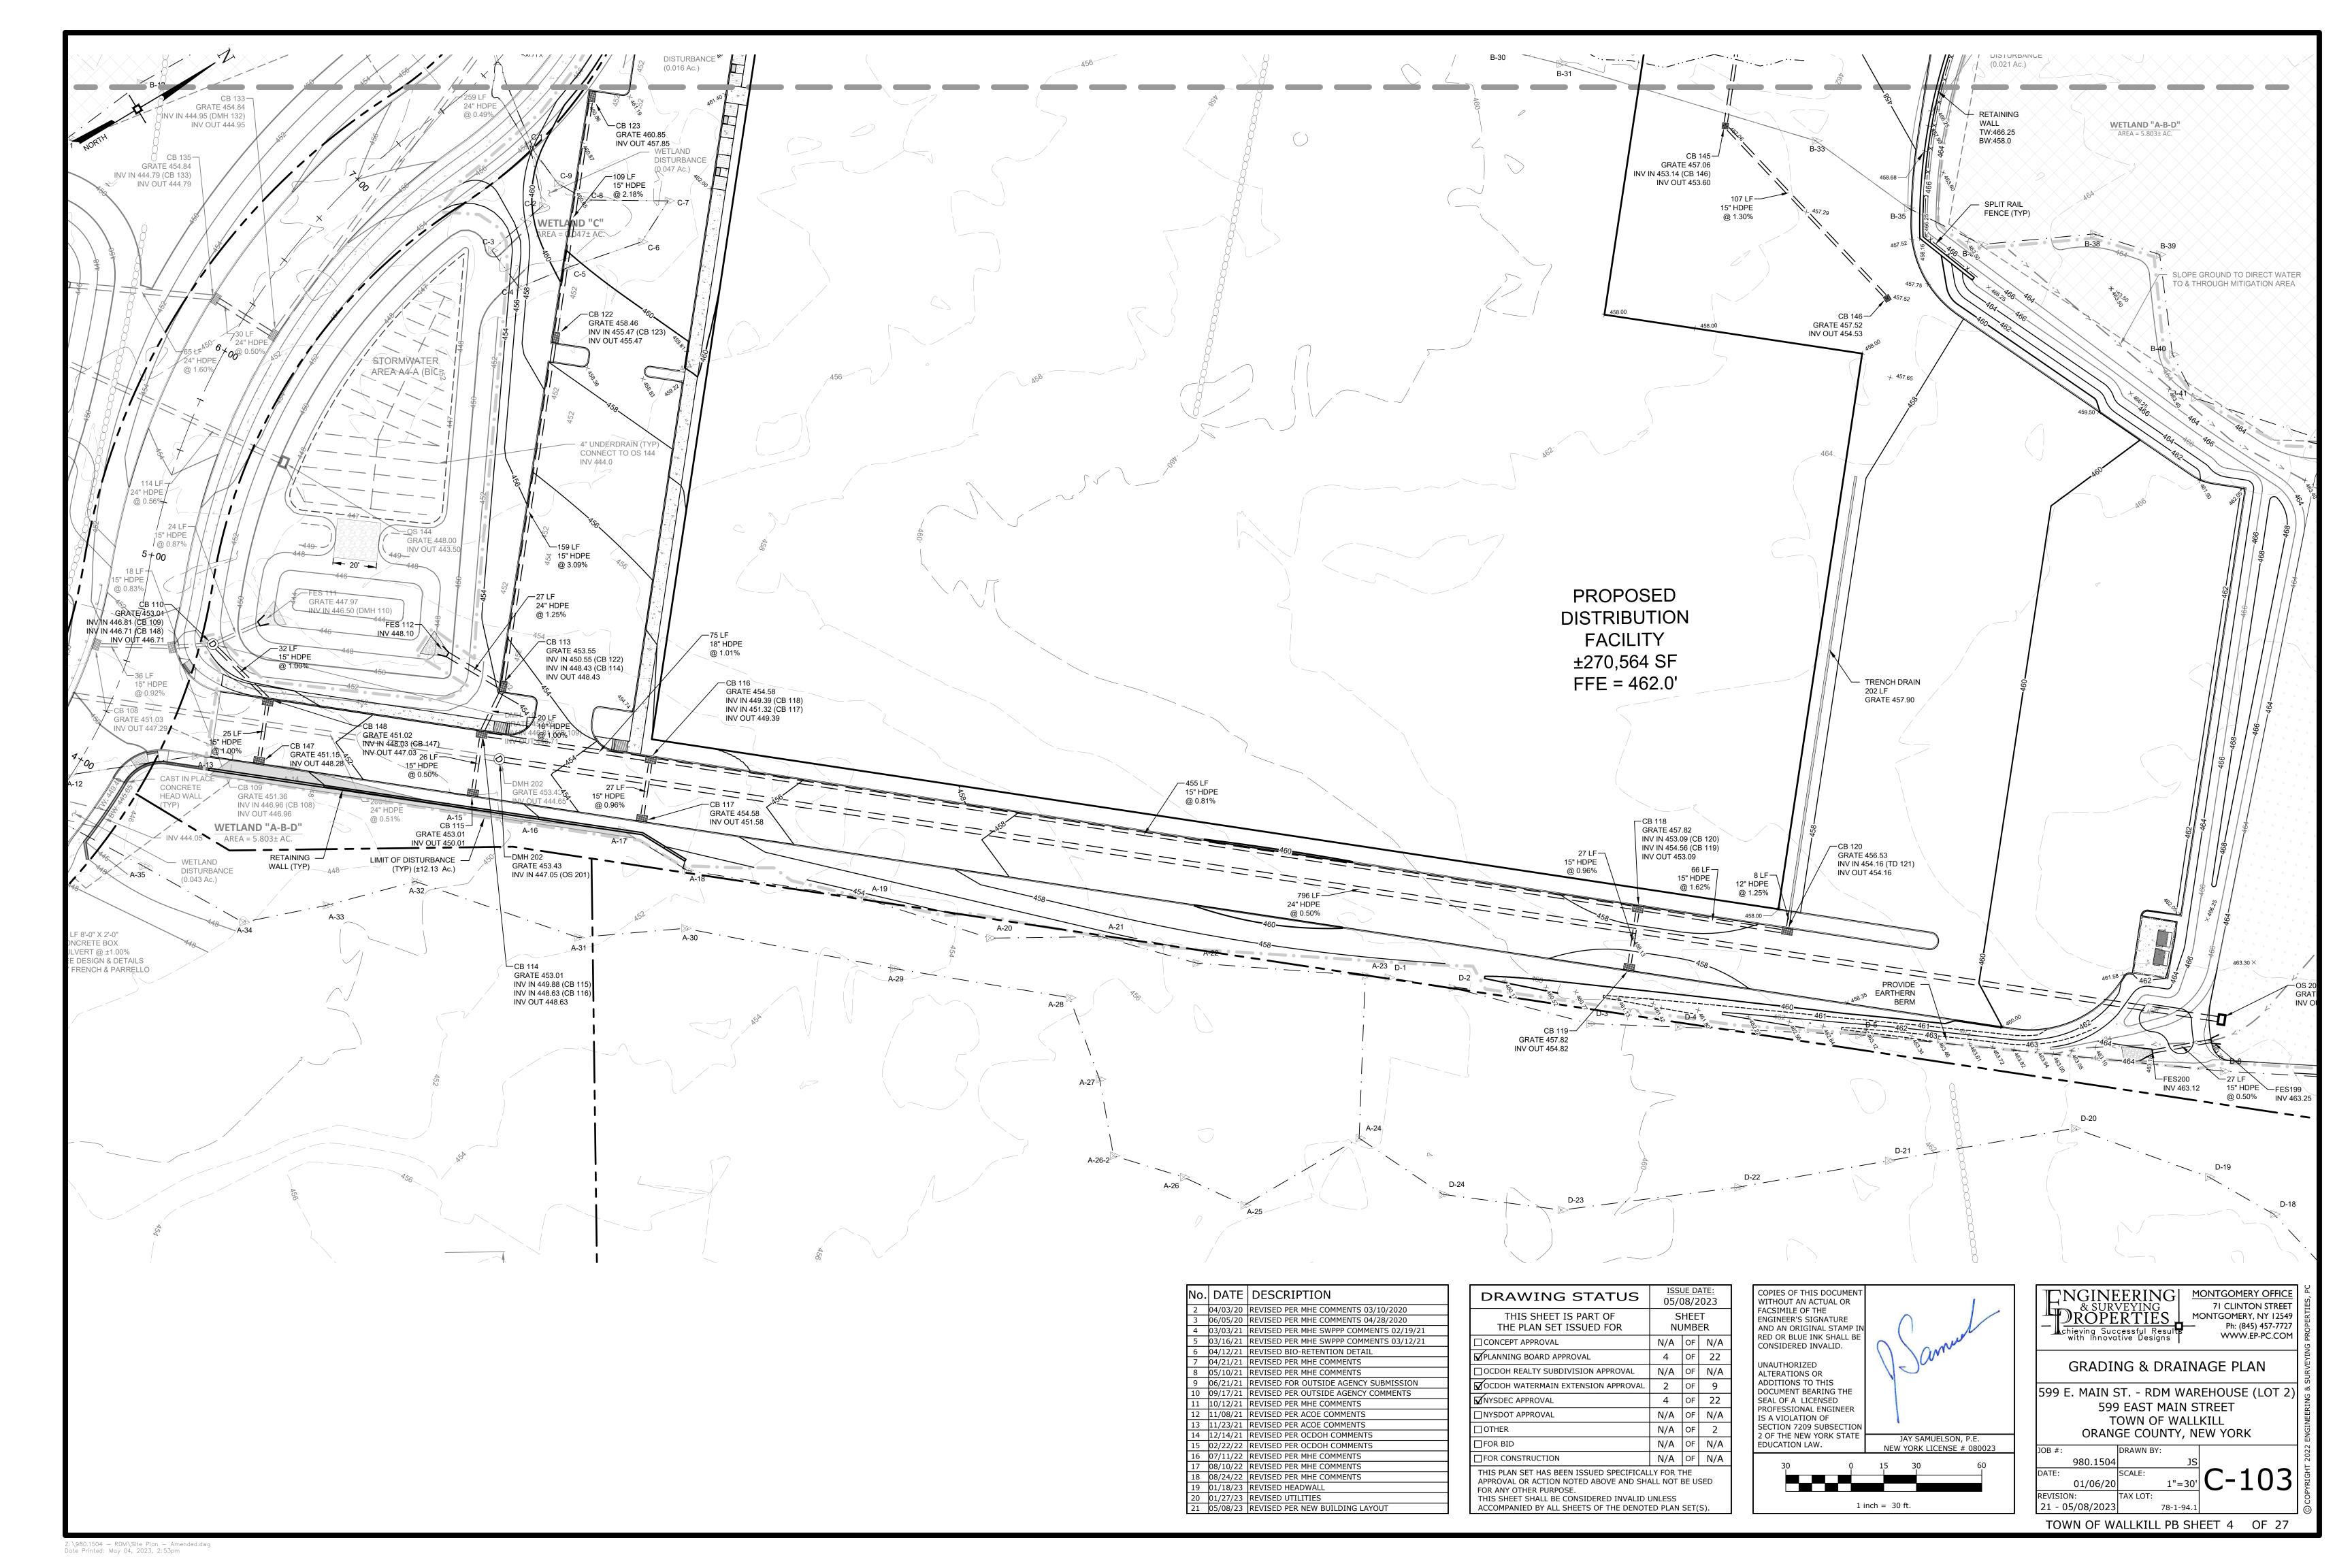


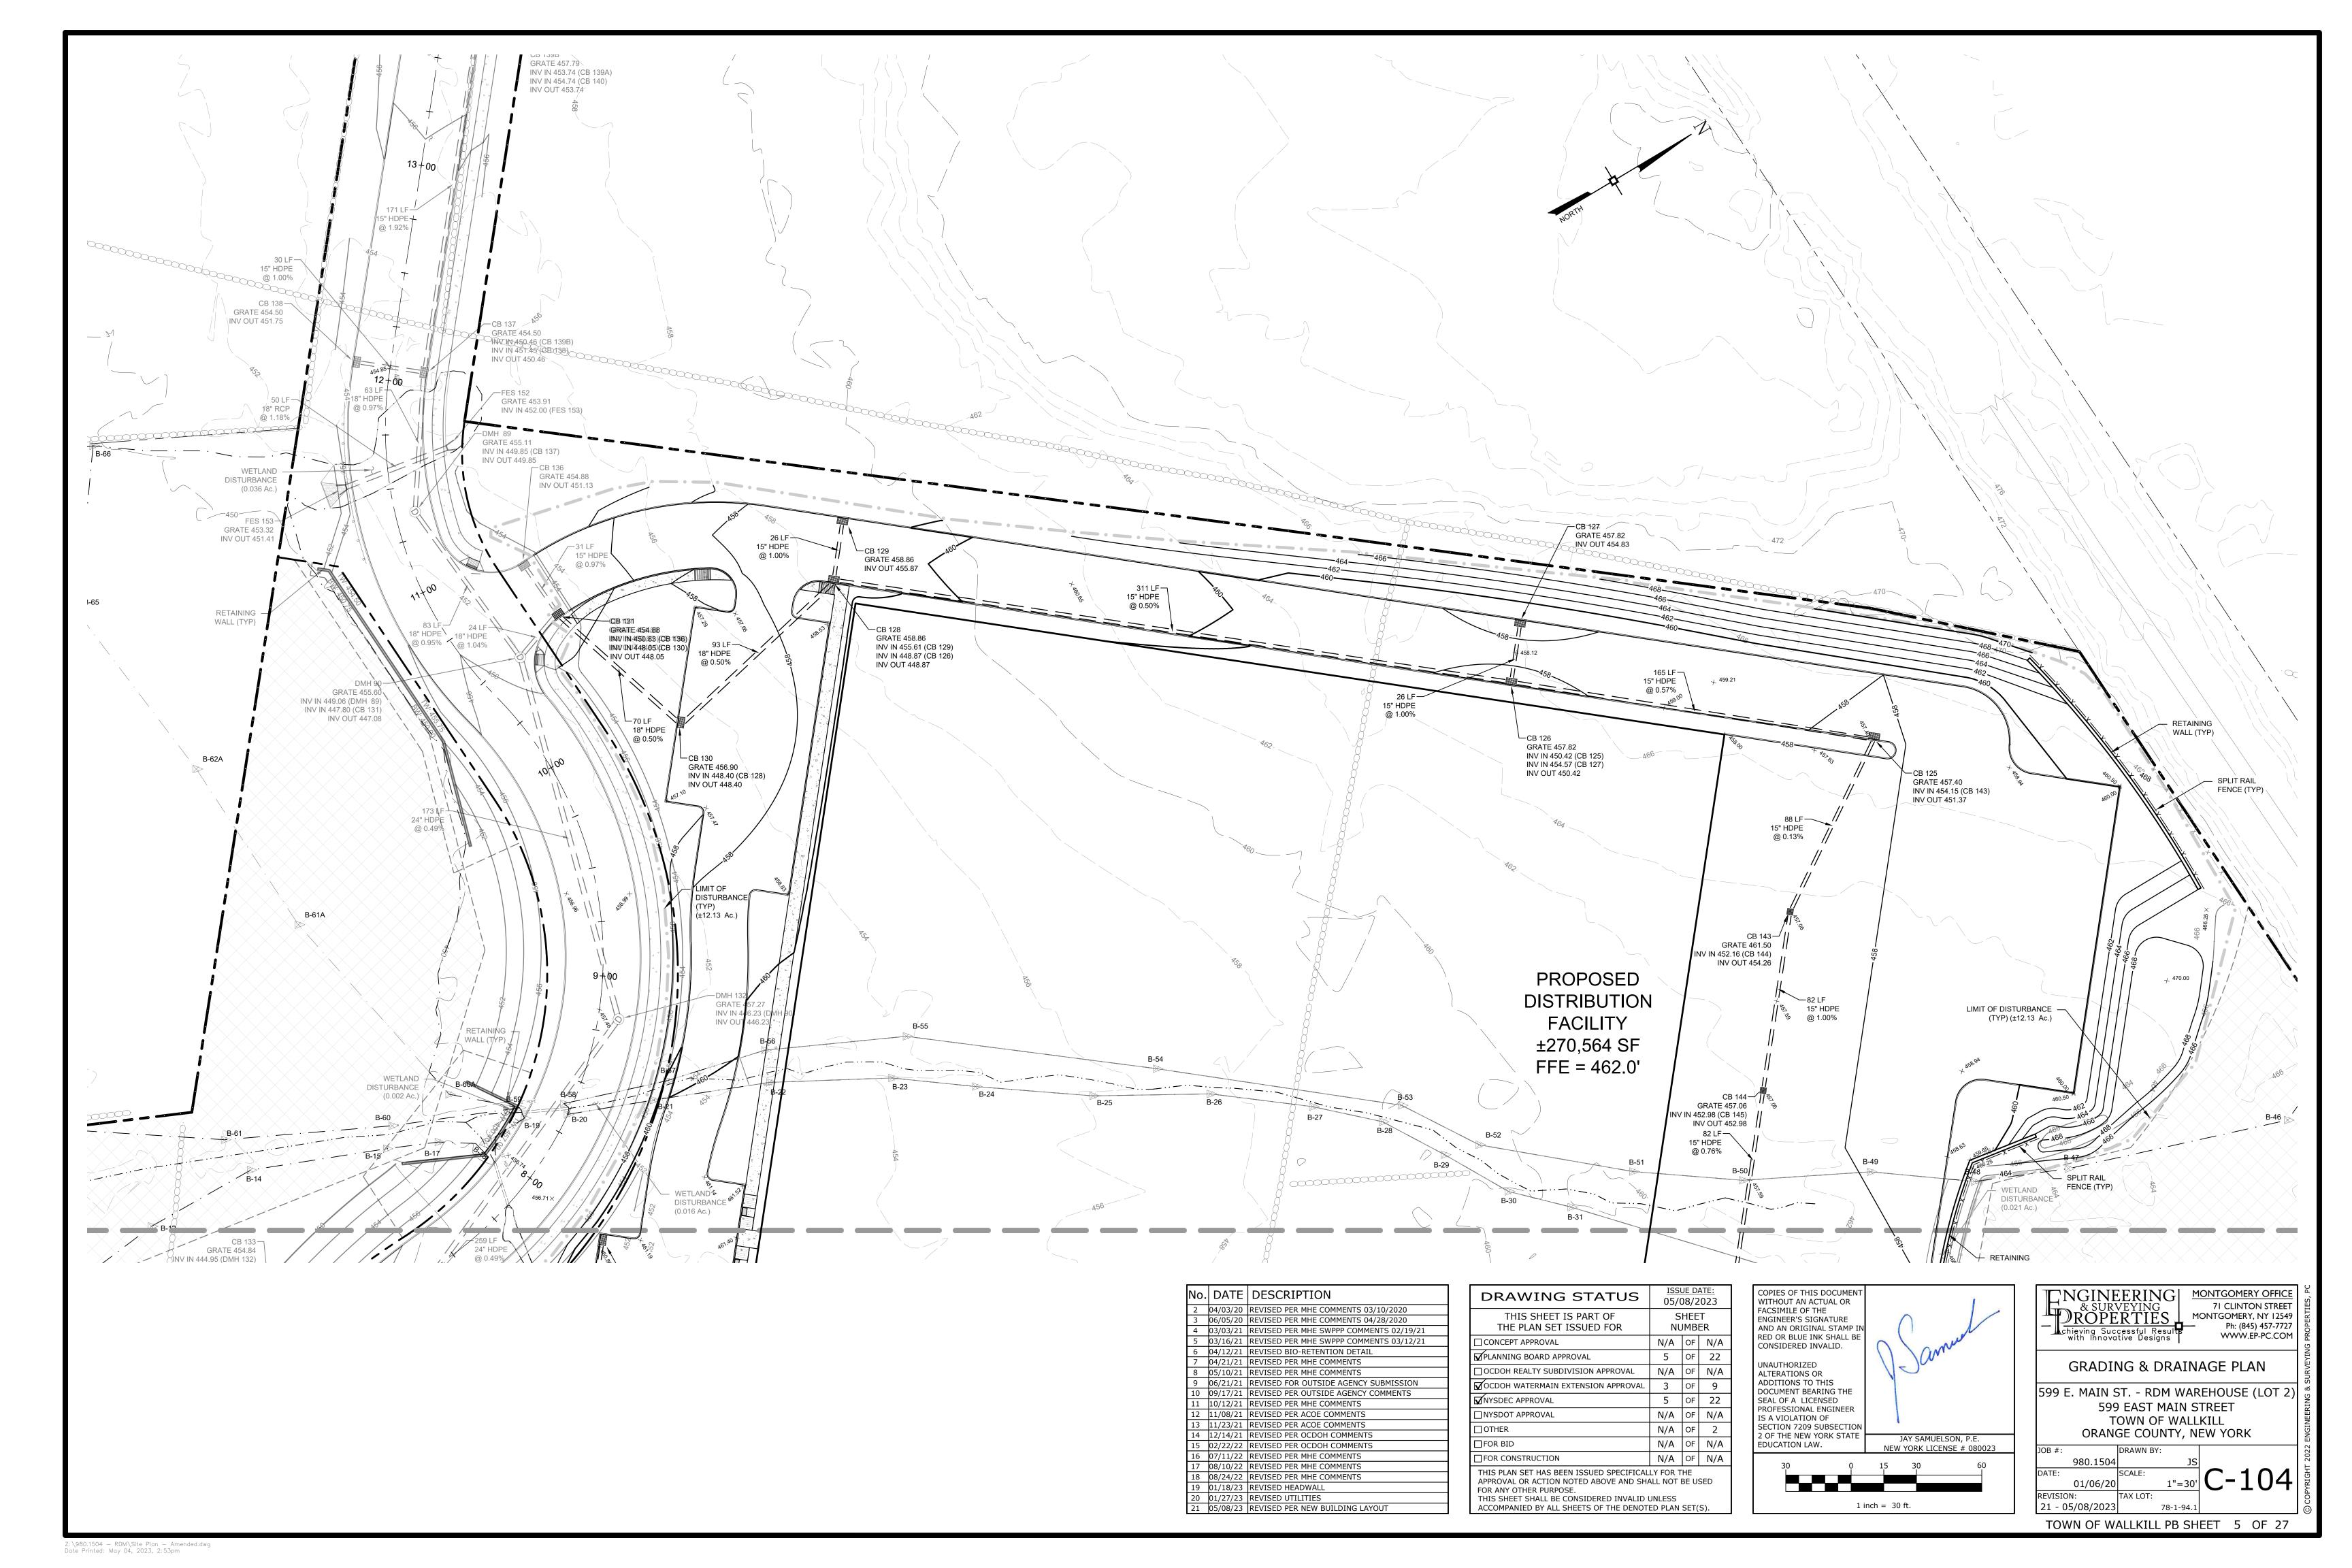


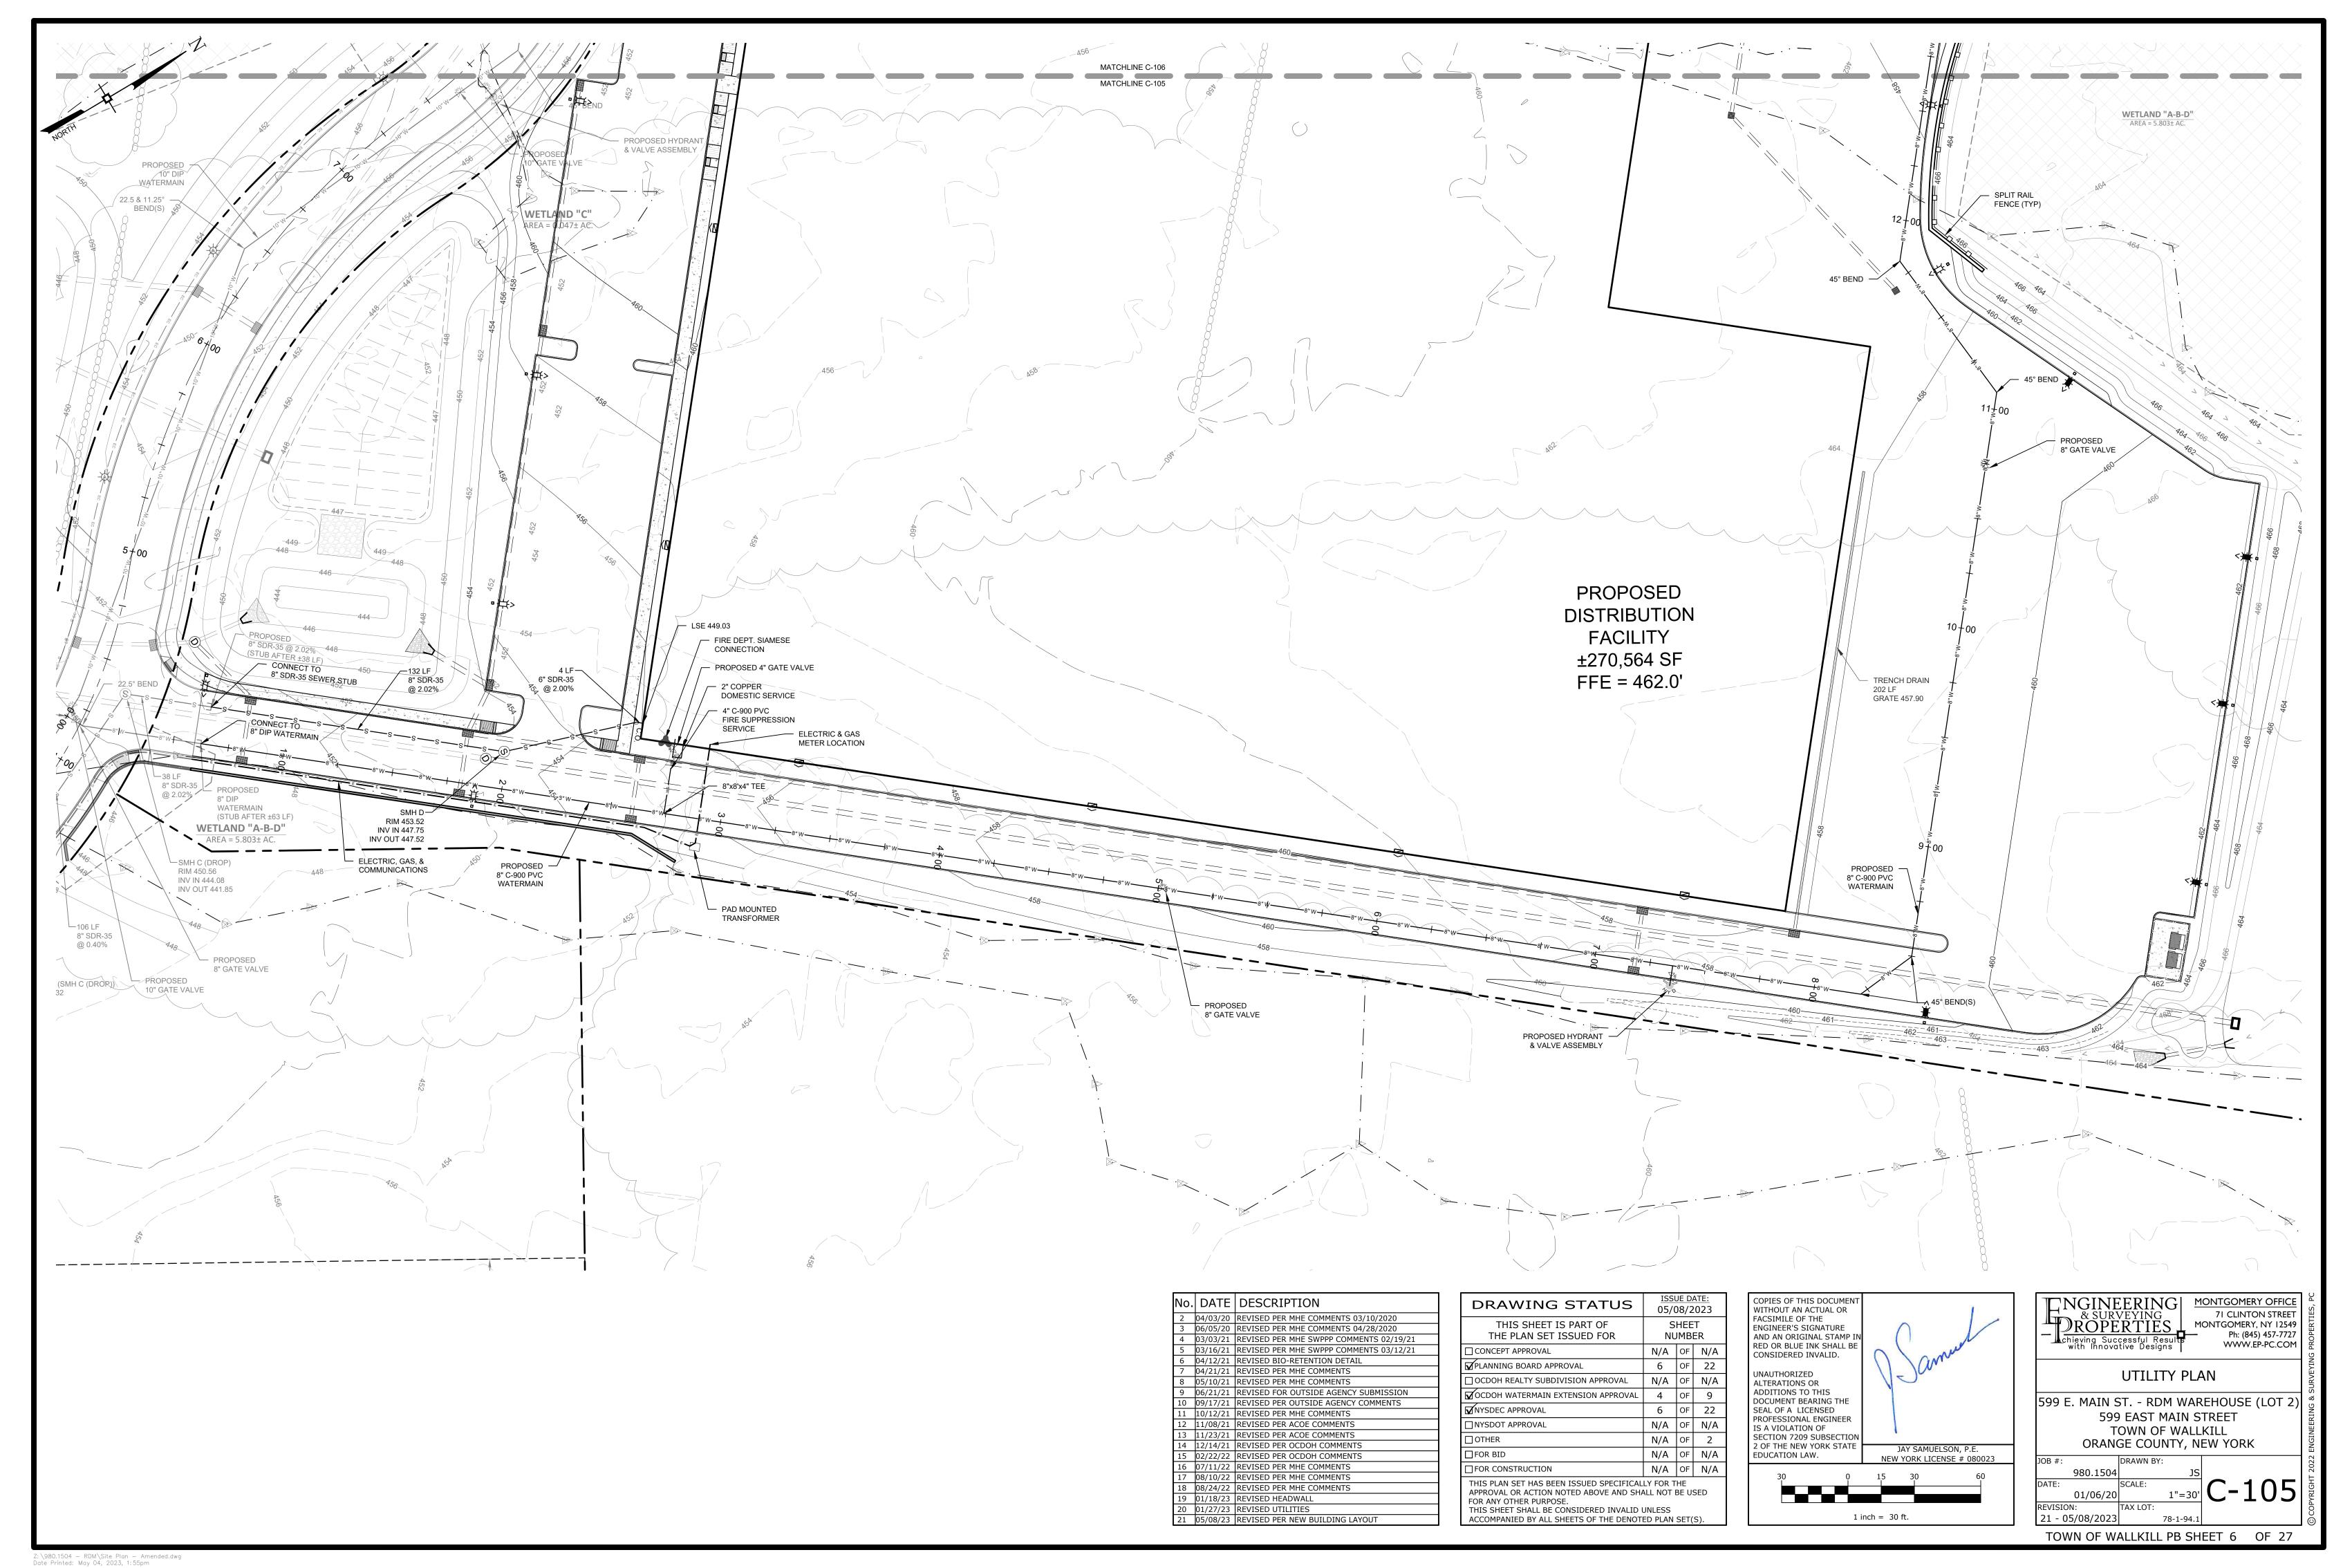


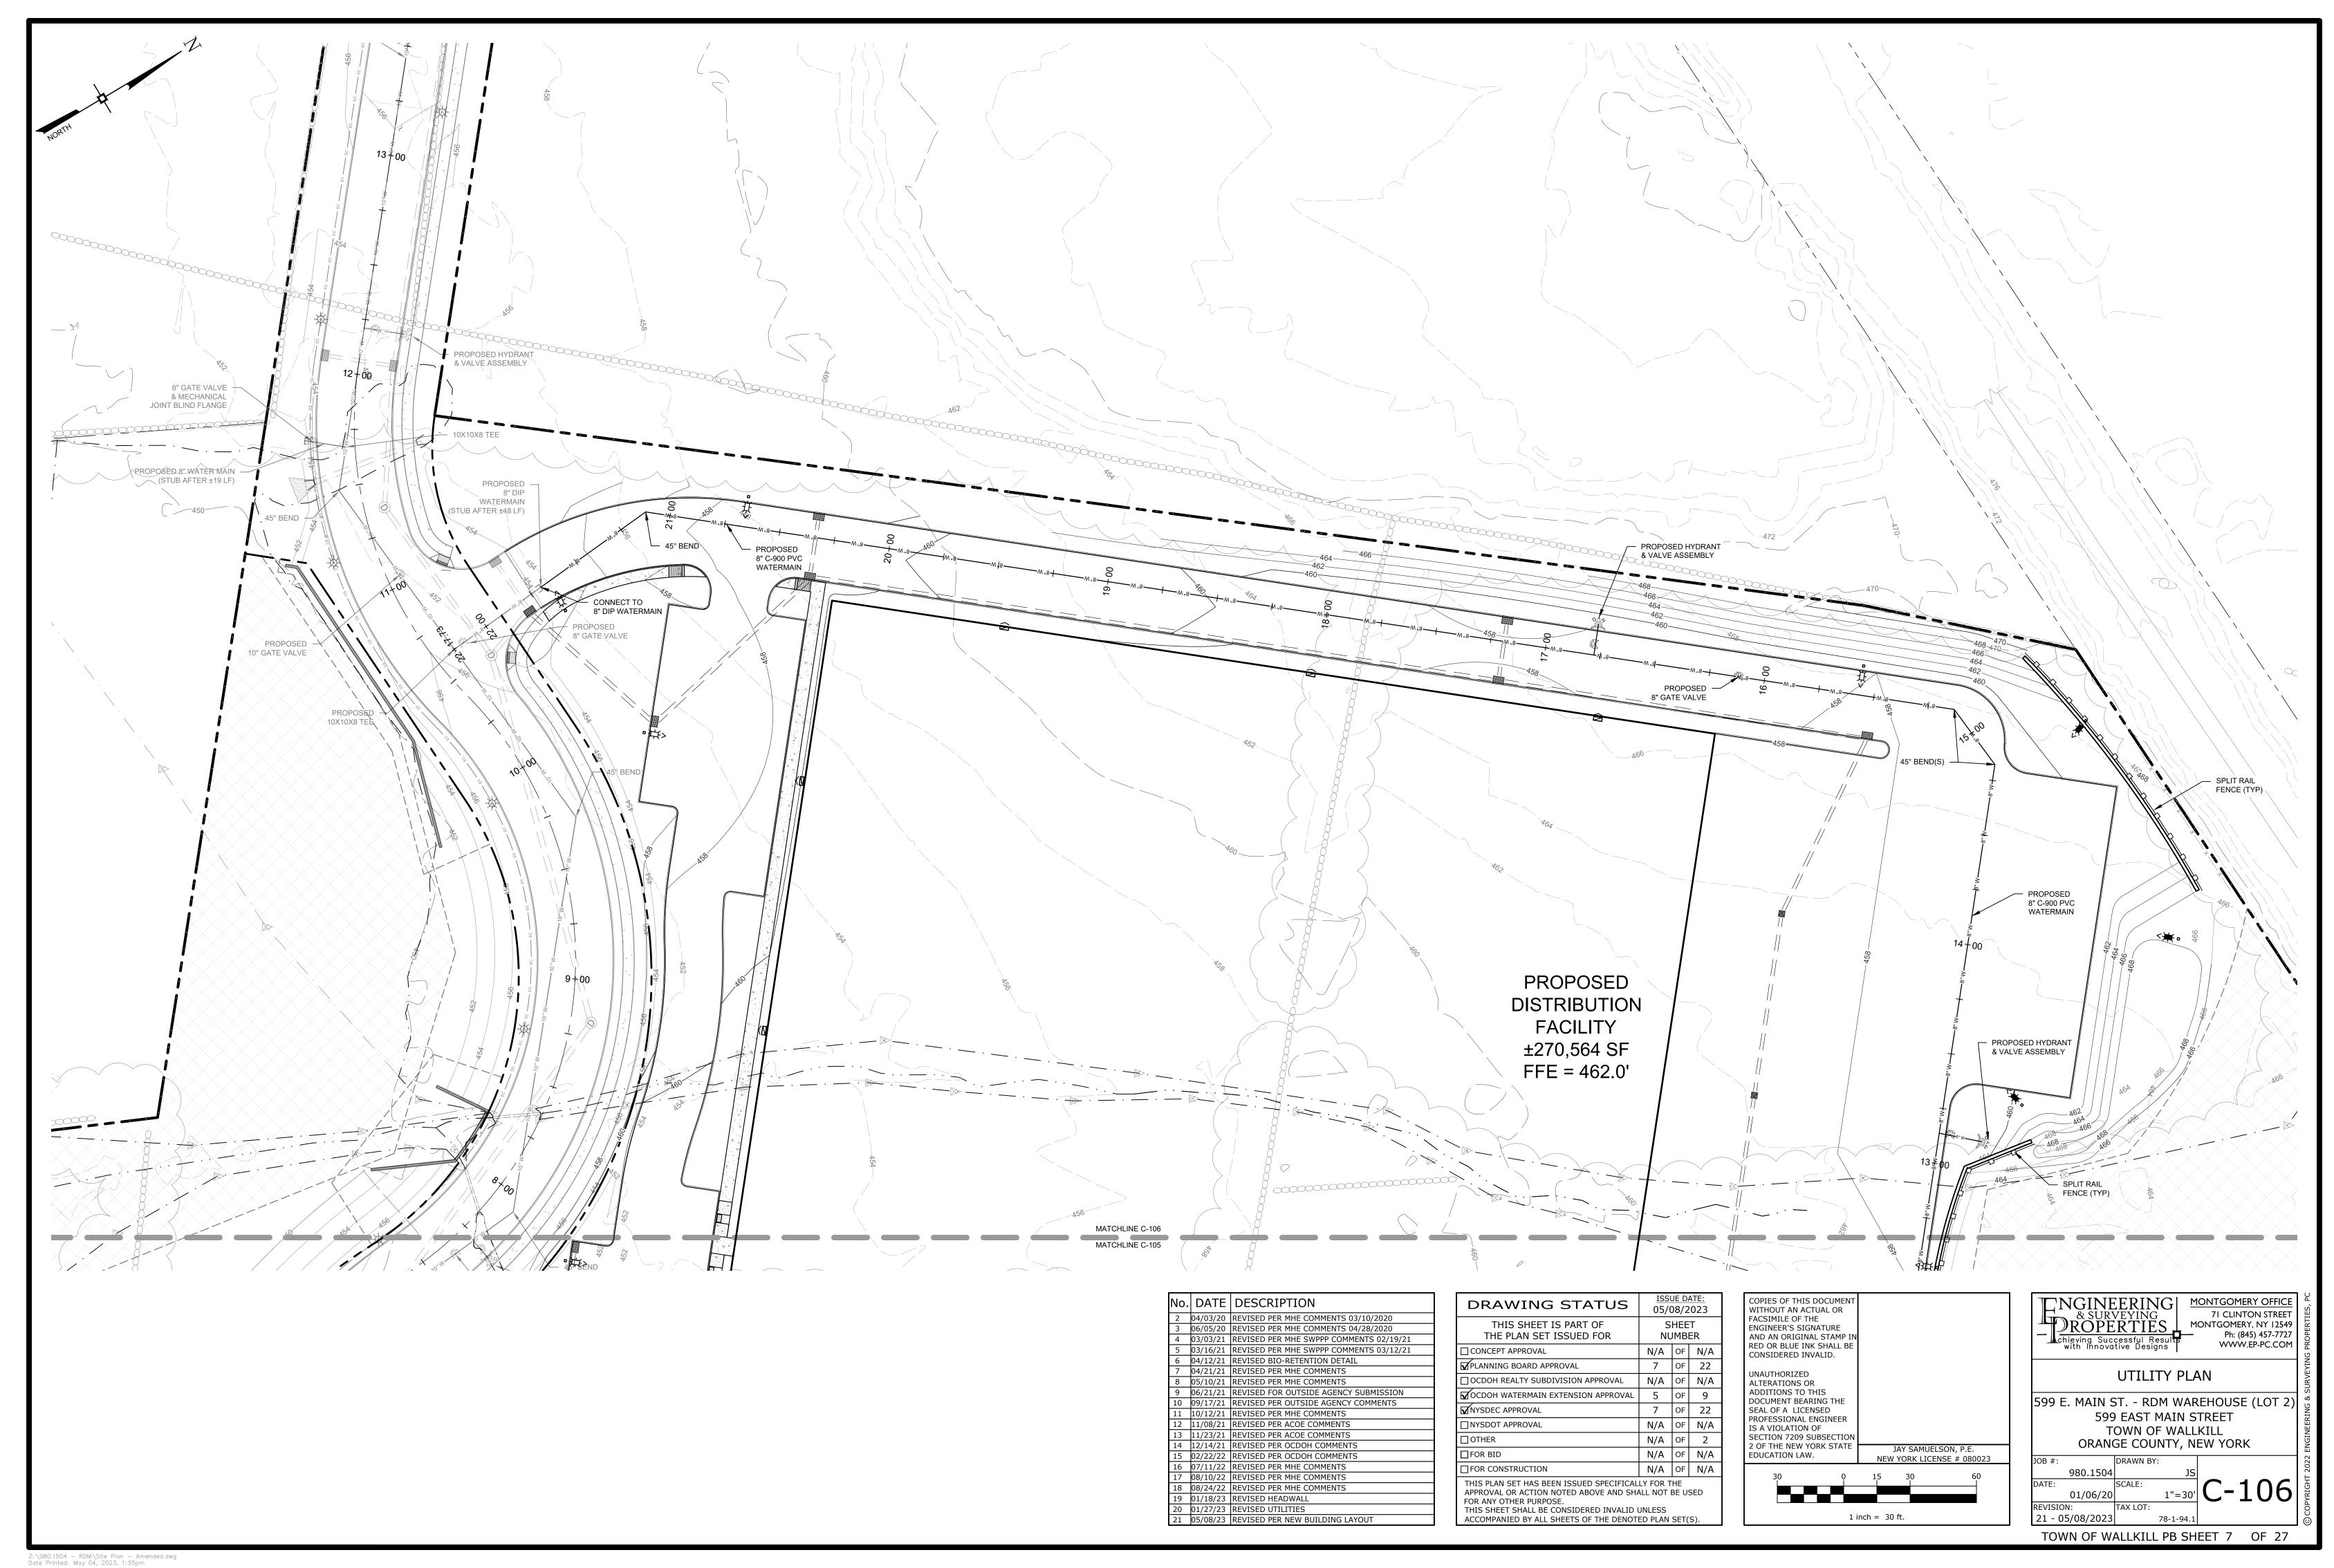

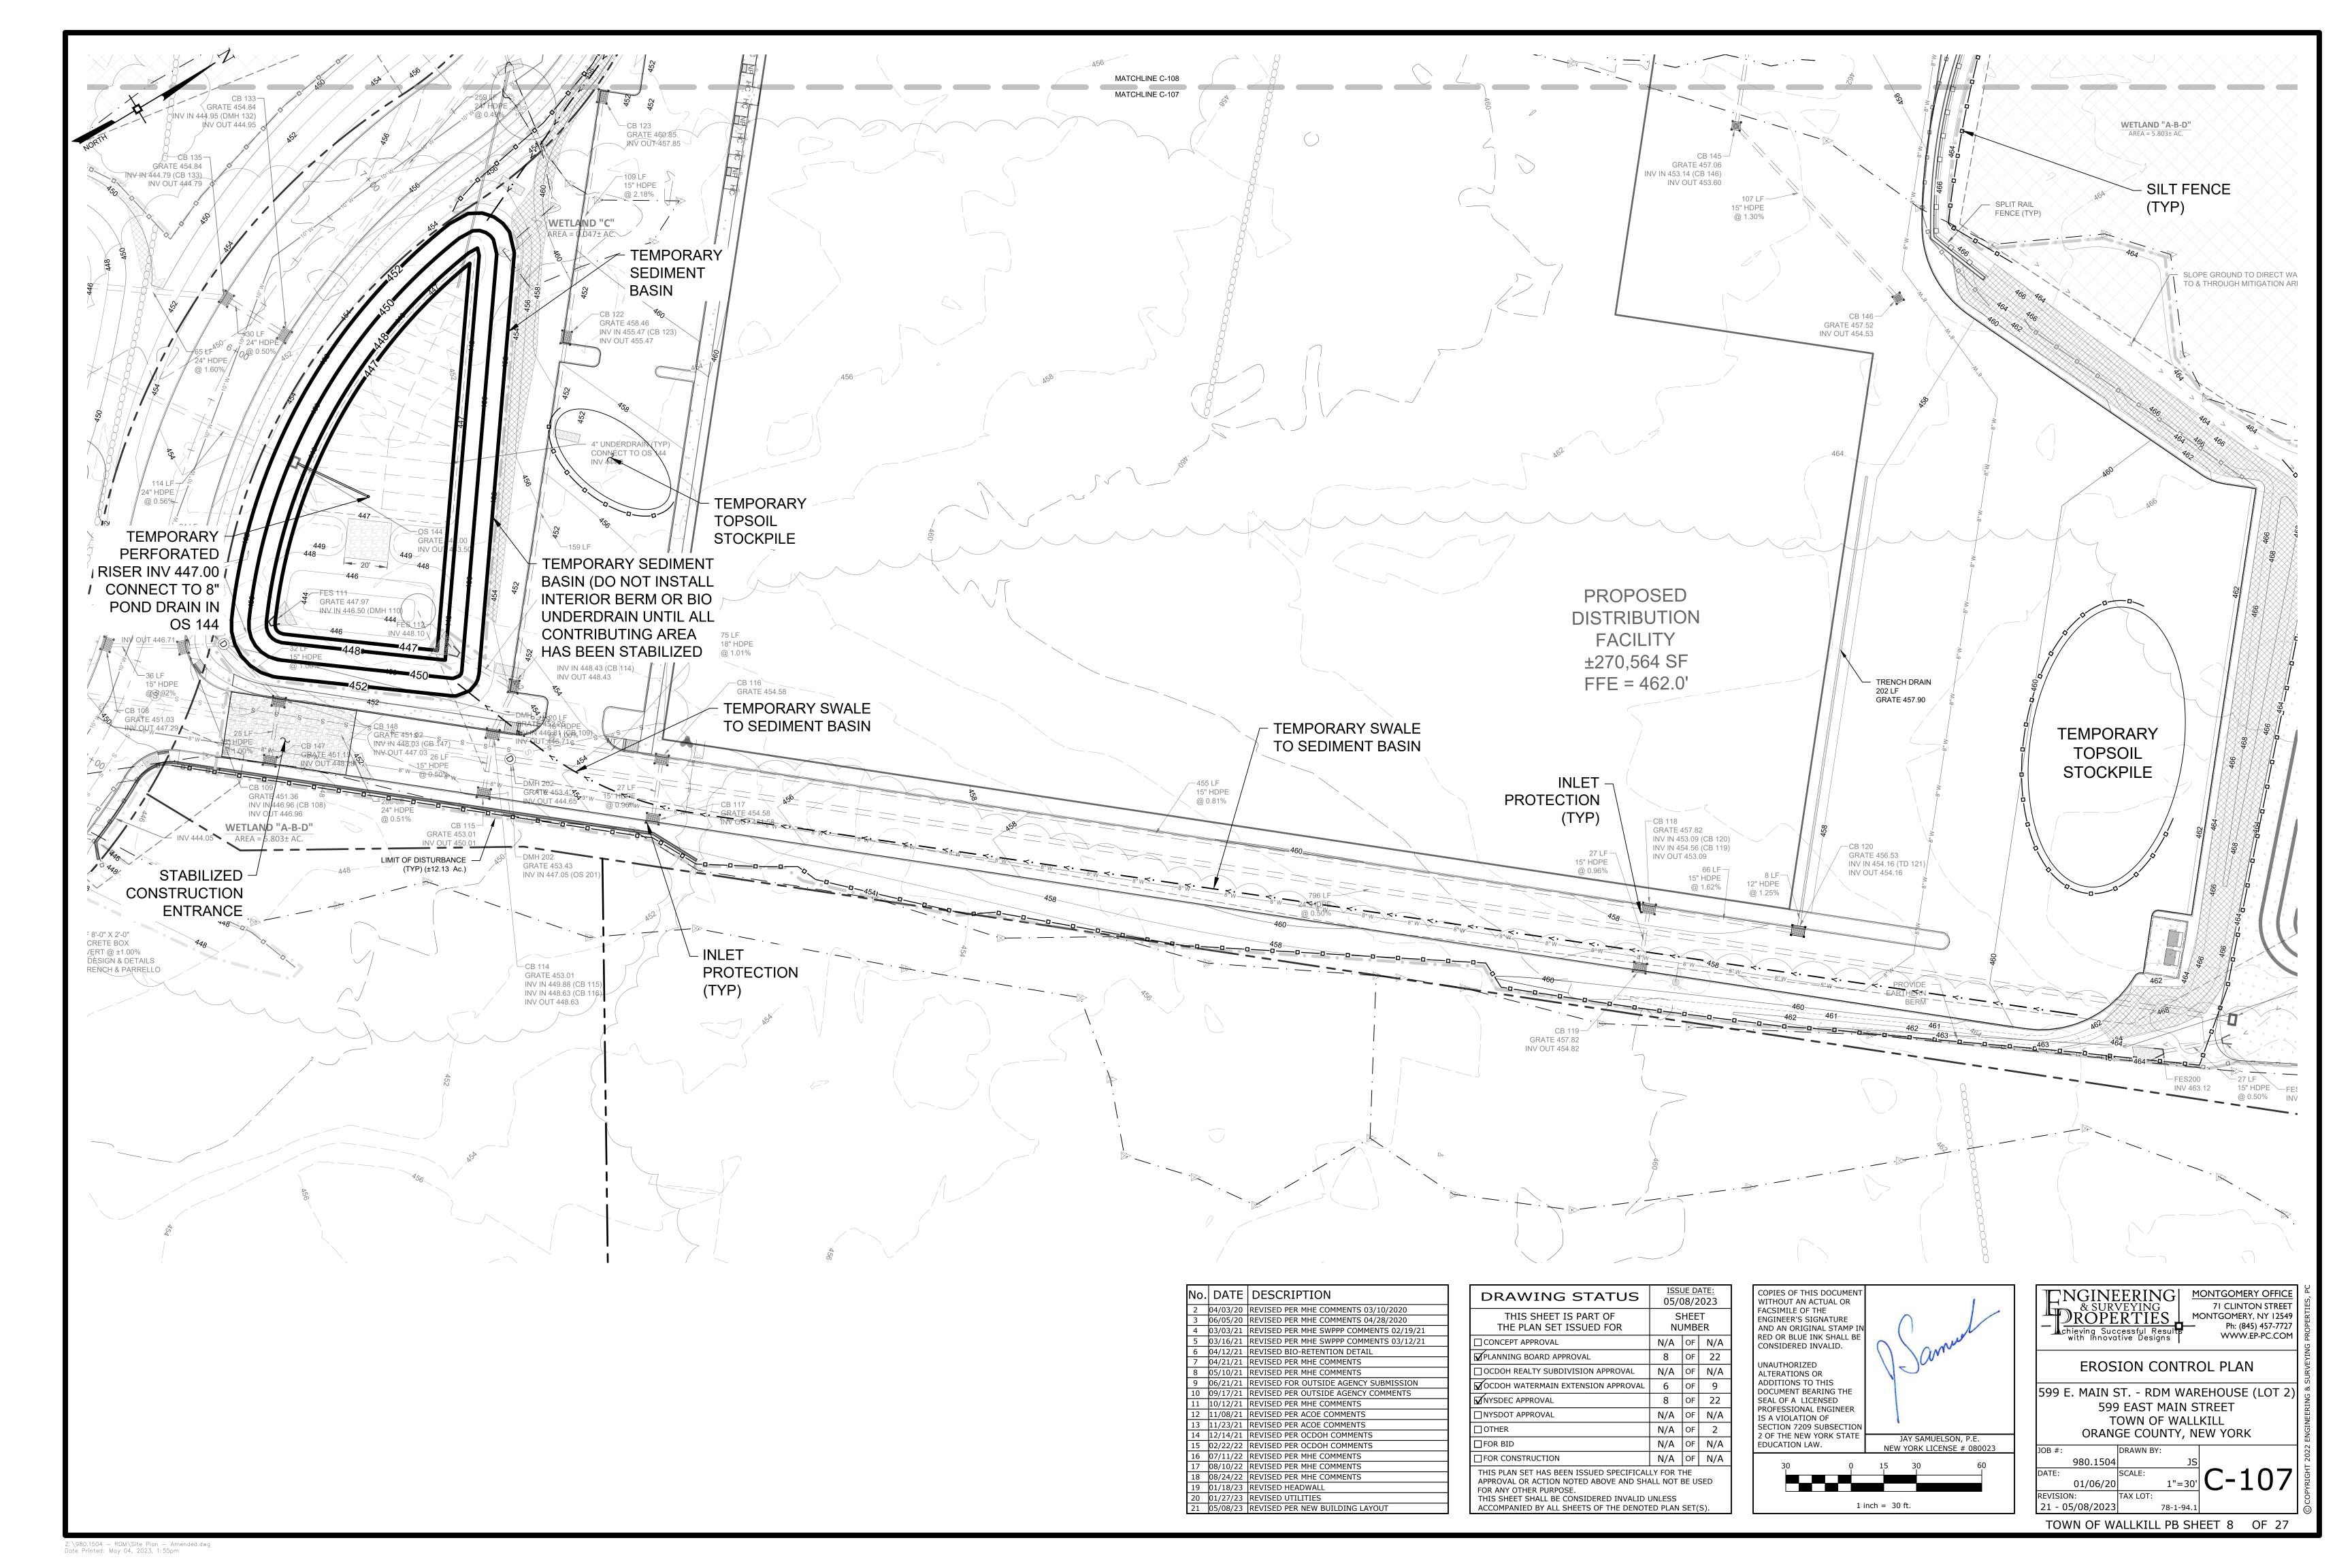

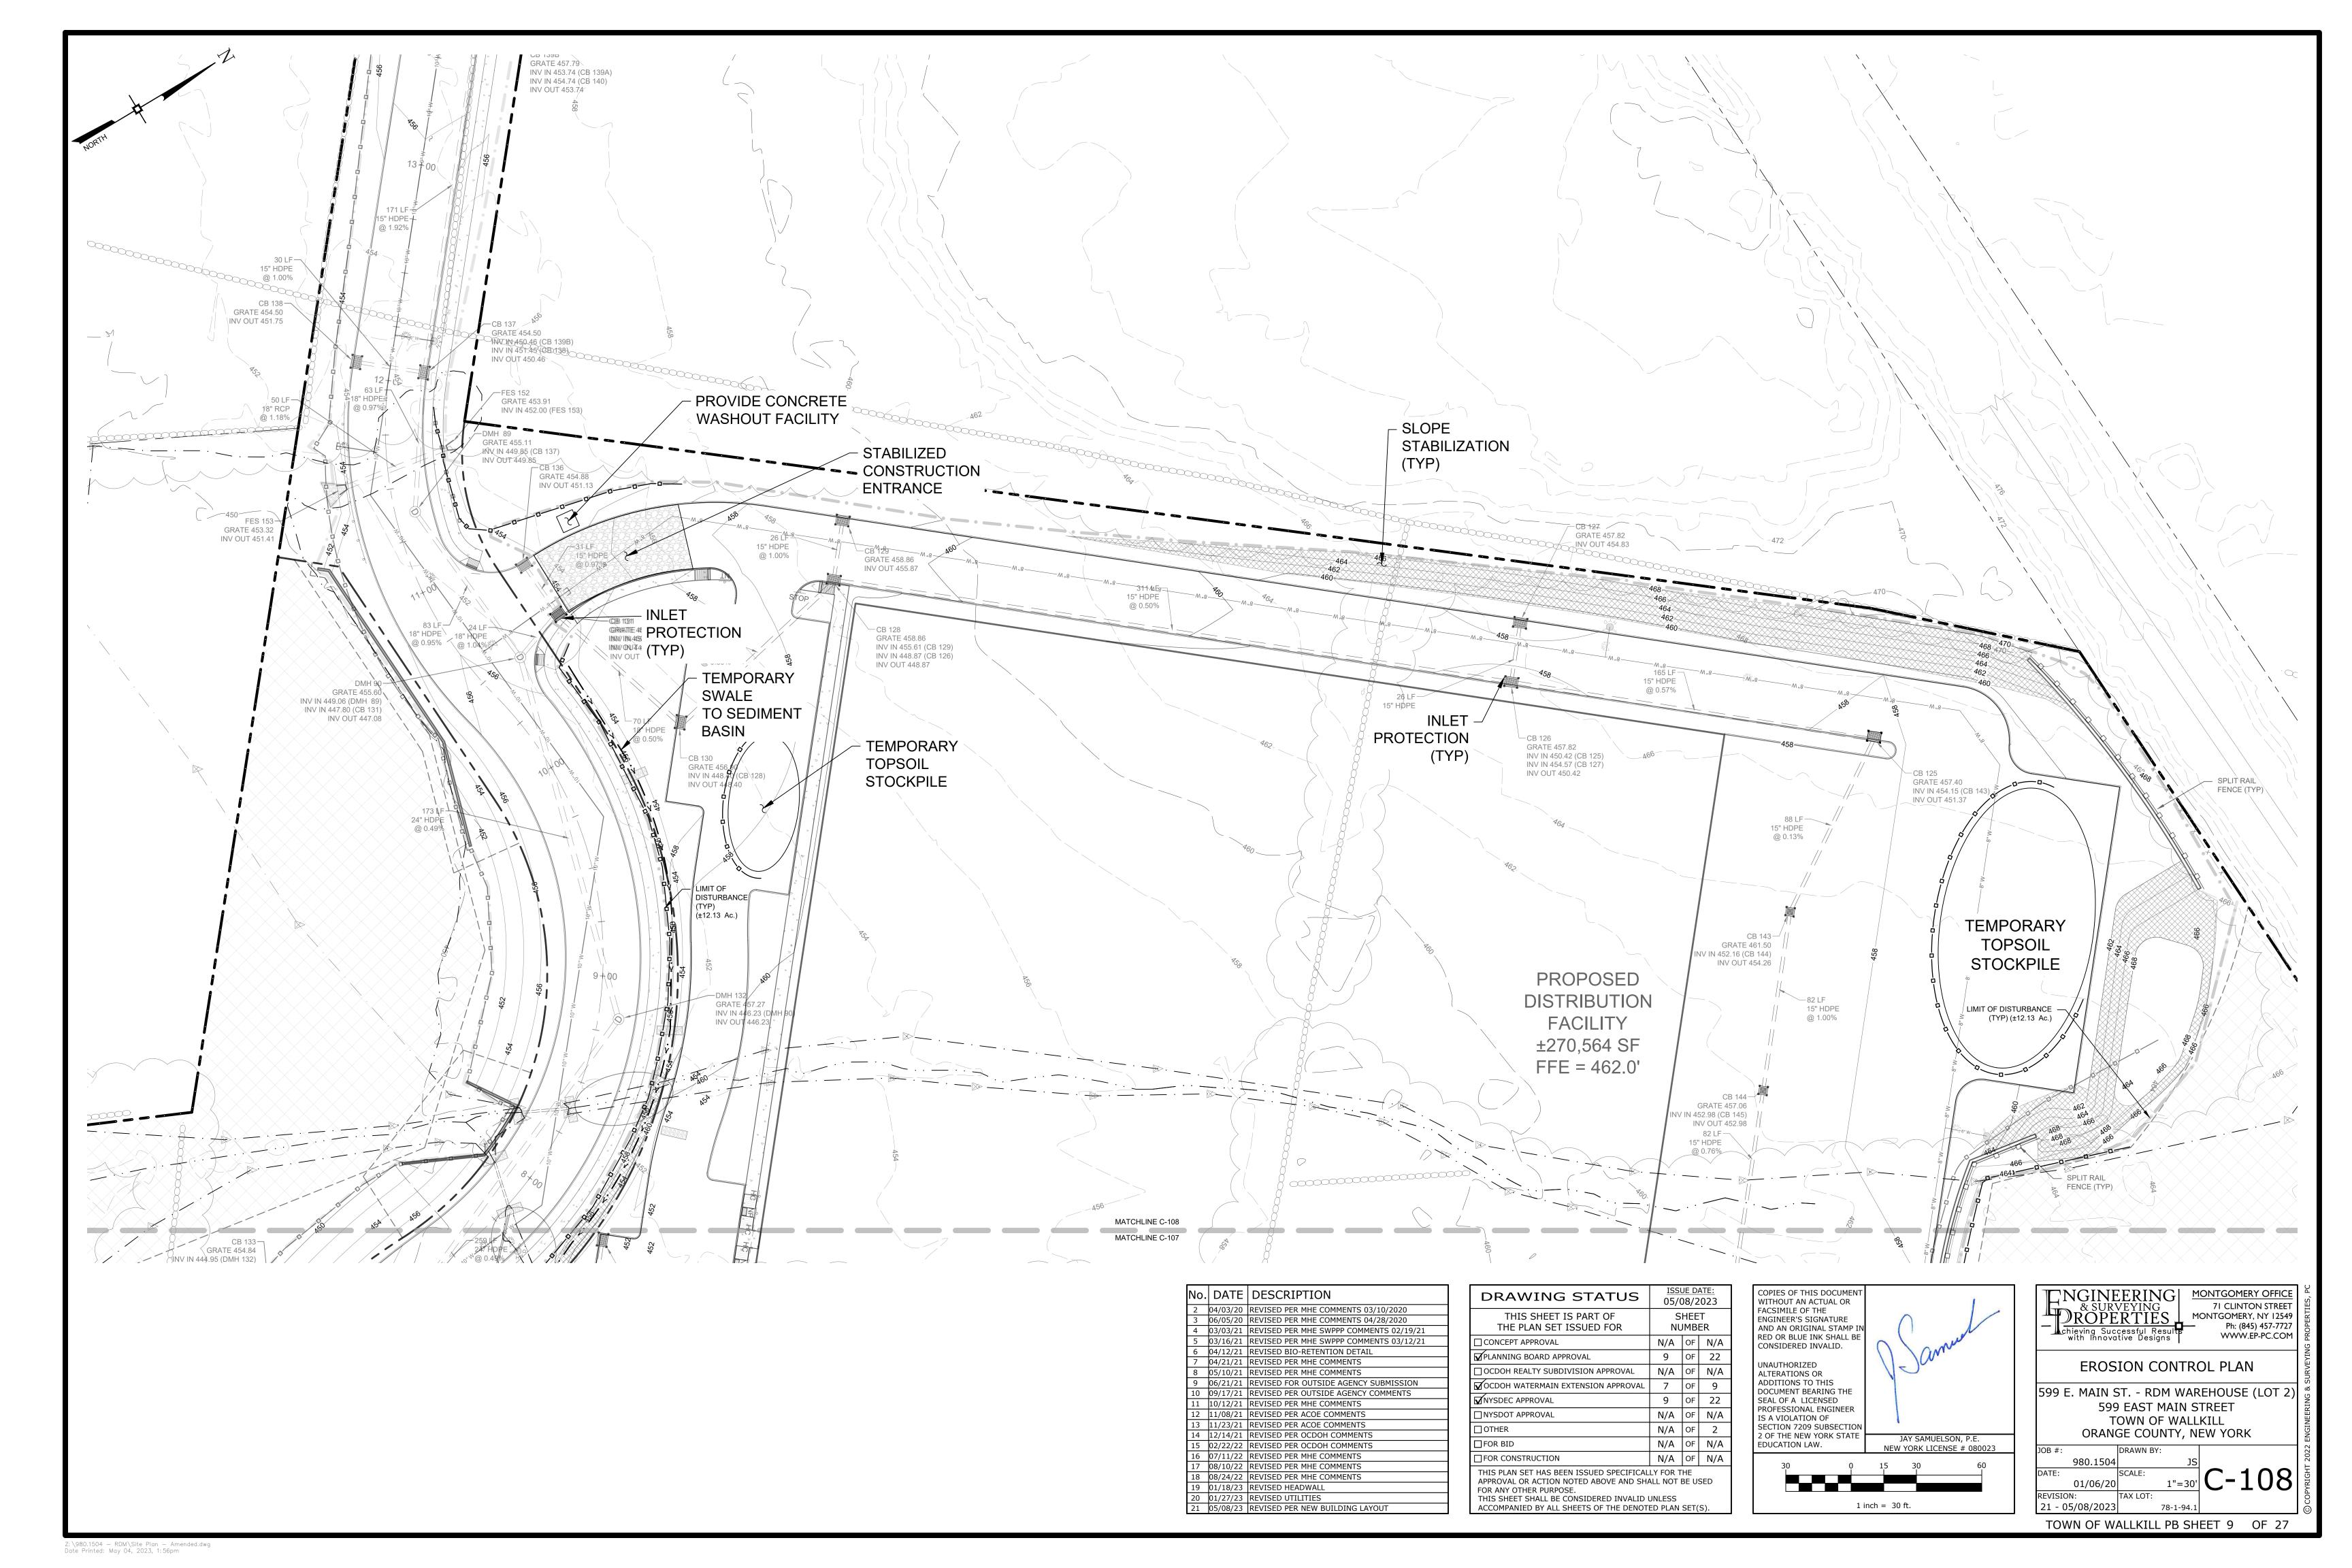

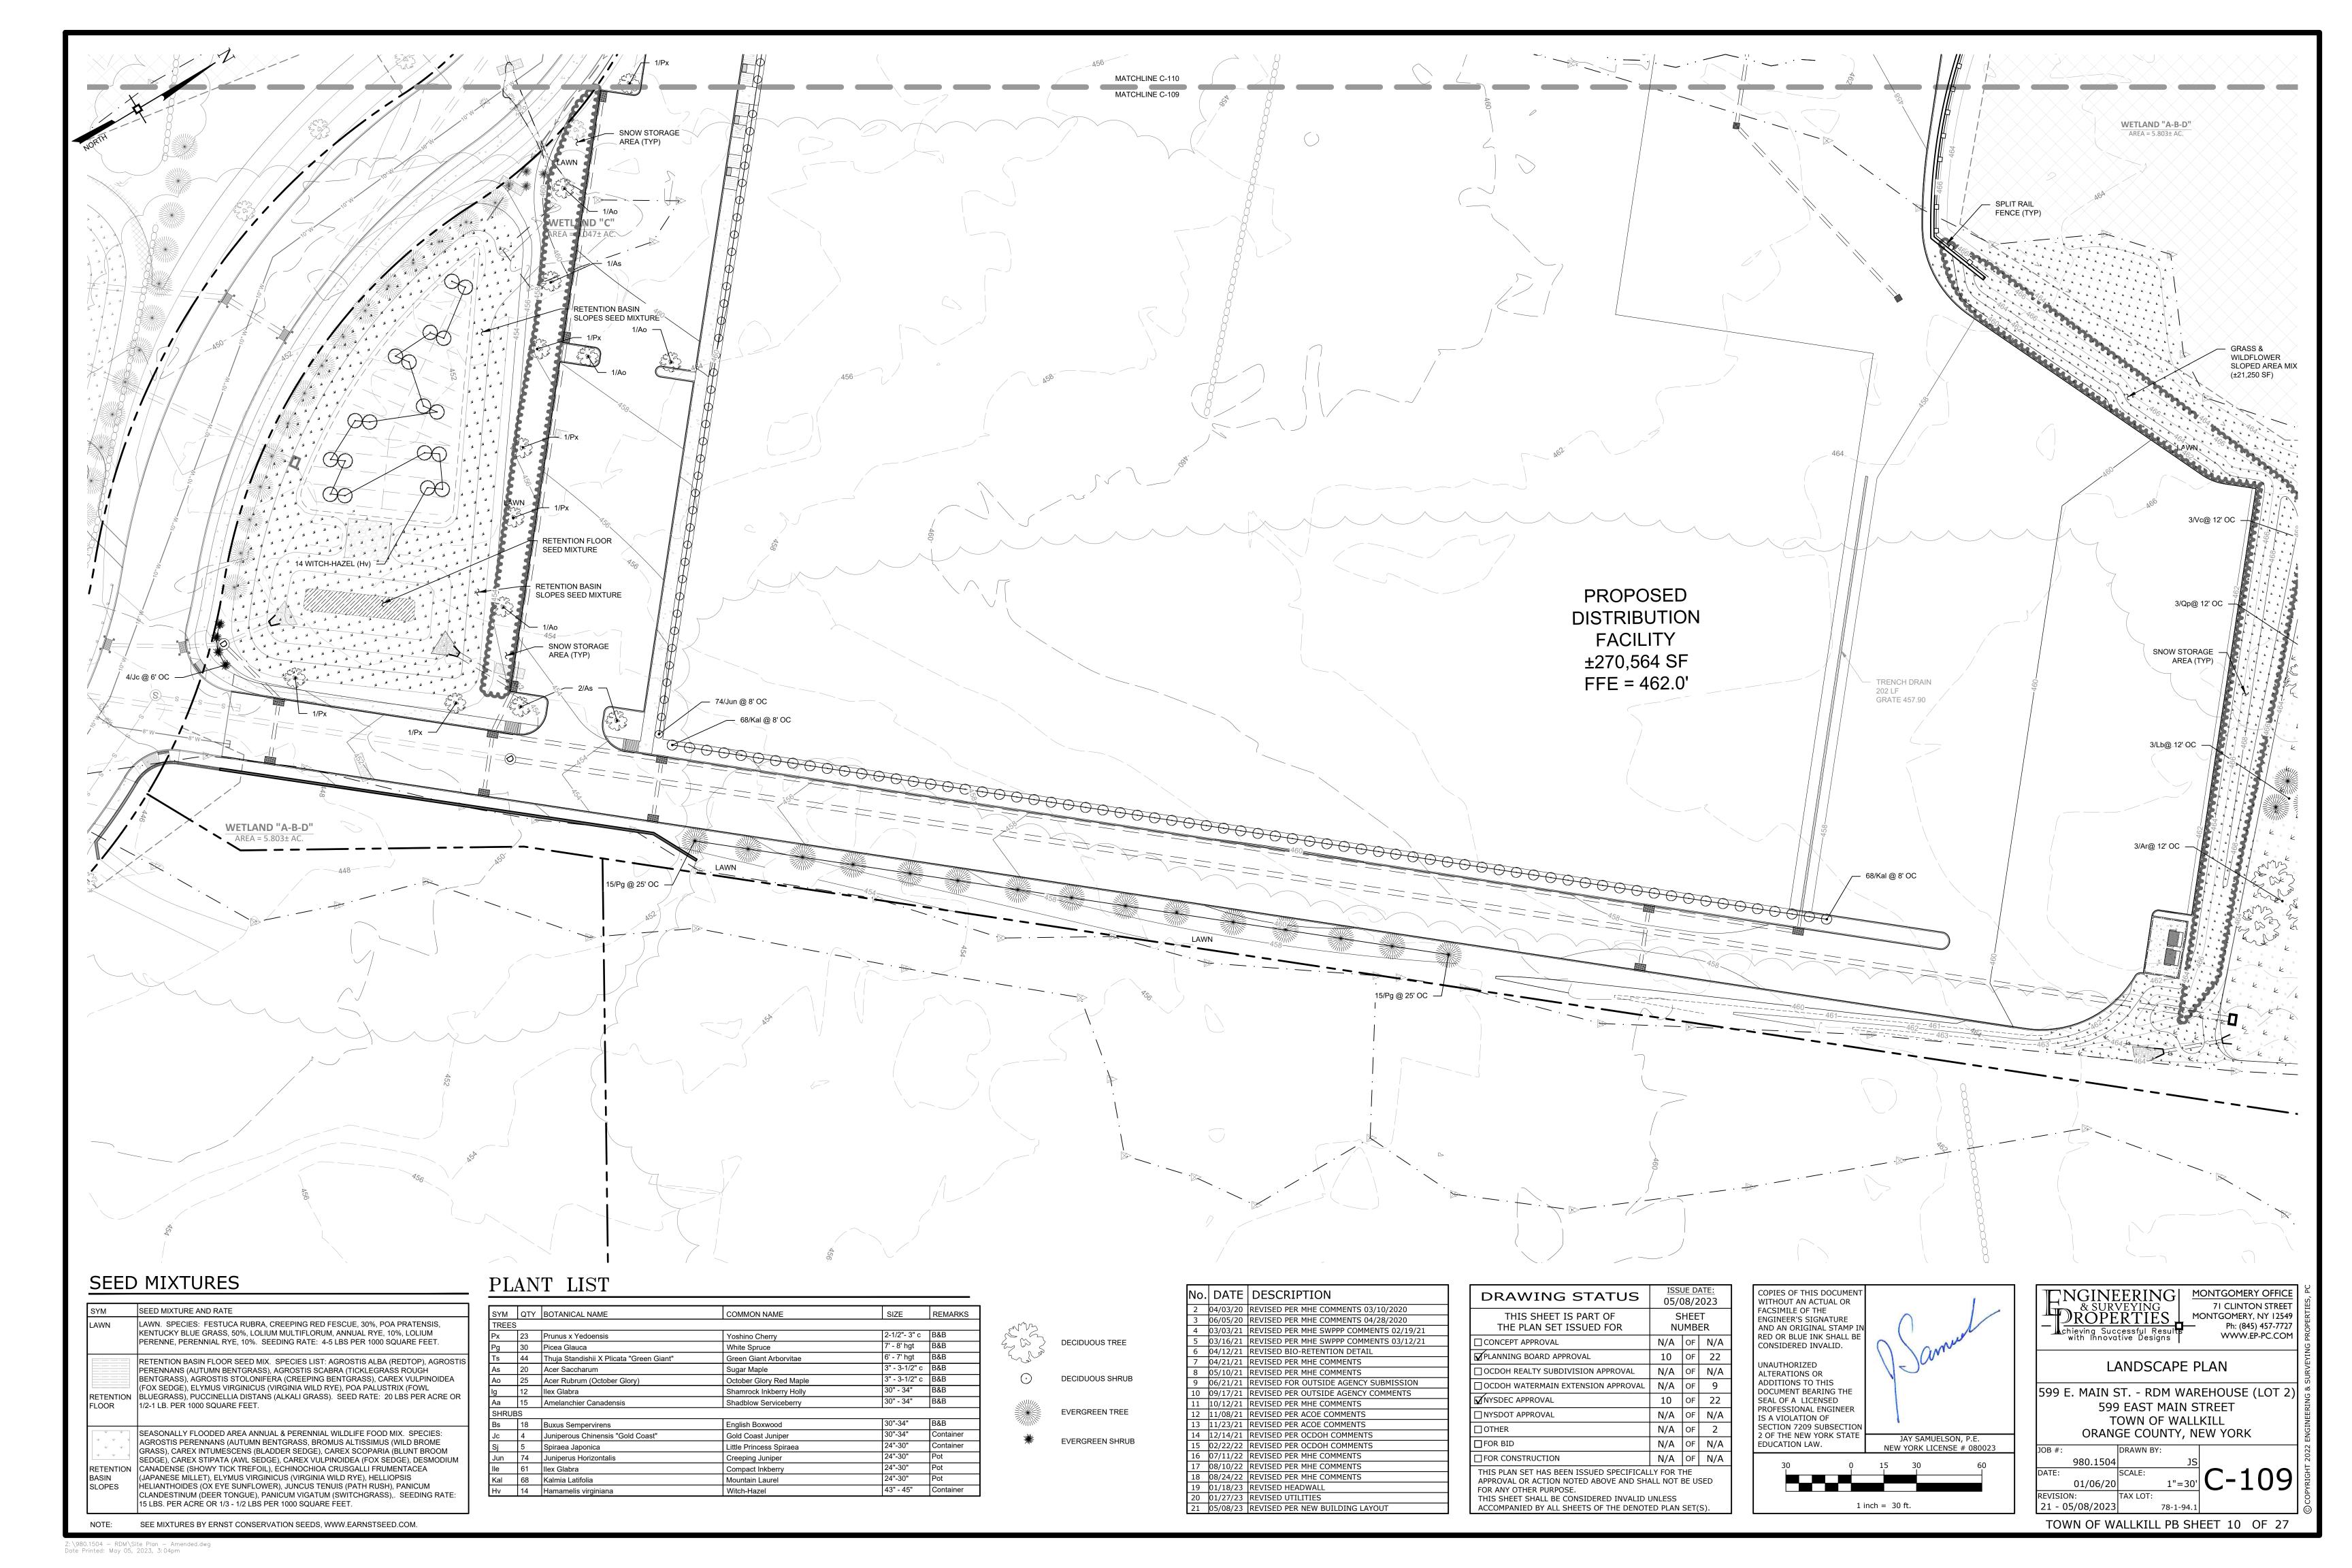

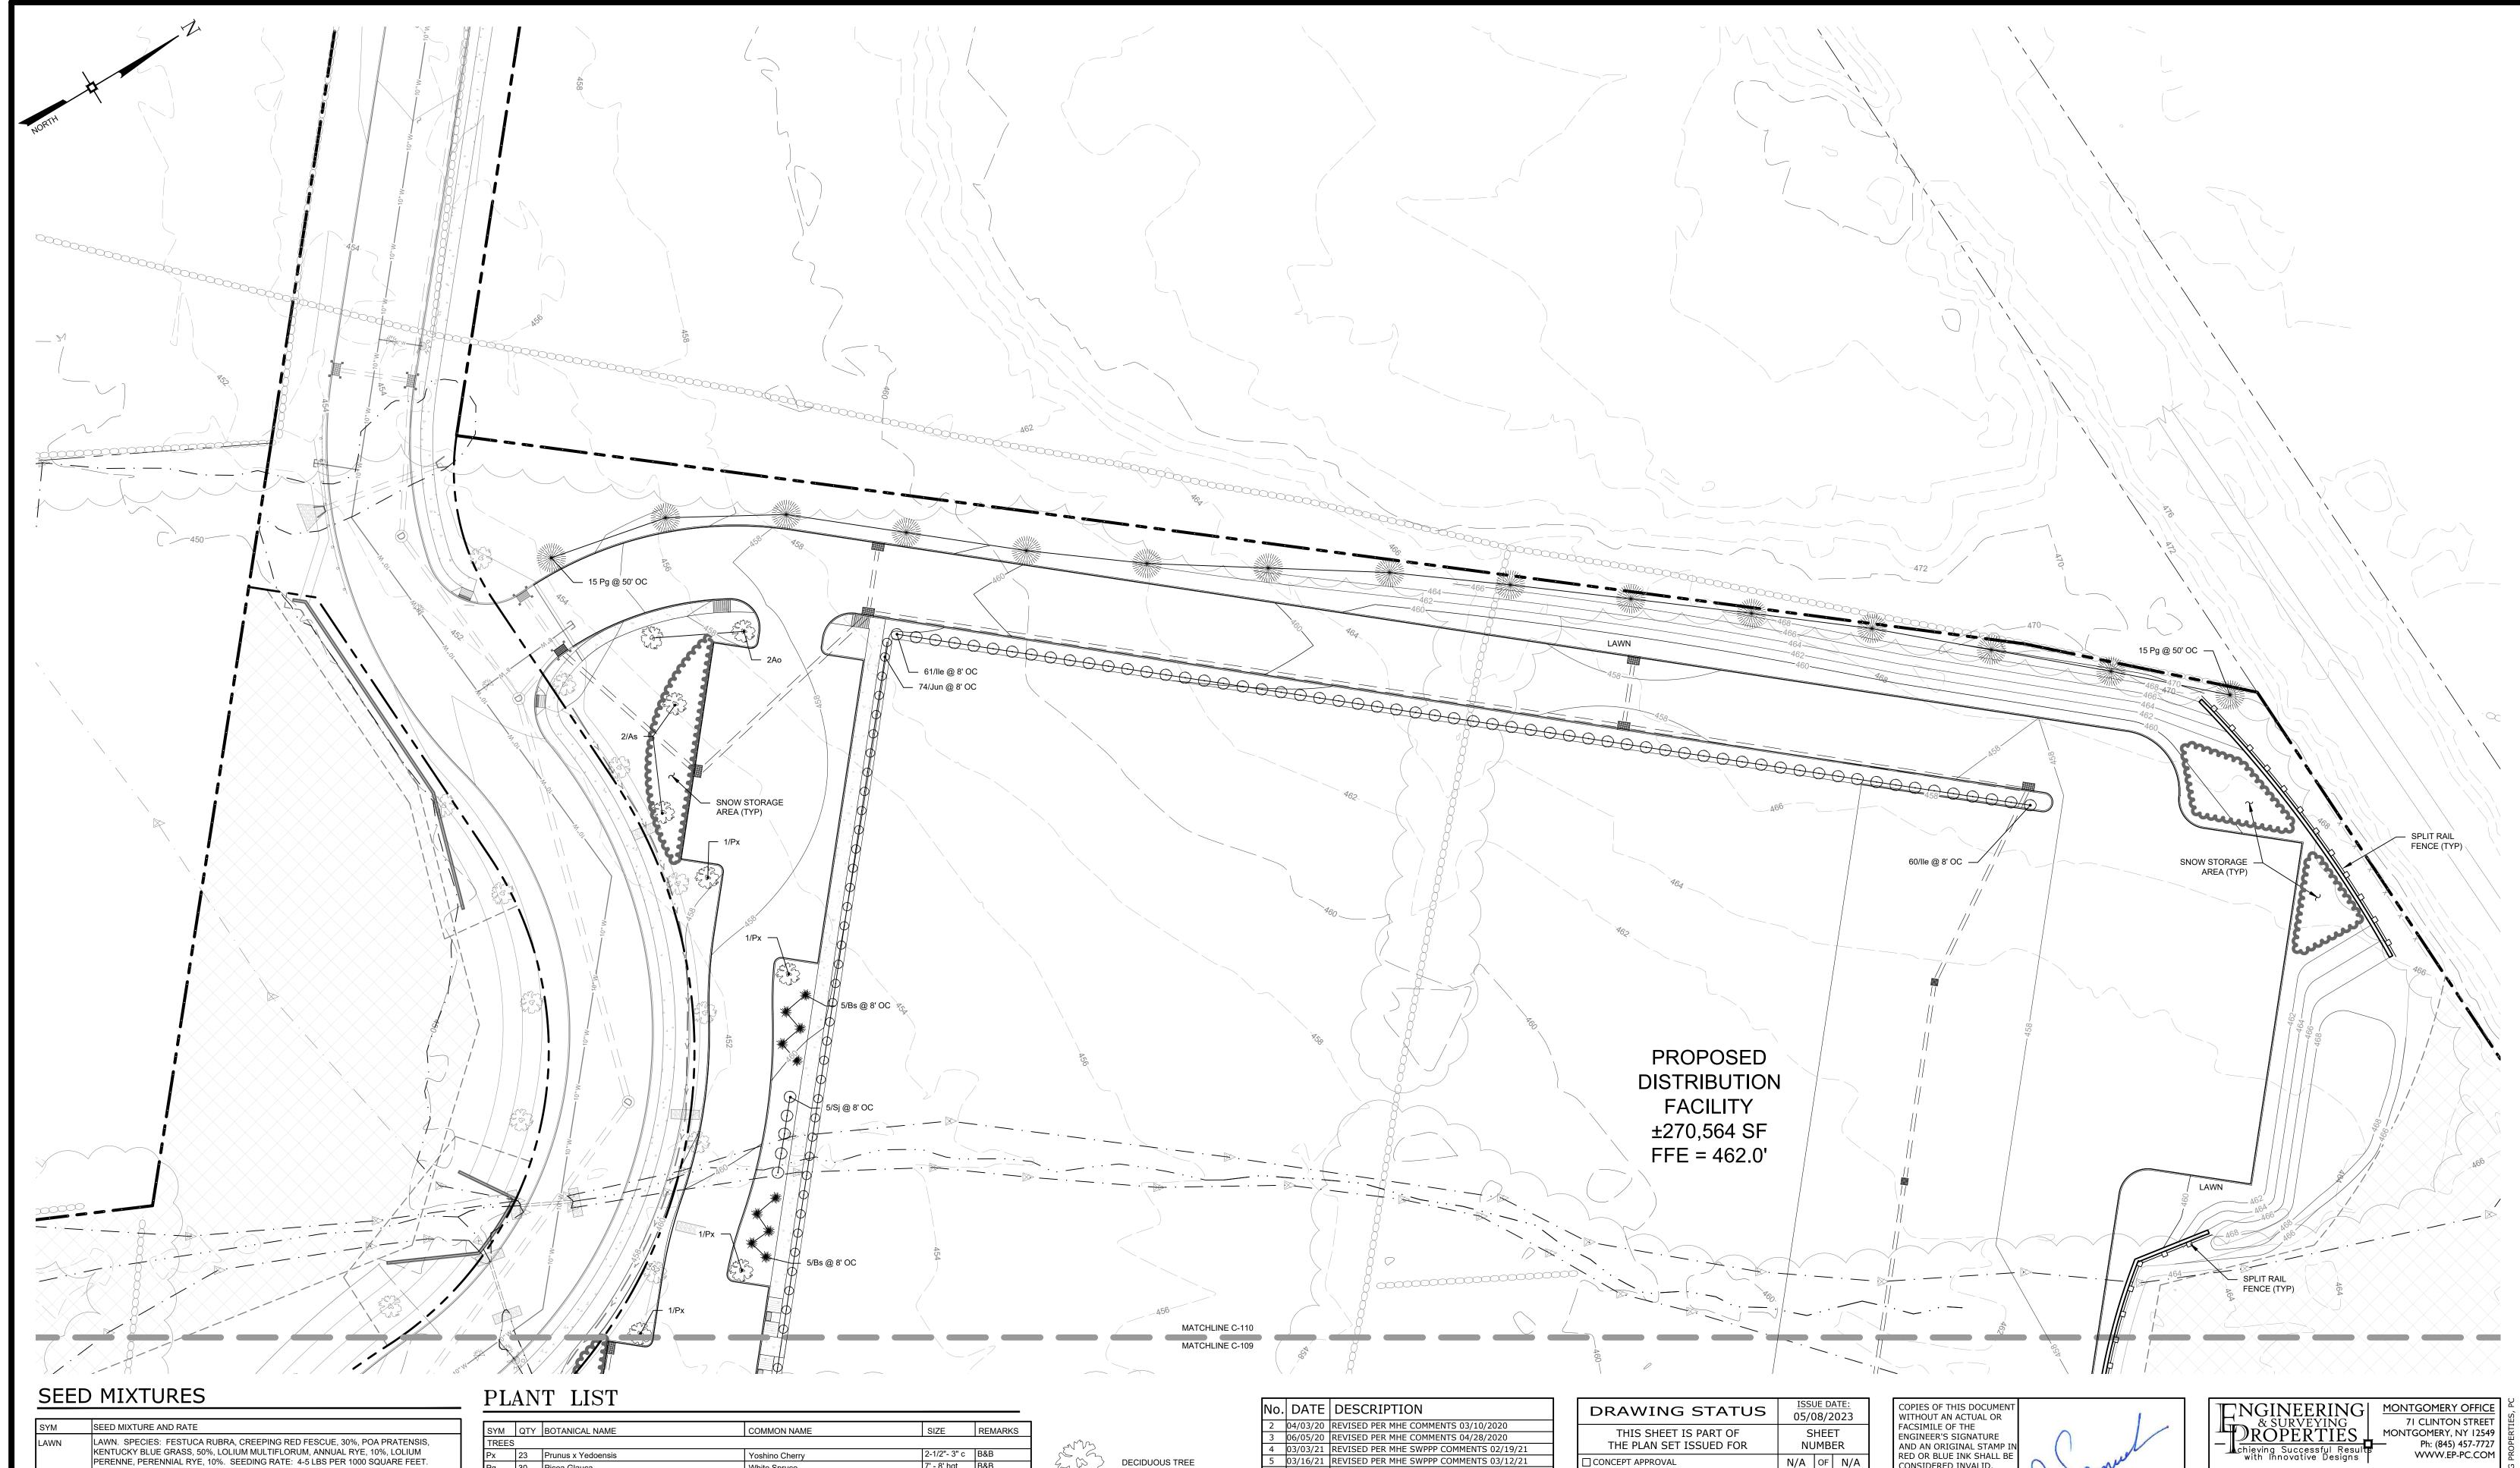


RETENTION BASIN FLOOR SEED MIX. SPECIES LIST: AGROSTIS ALBA (REDTOP), AGROSTIS PERENNANS (AUTUMN BENTGRASS), AGROSTIS SCABRA (TICKLEGRASS ROUGH BENTGRASS), AGROSTIS STOLONIFERA (CREEPING BENTGRASS), CAREX VULPINOIDEA (FOX SEDGE), ELYMUS VIRGINICUS (VIRGINIA WILD RYE), POA PALUSTRIX (FOWL RETENTION BLUEGRASS), PUCCINELLIA DISTANS (ALKALI GRASS). SEED RATE: 20 LBS PER ACRE OR 1/2-1 LB. PER 1000 SQUARE FEET.

SEASONALLY FLOODED AREA ANNUAL & PERENNIAL WILDLIFE FOOD MIX. SPECIES: GRASS), CAREX INTUMESCENS (BLADDER SEDGE), CAREX SCOPARIA (BLUNT BROOM SEDGE), CAREX STIPATA (AWL SEDGE), CAREX VULPINOIDEA (FOX SEDGE), DESMODIUM RETENTION CANADENSE (SHOWY TICK TREFOIL), ECHINOCHIOA CRUSGALLI FRUMENTACEA (JAPANESE MILLET), ELYMUS VIRGINICUS (VIRGINIA WILD RYE), HELLIOPSIS HELIANTHOIDES (OX EYE SUNFLOWER), JUNCUS TENUIS (PATH RUSH), PANICUM CLANDESTINUM (DEER TONGUE), PANICUM VIGATUM (SWITCHGRASS),. SEEDING RATE:

15 LBS. PER ACRÈ OR 1/3 - 1/2 LBS PER 1000 SQUARE FEET.

2-1/2"- 3" c B&B 7' - 8' hgt B&B 30 Picea Glauca White Spruce 6' - 7' hgt B&B 3" - 3-1/2" c B&B Ts 44 Thuja Standishii X Plicata "Green Giant" Green Giant Arborvitae 20 Acer Saccharum Sugar Maple 3" - 3-1/2" c B&B Ao 25 Acer Rubrum (October Glory October Glory Red Maple 30" - 34" B&B 30" - 34" B&B Shamrock Inkberry Holly Aa 15 Amelanchier Canadensis Shadblow Serviceberry 30"-34" B&B English Boxwood Buxus Sempervirens 30"-34" Container Juniperous Chinensis "Gold Coast" Gold Coast Juniper 24"-30" Container Little Princess Spiraea Spiraea Japonica Jun 74 Juniperus Ho Ile 61 Ilex Glabra Juniperus Horizontalis Creeping Juniper Kal 68 Kalmia Latifolia Hv 14 Hamamelis virginiana

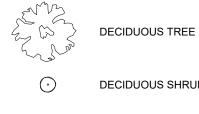

ECIDUOUS TREE	5	03/16/21	REVISED PER MHE SWPPP COMMENTS 03/12
	6	04/12/21	REVISED BIO-RETENTION DETAIL
	7	04/21/21	REVISED PER MHE COMMENTS
ECIDITOLIS STIDLID	8	05/10/21	REVISED PER MHE COMMENTS
ECIDUOUS SHRUB	9	06/21/21	REVISED FOR OUTSIDE AGENCY SUBMISSIO
	10	09/17/21	REVISED PER OUTSIDE AGENCY COMMENTS
	11	10/12/21	REVISED PER MHE COMMENTS
VERGREEN TREE	12	11/08/21	REVISED PER ACOE COMMENTS
	13	11/23/21	REVISED PER ACOE COMMENTS
ALEBO DE EN OLIDILID	14	12/14/21	REVISED PER OCDOH COMMENTS
VERGREEN SHRUB	15	02/22/22	REVISED PER OCDOH COMMENTS
	16	07/11/22	REVISED PER MHE COMMENTS
	17	08/10/22	REVISED PER MHE COMMENTS
	18	08/24/22	REVISED PER MHE COMMENTS
	19	01/18/23	REVISED HEADWALL
	20	01/27/23	REVISED UTILITIES
	21	05/08/23	REVISED PER NEW BUILDING LAYOUT

DRAWING STATUS	05/08/2023		
THIS SHEET IS PART OF THE PLAN SET ISSUED FOR	SHEET NUMBER		
CONCEPT APPROVAL	N/A	OF	N/A
☑PLANNING BOARD APPROVAL	11	OF	22
OCDOH REALTY SUBDIVISION APPROVAL	N/A	OF	N/A
OCDOH WATERMAIN EXTENSION APPROVAL	N/A	OF	9
NYSDEC APPROVAL	11	OF	22
NYSDOT APPROVAL	N/A	OF	N/A
OTHER	N/A	OF	2
☐ FOR BID	N/A	OF	N/A
FOR CONSTRUCTION	N/A	OF	N/A
THIS PLAN SET HAS BEEN ISSUED SPECIFICALLY FOR THE APPROVAL OR ACTION NOTED ABOVE AND SHALL NOT BE USED FOR ANY OTHER PURPOSE. THIS SHEET SHALL BE CONSIDERED INVALID UNLESS ACCOMPANIED BY ALL SHEETS OF THE DENOTED PLAN SET(S).			

CONSIDERED INVALID. UNAUTHORIZED ALTERATIONS OR ADDITIONS TO THIS DOCUMENT BEARING THE SEAL OF A LICENSED PROFESSIONAL ENGINEER IS A VIOLATION OF SECTION 7209 SUBSECTION 2 OF THE NEW YORK STATE EDUCATION LAW. JAY SAMUELSON, P.E. NEW YORK LICENSE # 080023


1 inch = 30 ft.


LANDSCAPE PLAN 599 E. MAIN ST. - RDM WAREHOUSE (LOT 2) 599 EAST MAIN STREET TOWN OF WALLKILL


ORANGE COUNTY, NEW YORK 1"=30' **C-110**


21 - 05/08/2023 78-1-94.1 TOWN OF WALLKILL PB SHEET 11 OF 27


SEE MIXTURES BY ERNST CONSERVATION SEEDS, WWW.EARNSTSEED.COM.

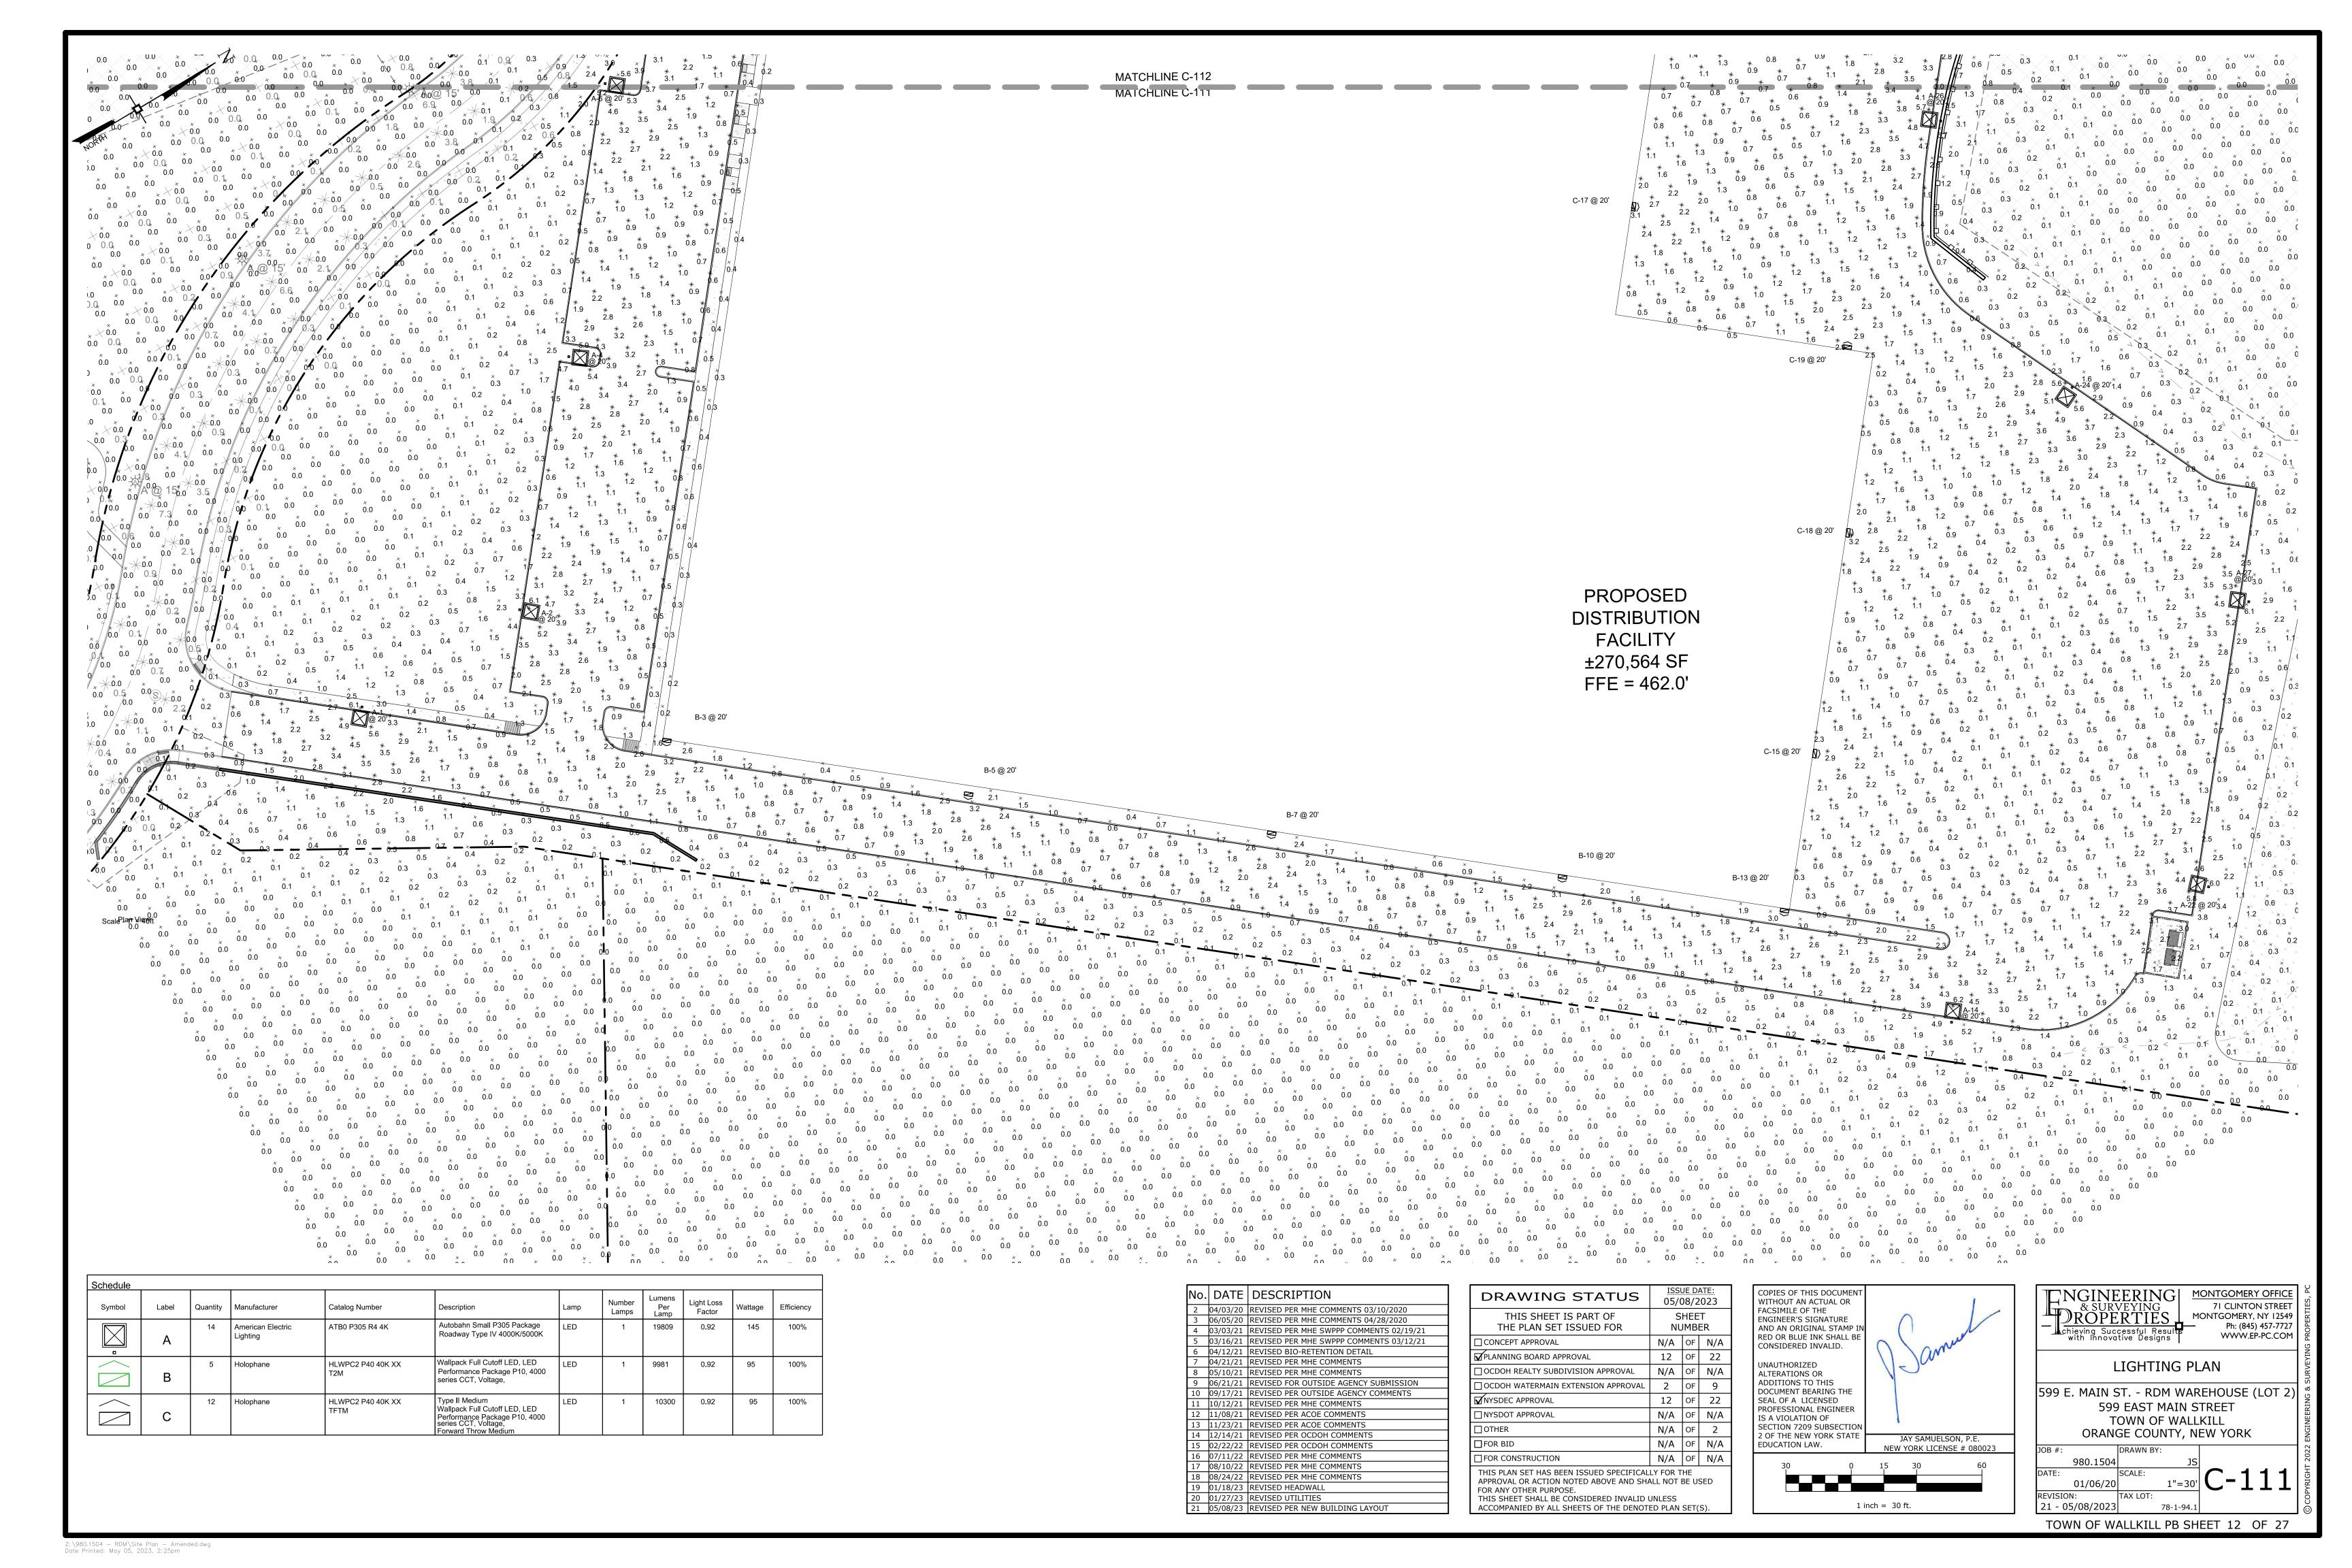

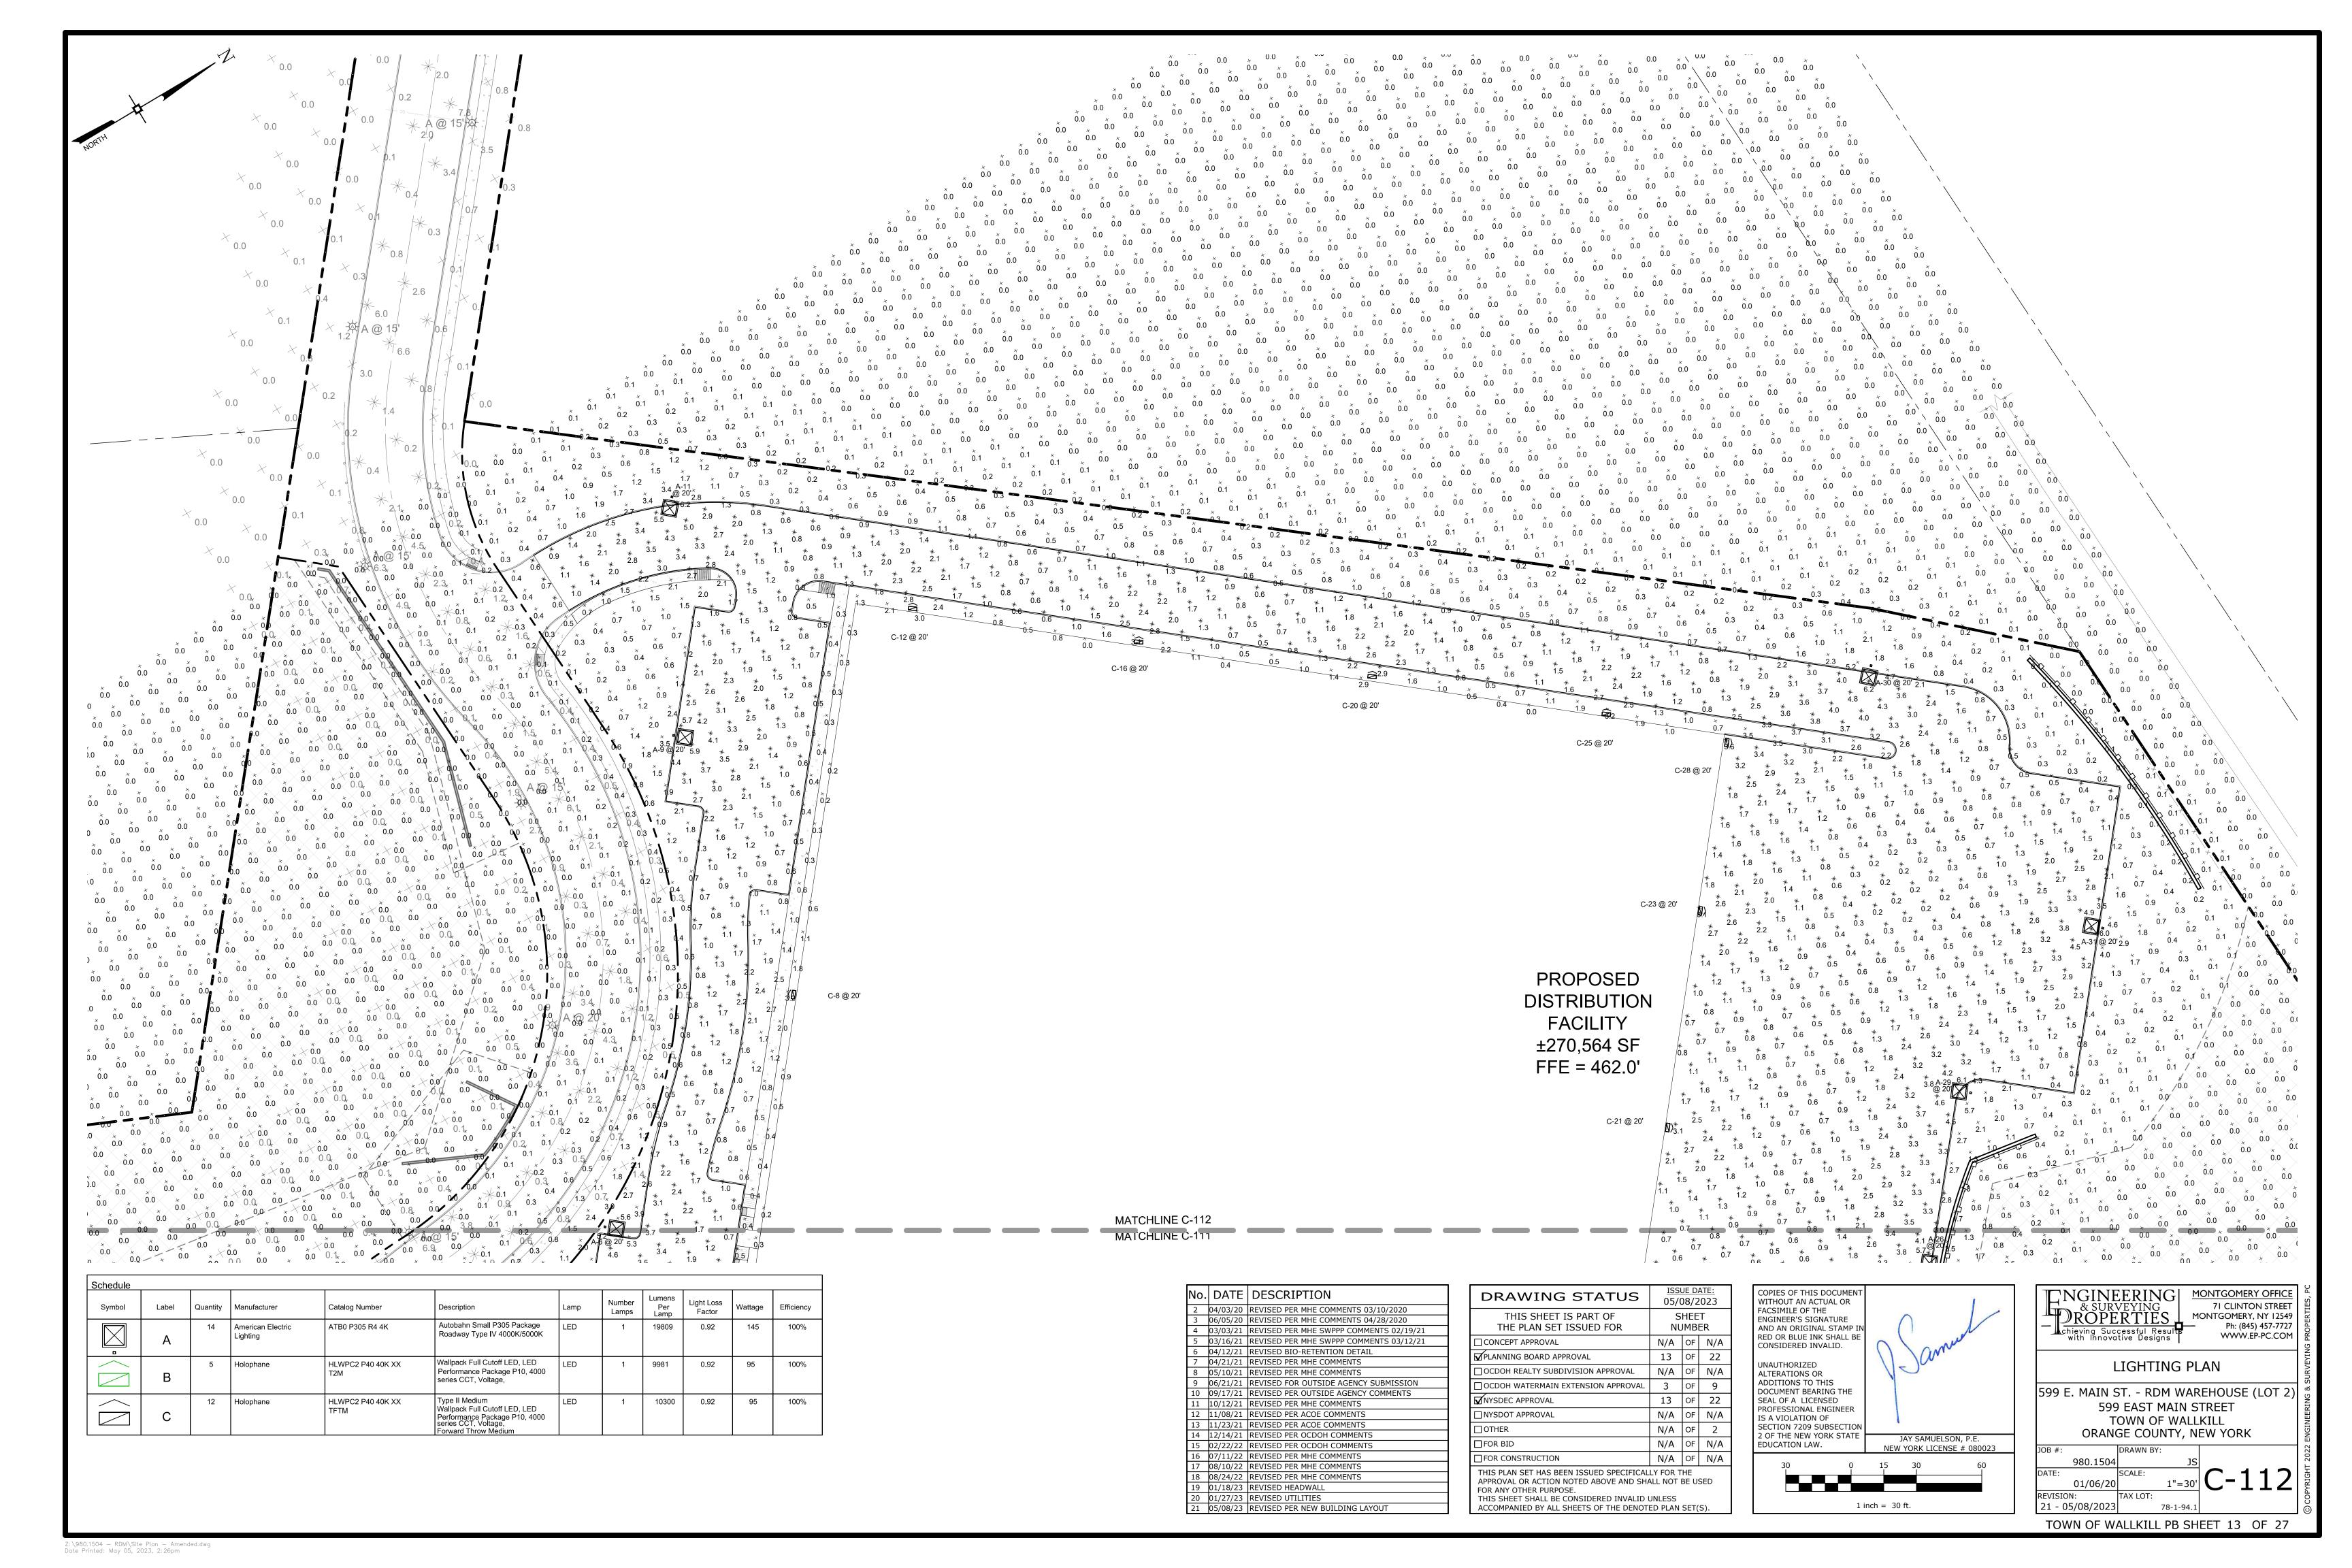

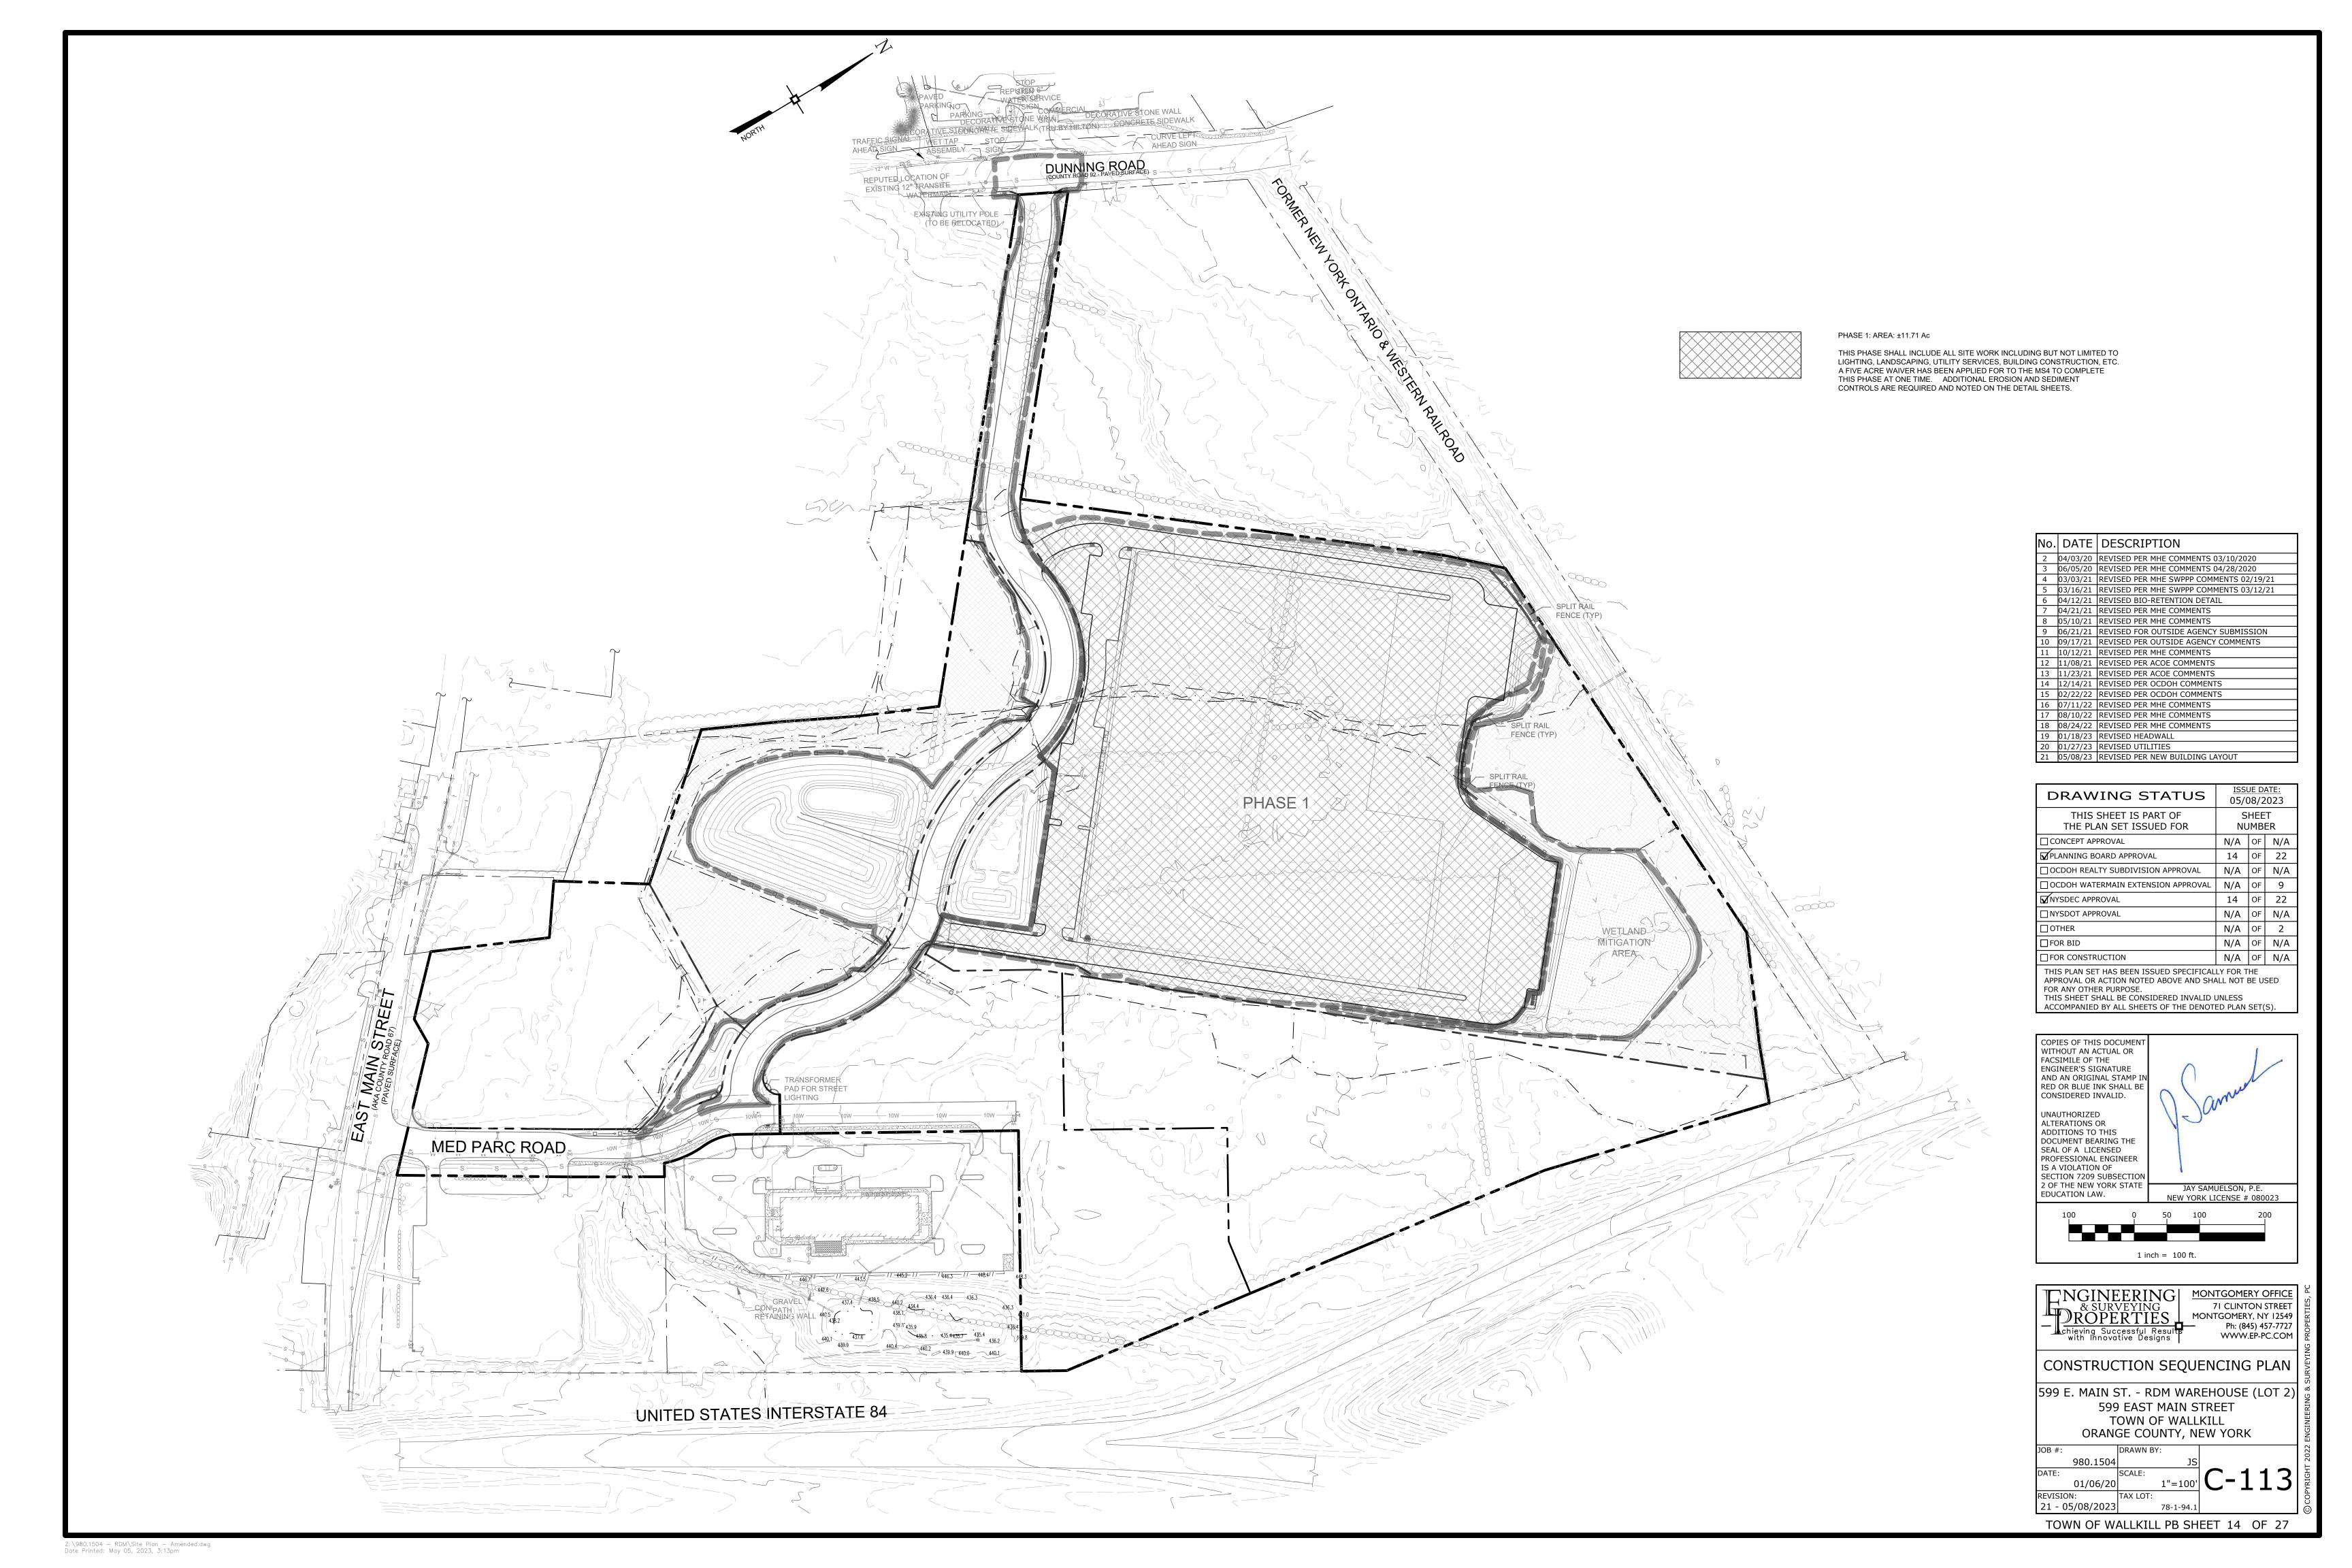

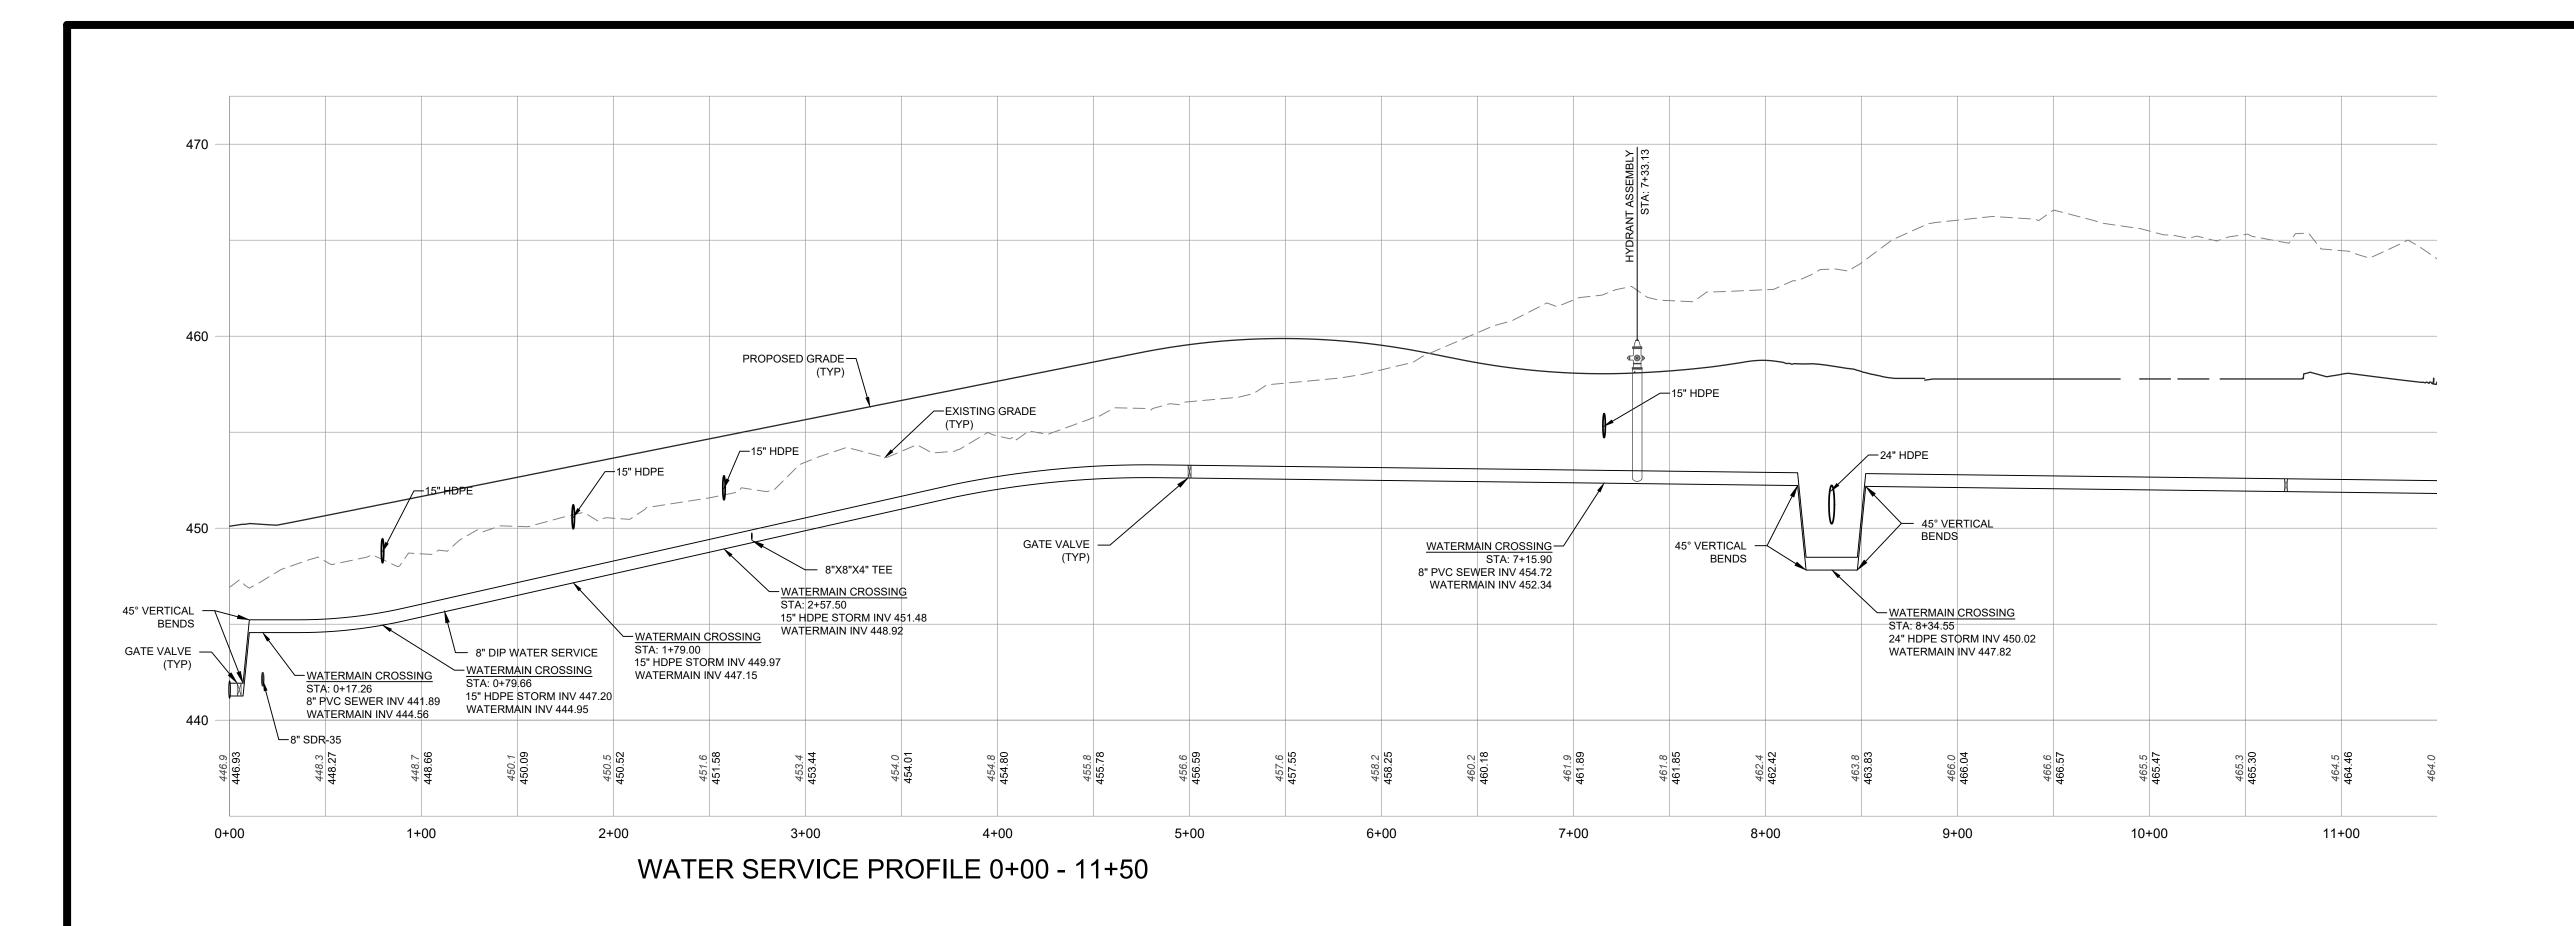

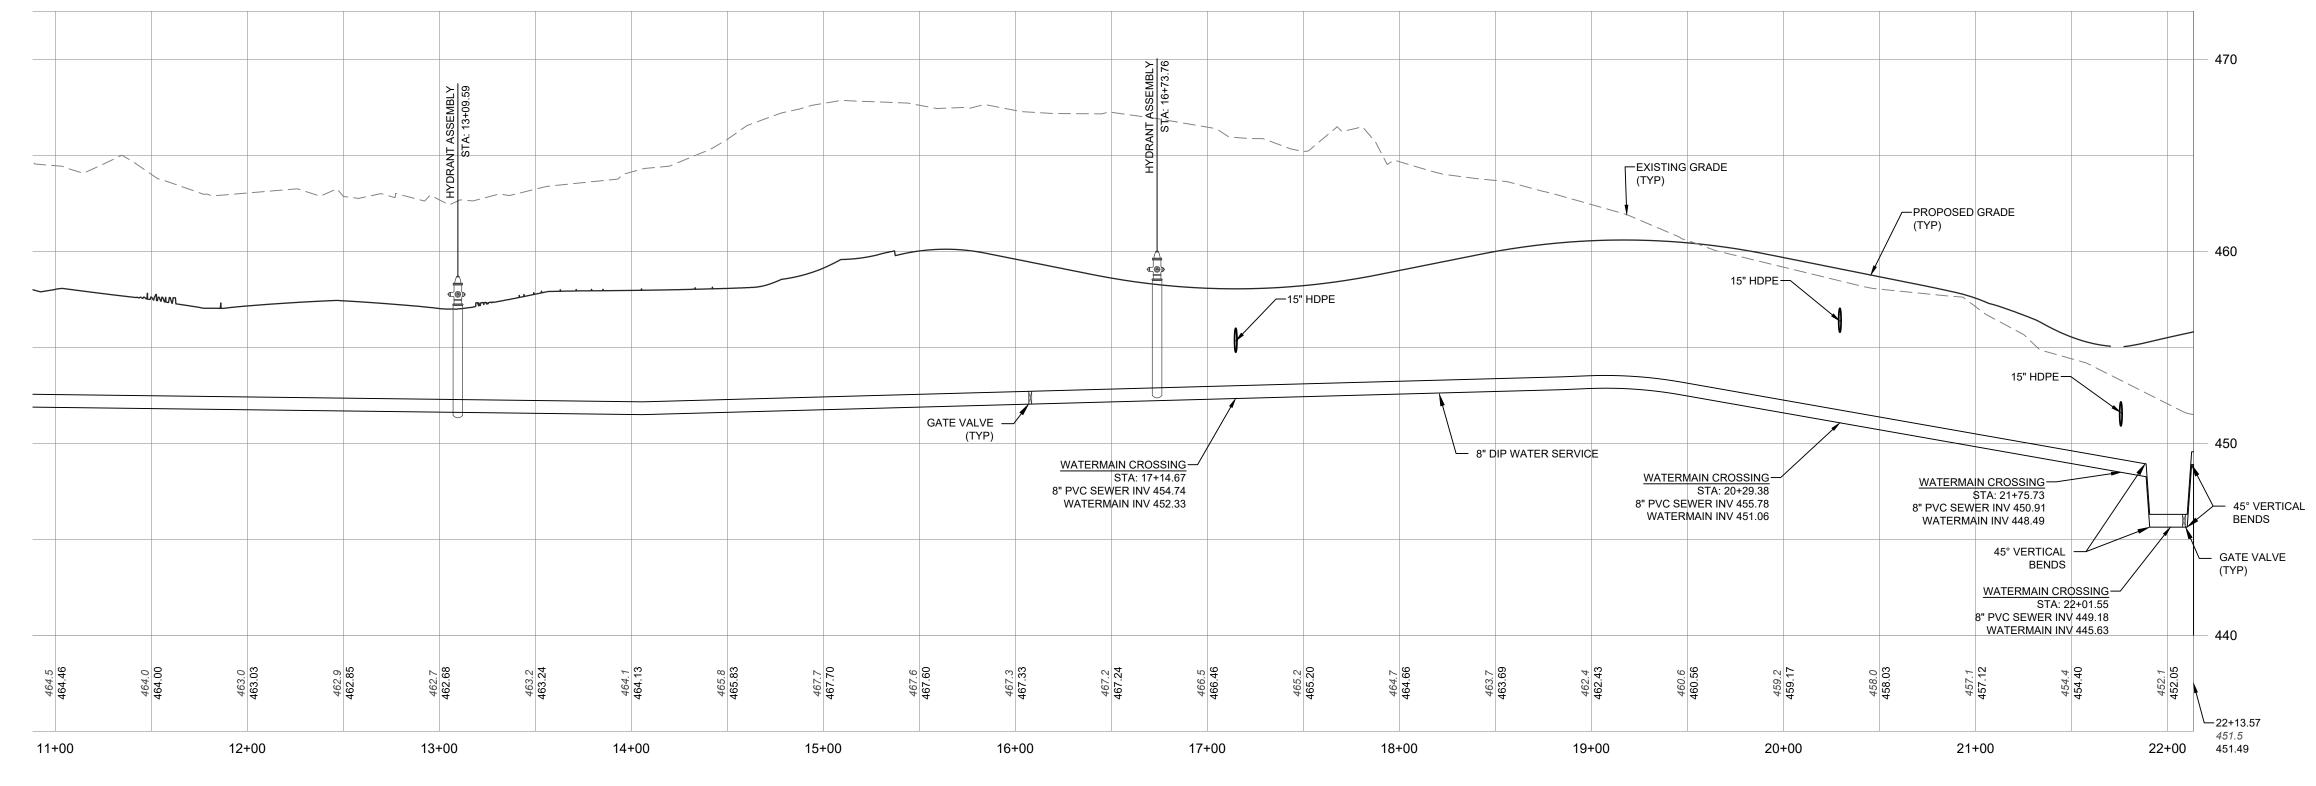


WATER SERVICE PROFILE 11+50 - END

No.	DATE	DESCRIPTION
1	03/20/20	REVISED FOR OCDPW SUBMISSION
2	04/03/20	REVISED PER MHE COMMENTS 03/10/2020
3	06/05/20	REVISED PER MHE COMMENTS 04/28/2020
4	03/03/21	REVISED PER MHE SWPPP COMMENTS 02/19/21
5	03/16/21	REVISED PER MHE SWPPP COMMENTS 03/12/21
6	04/12/21	REVISED BIO-RETENTION DETAIL
7	04/21/21	REVISED PER MHE COMMENTS
8	05/10/21	REVISED PER MHE COMMENTS
9	06/21/21	REVISED FOR OUTSIDE AGENCY SUBMISSION
10	09/17/21	REVISED PER OUTSIDE AGENCY COMMENTS
11	10/12/21	REVISED PER MHE COMMENTS
12	11/08/21	REVISED PER ACOE COMMENTS
13	11/23/21	REVISED PER ACOE COMMENTS
14	12/14/21	REVISED PER OCDOH COMMENTS
15	02/22/22	REVISED PER OCDOH COMMENTS
16	07/11/22	REVISED PER MHE COMMENTS
17	08/10/22	REVISED PER MHE COMMENTS
18	08/24/22	REVISED PER MHE COMMENTS
19	01/18/23	REVISED HEADWALL
20	01/27/23	REVISED UTILITIES

No.	DATE	DESCRIPTION
21	05/08/23	REVISED PER NEW BUILDING LAYOUT.


DRAWING STATUS		JE DA 03/2	ATE: 2023
THIS SHEET IS PART OF THE PLAN SET ISSUED FOR	_	HEE JMB	
☐ CONCEPT APPROVAL	N/A	OF	N/A
☑ PLANNING BOARD APPROVAL	15	OF	22
OCDOH REALTY SUBDIVISION APPROVAL	N/A	OF	N/A
OCDOH WATERMAIN EXTENSION APPROVAL	8	OF	9
☑ NYSDEC APPROVAL	15	OF	22
□ NYSDOT APPROVAL	N/A	OF	N/A
□OTHER	N/A	OF	2
☐FOR BID	N/A	OF	N/A
☐ FOR CONSTRUCTION	N/A	OF	N/A
THIS PLAN SET HAS BEEN ISSUED SPECIFICAL APPROVAL OR ACTION NOTED ABOVE AND SHAFOR ANY OTHER PURPOSE. THIS SHEET SHALL BE CONSIDERED INVALID ACCOMPANIED BY ALL SHEETS OF THE DENOT	ALL NOT	BE U	

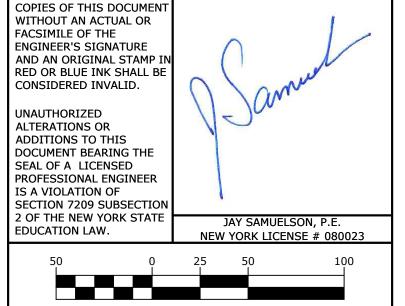


1 inch = 50 ft.

mul	**MONTGOMERY OFFICE TO CHIEF TO CHIEF THE PROPERTIES OF THE PROPER
ν,	WATERMAIN PROFILE
	599 E. MAIN ST RDM WAREHOUSE (LOT 2 599 EAST MAIN STREET TOWN OF WALLKILL ORANGE COUNTY, NEW YORK
ELSON, P.E. CENSE # 080023	JOB #: DRAWN BY:
100	980.1504 JS DATE: SCALE: 1"=50' H 01/06/20 1" = 5' V REVISION: TAX LOT: 21 - 05/08/2023 78-1-94.1

TOWN OF WALLKILL PB SHEET 15 OF 27

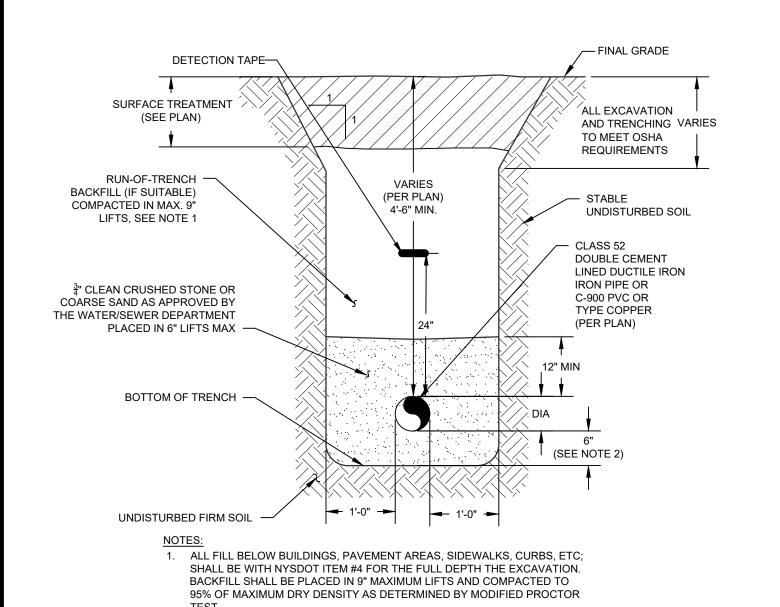


2. IF ROCK IS ENCOUNTERED DURING EXCAVATION OF THE TRENCH, THE PIPE BEDDING SHALL BE INCREASED TO 8" THICK. WATER PIPE TRENCH

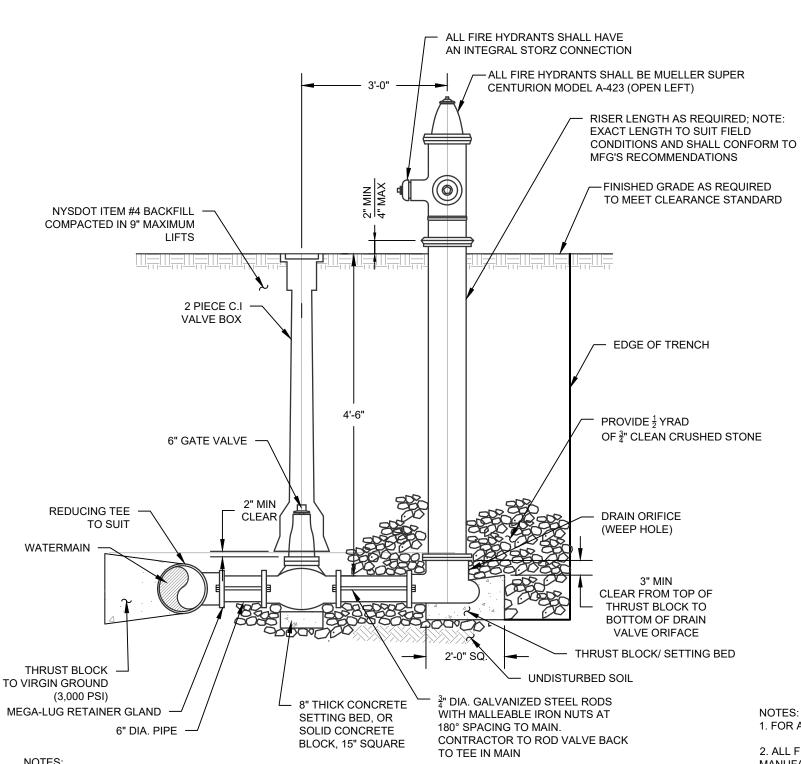


- HYDRANTS SHALL BE DRY-BARREL HYDRANTS, TYPE MUELLER SUPER CENTURION, IN ACCORDANCE WITH AWWA C502. HYDRANTS SHALL HAVE A MAIN VALVE SIZE OPENING OF FIVE INCHES NORMAL, ONE FOUR-AND-A-HALF INCH NST PUMPER NOZZLE, TWO TWO-AND-A-HALF INCH NST NOZZLES, A ONE-AND-ONE-HALF INCH PENTAGON OPERATING NUTS AND A SIX-INCH MECHANICAL JOINT INLET SHOW CONNECTION WITH ACCESSORIES. THE HYDRANT DIRECTION OF OPENING SHALL BE LEFT (COUNTERCLOCKWISE)
- 2. ALL TEES, VALVES AND FITTINGS TO INCLUDE RESTRAINT IN THE FORM OF MEGA-LUG RETAINER GLANDS AND RODS.
- 3. HYDRANT SPACING MAY RANGE FROM 350' TO A MAXIMUM OF 600'.
- 4. THE WEEP HOLE SHALL BE PLUGGED IF GROUNDWATER IS ENCOUNTERED WITHIN TWO (2) FEET OF THE BASE OF THE HYDRANT. IF PLUGGED, PERMANENT SIGNAGE SHALL BE AFFIXED TO THE HYDRANT SPECIFYING THAT HYDRANT SHALL BE REQUIRED BE PUMPED DRY AFTER USE DURING PERIODS OF FREEZING TEMPERATURES.


HYDRANT ASSEMBLY

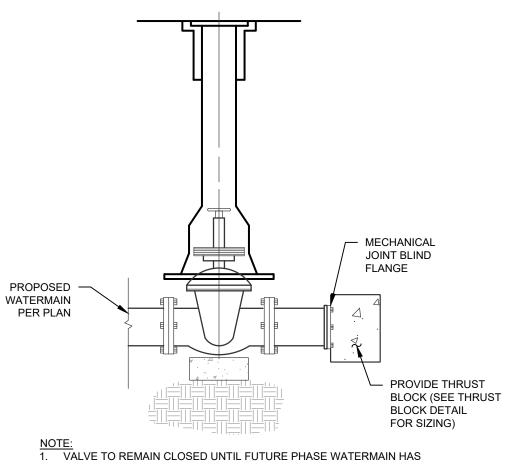

BEEN SAMPLED AND PRESSURE TESTED.

WATER PIPE CAP

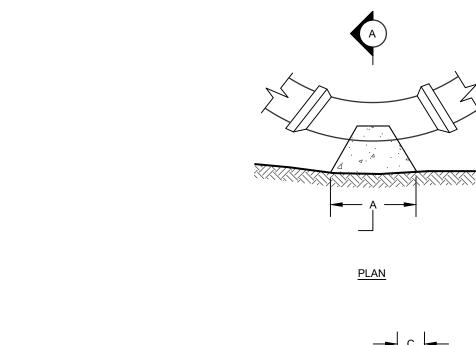

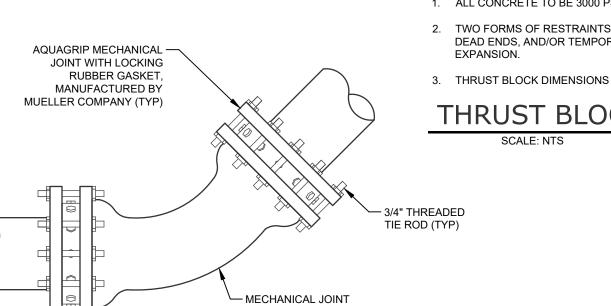


1. FOR ALL "T"'S, NO UNRESTRAINED JOINTS WITHIN 5 FEET OF FITTING


2. ALL FITTINGS ARE TO BE RESTRAINED WITH AQUAGRIP MECHANIC JOINTS WITH LOCKING RUBBER GASKETS AS MANUFACTURED BY MUELLER COMPANY. IN ADDITION ALL PIPE JOINTS SHALL BE RESTRAINED AS FOLLOWS:

8" DIP RESTRAIN	ITS*
45°	ALL JOINTS WITHIN 9 FEET OF FITTING
22.5°	ALL JOINTS WITHIN 4 FEET OF FITTING
11.25°	ALL JOINTS WITHIN 2 FEET OF FITTING
8X4 TEE	ALL 8" BRANCH JOINTS WITHIN 2 FEET OF FITTI
8X6 TEE	ALL 8" BRANCH JOINTS WITHIN 2 FEET OF FITTI
DEAD END	ALL JOINTS WITHIN 43 FEET OF FITTING
(BLIND FLANGE)	

* ASSUMED: 4'-6" COVER, 150 PSI TEST PRESSURE, AND 2.0 TO 1 FACTOR OF SAFETY.

PIPE RESTRAINT DETAIL

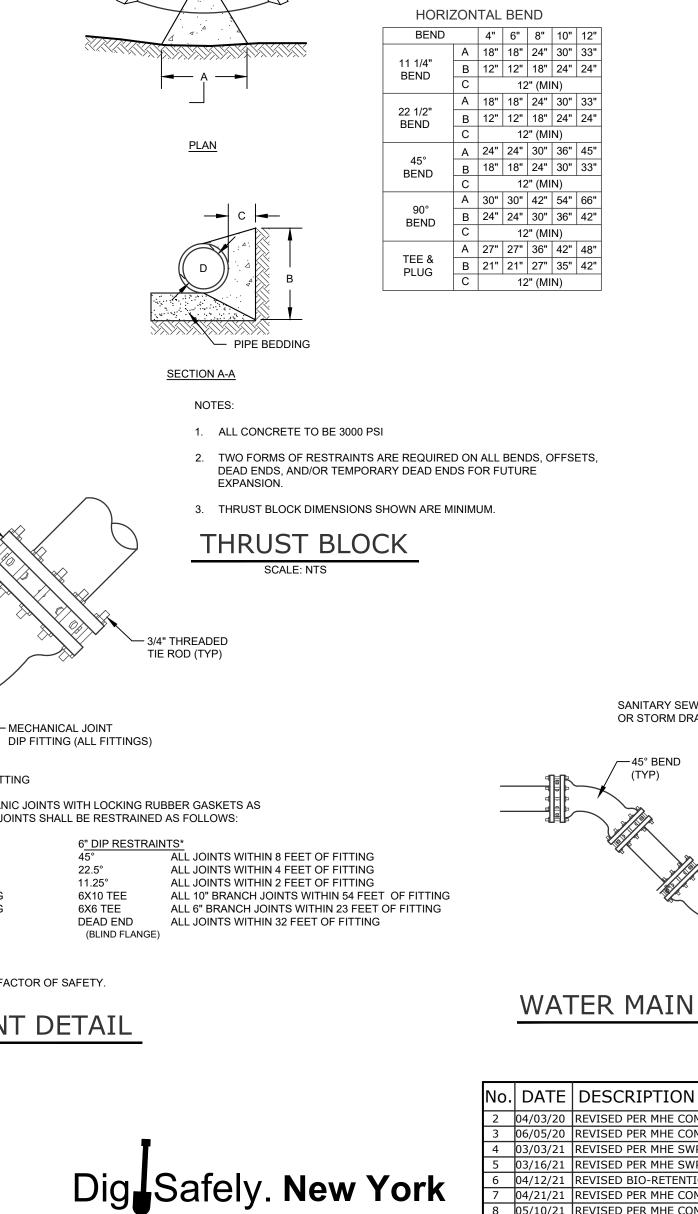

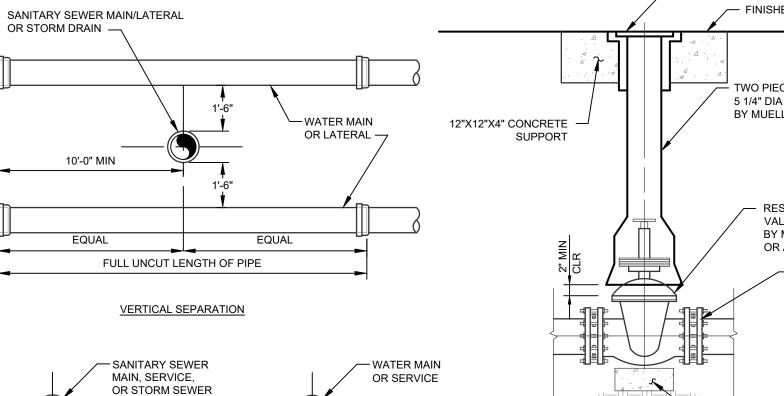

4" D.I.P. FIRE ─

SUPPRESSION

CONNECTION

4" GATE VALVE -

(SEE DETAIL)

BEND

2" GATE VALVE -

(SEE DETAIL)

DOMESTIC

WATER SERVICE CONNECTIONS

CONNECTION

SERVICE

NO DEVIATION IN THE SEPARATION REQUIREMENTS WILL BE PERMITTED WITHOUT APPROVAL OF THE ORANGE COUNTY DEPARTMENT OF HEALTH.

10'-0" MIN (EDGE TO EDGE)

HORIZONTAL SEPARATION

WATER/SEWER SEPARATION REQUIREMENTS

EXISTING

WATERMAIN

4" D.I.P. WATER -

WATERMAIN

└─ 4" GATE VALVE

(SEE DETAIL)

SERVICE FROM

WET TAP

ASSEMBLY


(SEE DETAIL)

4"x4"x2"

BEND

MECHANIC

JOINT TEE

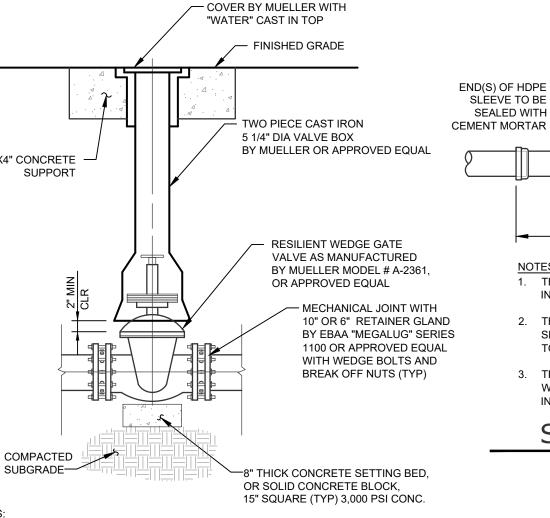

1. ALL VALVES TO INCLUDE MEGA-LUG RETAINER GLANDS AND BE RODDED BACK TO THE ADJACENT TEE IN THE WATERMAIN. INLINE VALVES NEED NOT BE RODDED. CONTRACTOR TO UTILIZE $\frac{3}{4}$ " DIA. GALVANIZED STEEL RODS WITH MALLEABLE IRON NUTS AT 180° SPACING.

2. WATERMAIN VALVES FOR FOUR INCH THROUGH FORTY EIGHT INCH SHALL BE RESILIENT WEDGE GATE VALVES AS MANUFACTURED BY MUELLER, MODEL #A-2361. VALVES SHALL BE PROVIDED WITH AN EXTENSION SERVICE BOX TO GRADE.

3. MAIN LINE VALVES TO BE SPACED TO NO FURTHER THAN 500 FEET APART IN COMMERCIAL DISTRICTS AND 800 FEET IN OTHER DISTRICTS.

CONNECT TO BUILDING FIRE

SUPPRESSION SYSTEM

CONNECT TO BUILDING

DOMESTIC SERVICE

(DESIGN BY OTHERS)

WATER METER


(APPROVED BY TOWN

OF WALLKILL WATER

(DESIGN BY OTHERS)

VALVE AND VALVE BOX

BUILDING

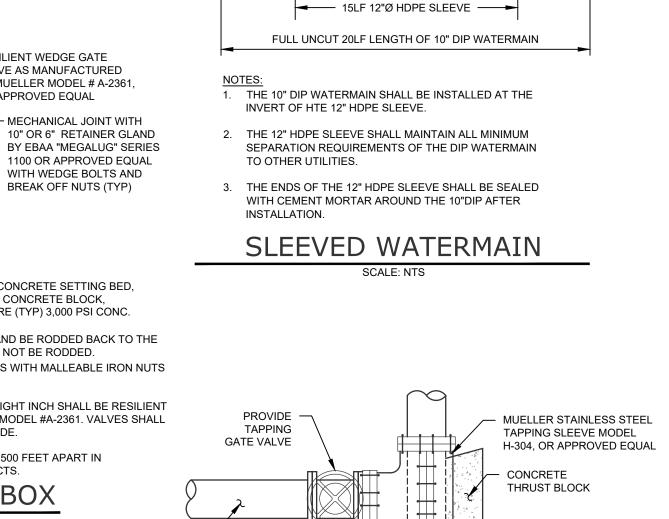

- DUAL 24" HDPE

3' MIN

(TYP)

WATERMAIN

DRAINAGE CROSSING

- WATER MAIN

- 1. WET TAP INSTALL TO BE PERFORMED BY CONTRACTOR WITH ENGINEER OR REPRESENTATIVE OF TOWN OF WALLKILL WATER DEPARTMENT ON SITE. 2. CONTRACTOR TO CONTACT TOWN OF WALLKILL WATER DEPARTMENT FOR
- INSTALLATION REQUIREMENTS. 3. ALL TAPPING SLEEVE HARDWARE SHALL BE STAINLESS STEEL

WATER SYSTEM NOTES

PROPOSED WATER

SERVICE / MAIN

- 1. CONTRACTOR SHALL VERIFY THE LOCATION AND ELEVATION OF EXISTING WATER AND SEWER UTILITIES PRIOR TO THE COMMENCEMENT OF CONSTRUCTION.
- 2. CONTRACTOR TO CALL UNDERGROUND MARK-OUT AT LEAST 2 DAYS PRIOR TO COMMENCEMENT OF CONSTRUCTION AT 1-800-962-7962 FOR COMPLETE UTILITIES MARKOUT.
- 3. CONTRACTOR TO CONTACT TOWN OF WALLKILL WATER DEPARTMENT AT (845) 342-1668 AT LEAST 2 DAYS PRIOR TO CONSTRUCTION.
- 4. WATER MAIN 4" OR LARGER TO BE CLASS 52 BITUMINOUS COATED DOUBLE CEMENT LINED DUCTILE IRON PIPE.
- 5. CONTRACTOR TO NOTIFY ENGINEER IMMEDIATELY OF ANY DEVIATION FROM HORIZONTAL OR VERTICAL ALIGNMENTS WITH REGARDS TO EXISTING UTILITIES BEFORE PROCEEDING.
- 6. A CERTIFIED AS BUILT MAP OF THE WATER SYSTEM IMPROVEMENTS SHALL BE PROVIDED TO THE TOWN OF WALLKILL WATER DEPARTMENT BY A LICENSED DESIGN PROFESSIONAL.
- 7. THIS PROJECT HAS DEMONSTRATED AN MINIMUM AVAILABLE FLOW OF 3,430 GALLONS PER MINUTE WHILE MAINTAINING A MINIMUM OF 20 PSI AT ALL POINTS IN THE DISTRIBUTION SYSTEM. THIS VALUE SHOULD BE COMPARED TO THE NEEDED FIRE FLOW (NFF) FOR THE PROPOSED CONSTRUCTION IN ACCORDANCE WITH THE INSURANCE SERVICES OFFICE (ISO) GUIDELINES. PER THE RECOMMENDED STANDARDS FOR WATER WORKS (NYS SANITY CODE PART 5, APPENDIX 5-A). THE NEEDED FIRE FLOW FOR THE PROPOSED CONSTRUCTION IS 500
- GPM AAS PER ISO GUIDELINES. 8. ALL PIPE, FIXTURES AND FITTINGS MUST COMPLY WITH THE FEDERAL "SAFE DRINKING WATER ACT", SECTION 1417 WHICH REQUIRES ALL SURFACES IN CONTACT WITH POTABLE WATER CONTAIN NO MORE THAN 0.25% LEAD BY WEIGHT.
- 9. THE TOWN OF WALLKILL COMMISSIONER OF PUBLIC WORKS OR HIS DESIGNATED REPRESENTATIVE MUST BE INFORMED OF ANY HYDROSTATIC OR BACTERIOLOGICAL TESTING TO PERMIT THE TESTING TO BE WITNESSED.
- 10. THE TOWN OF WALLKILL COMMISSIONER OR PUBLIC WORKS OR HIS DESIGNATED REPRESENTATIVE MUST ACCEPT HYDROSTATIC AND BACTERIOLOGICAL TEST RESULTS AS
- 11. THE PROPOSED WATERMAIN SHALL BE INSTALLED IN ACCORDANCE WITH ALL TOWN OF WALLKILL REQUIREMENTS. THE PROPOSED WATERMAIN SHALL BE OWNED AND MAINTAINED BY THE PROJECT SPONSOR.
- 12. A SEPARATE APPLICATION IS TO BE PROVIDED TO THE ORANGE COUNTY DEPARTMENT OF HEALTH FOR REVIEW AND APPROVAL FOR BACKFLOW PREVENTION PROTECTION FOR THE WAREHOUSE DOMESTIC AND FIRE SERVICE LINES.



SANITARY SEWER MAIN/LATERAL

OR STORM DRAIN -

-45° BEND




No.	DATE	DESCRIPTION
2	04/03/20	REVISED PER MHE COMMENTS 03/10/2020
3	06/05/20	REVISED PER MHE COMMENTS 04/28/2020
4	03/03/21	REVISED PER MHE SWPPP COMMENTS 02/19/21
5	03/16/21	REVISED PER MHE SWPPP COMMENTS 03/12/21
6	04/12/21	REVISED BIO-RETENTION DETAIL
7	04/21/21	REVISED PER MHE COMMENTS
8	05/10/21	REVISED PER MHE COMMENTS
9	06/21/21	REVISED FOR OUTSIDE AGENCY SUBMISSION
10	09/17/21	REVISED PER OUTSIDE AGENCY COMMENTS
11	10/12/21	REVISED PER MHE COMMENTS
12	11/08/21	REVISED PER ACOE COMMENTS
13	11/23/21	REVISED PER ACOE COMMENTS
14	12/14/21	REVISED PER OCDOH COMMENTS
15	02/22/22	REVISED PER OCDOH COMMENTS
16	07/11/22	REVISED PER MHE COMMENTS
17	08/10/22	REVISED PER MHE COMMENTS
18	08/24/22	REVISED PER MHE COMMENTS
19	01/18/23	REVISED HEADWALL
20	01/27/23	REVISED UTILITIES
21	05/08/23	REVISED PER NEW BUILDING LAYOUT

DRAWING STATUS	ISSUE DATE: 05/08/2023		
THIS SHEET IS PART OF THE PLAN SET ISSUED FOR	SHEET NUMBER		
CONCEPT APPROVAL	N/A	OF	N/A
☑PLANNING BOARD APPROVAL	16	OF	22
OCDOH REALTY SUBDIVISION APPROVAL	N/A	OF	N/A
OCDOH WATERMAIN EXTENSION APPROVAL	9	OF	9
NYSDEC APPROVAL	16	OF	22
NYSDOT APPROVAL	N/A	OF	N/A
OTHER	N/A	OF	2
☐ FOR BID	N/A	OF	N/A
☐ FOR CONSTRUCTION	N/A	OF	N/A
THIS PLAN SET HAS BEEN ISSUED SPECIFICAL APPROVAL OR ACTION NOTED ABOVE AND SHAFOR ANY OTHER PURPOSE.			SED


THIS SHEET SHALL BE CONSIDERED INVALID UNLESS


ACCOMPANIED BY ALL SHEETS OF THE DENOTED PLAN SET(S).

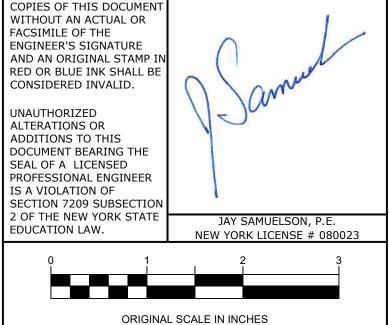

L	**MONTGOMERY OFFICE 71 CLINTON STREET MONTGOMERY, NY 12549 Ph: (845) 457-7727 WWW.EP-PC.COM			
	DETAILS			
I, P.E.	599 E. MAIN ST RDM WAREHOUSE (LOT 2) 599 EAST MAIN STREET TOWN OF WALLKILL ORANGE COUNTY, NEW YORK			
# 080023	JOB #: DRAWN BY: 980.1504 JS DATE: SCALE: 01/06/20 AS NOTED REVISION: TAX LOT: 78-1-94.1			
TOWN OF WALLKILL PB SHEET 16 OF 27				

2: \980.1504 — RDM\Details.dwg Date Printed: May 04, 2023, 2:26pm

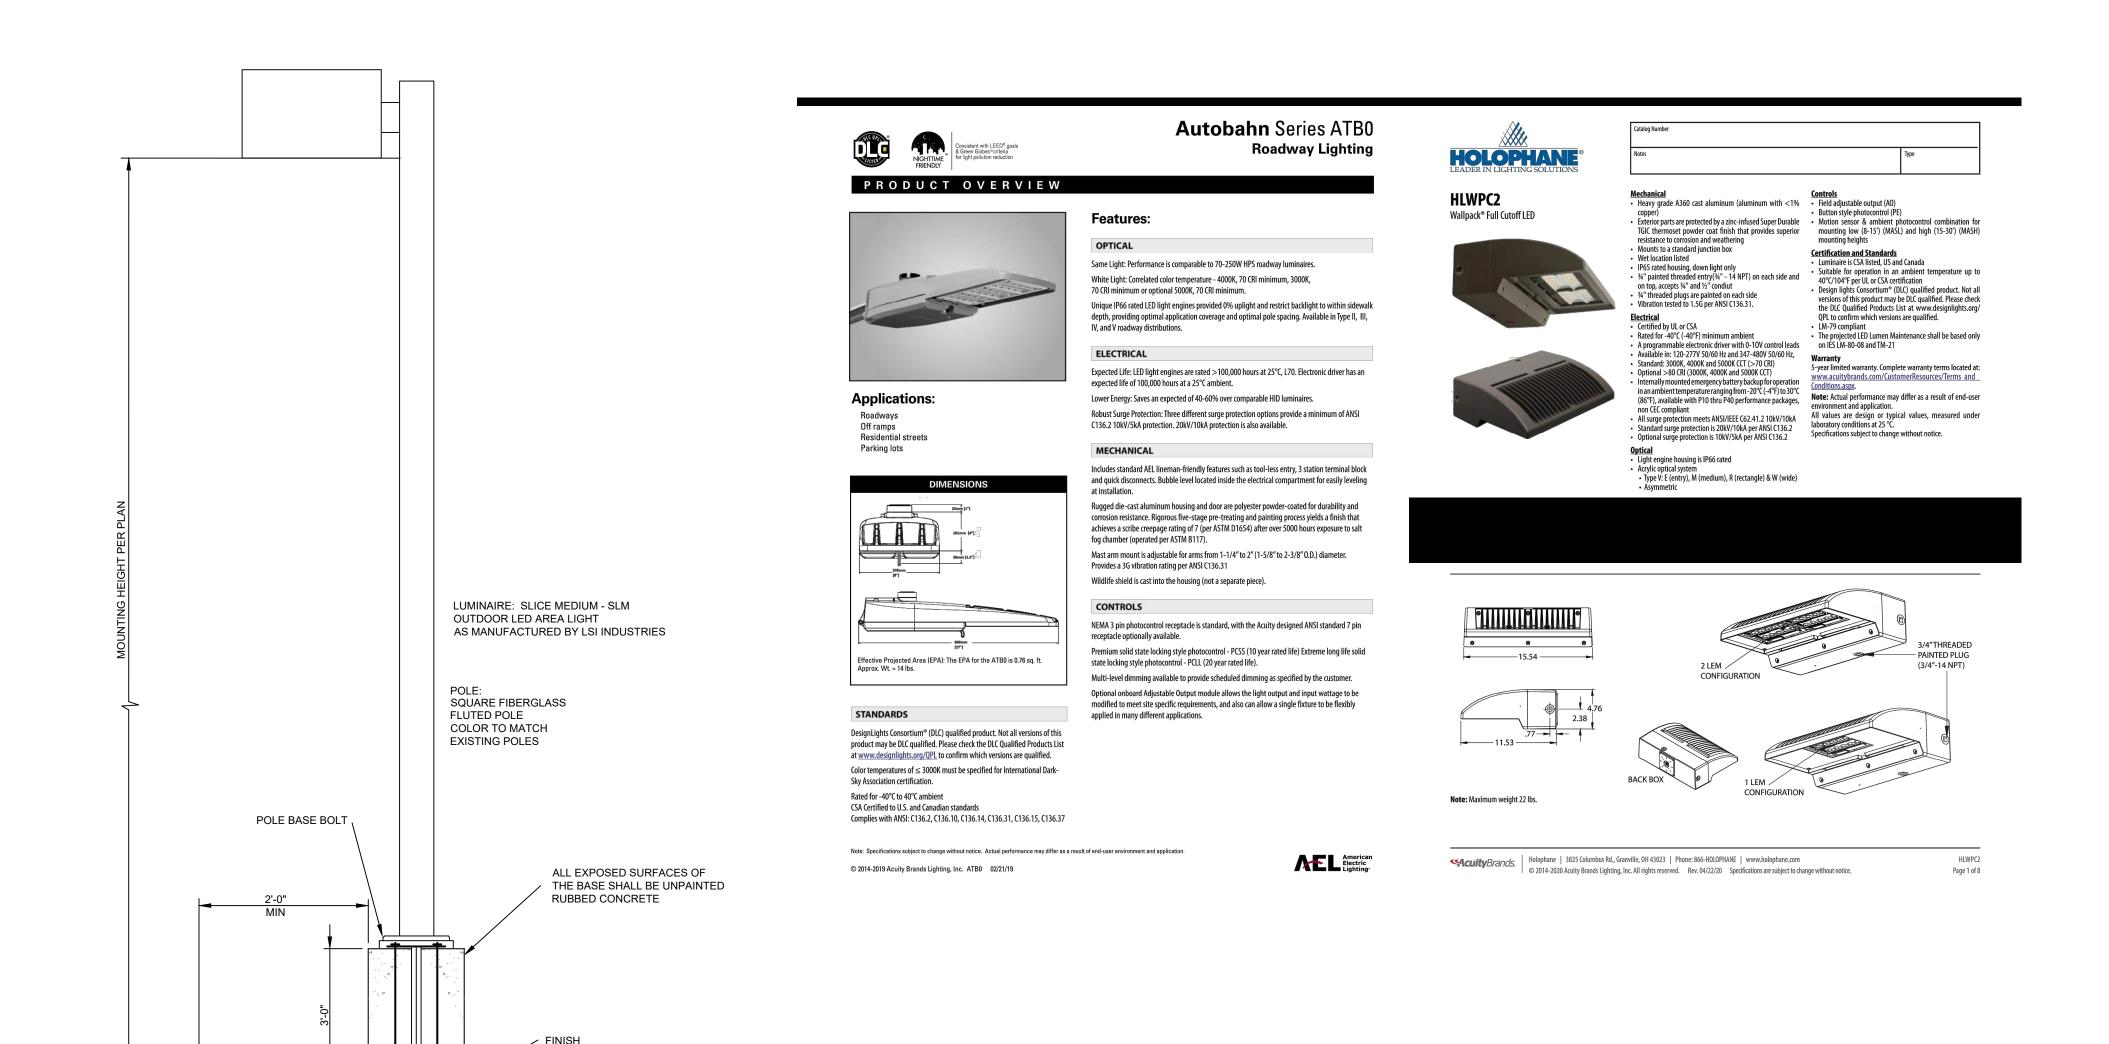

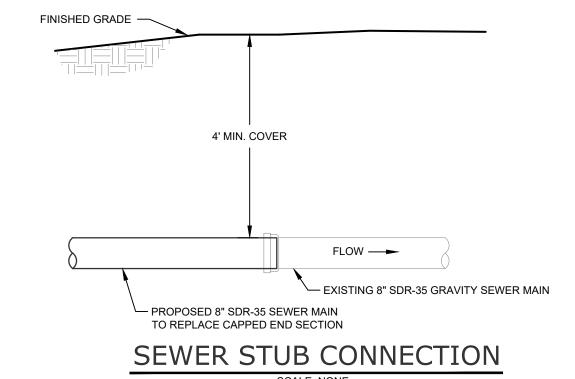

CAP/PLUG FINISHED GRADE SEWER SYSTEM NOTES ROUND HDPE VALVE BOX 1. ALL GRAVITY SEWER PIPE SHALL BE SDR-35 PVC AND ALL FORCEMAIN SEWER PIPE SHALL BE SDR-26 PVC. 2. IF GROUNDWATER IS ENCOUNTERED DURING TRENCH EXCAVATION, THE CONTRACTOR - 4" OR 6" PVC RISER SHALL DE-WATER THE TRENCH PRIOR TO INSTALLATION. ALL DE-WATERING OPERATIONS SHALL BE DONE AT THE CONTRACTOR'S EXPENSE. 3. CONTRACTOR TO VERIFY INVERT ELEVATIONS OF EXISTING SEWER MAIN PRIOR TO - 4" OR 6" PVC WYE COMMENCEMENT OF CONSTRUCTION AND NOTIFY ENGINEER OF ANY DISCREPANCY PRIOR 4" OR 6" PVC TO COMMENCEMENT. 45° BEND —


4. CONTRACTOR SHALL CALL THE TOWN OF WALLKILL SEWER DEPARTMENT (845-342-1668) AT LEAST TWO DAYS PRIOR TO THE COMMENCEMENT OF CONSTRUCTION OF SEWERS.

5. CONTRACTOR SHALL CALL UNDERGROUND MARKOUT AT 1-800-962-7962 AT LEAST TWO DAYS PRIOR TO THE COMMENCEMENT OF CONSTRUCTION OF SEWERS FOR COMPLETE UTILITY MARKOUT.

6. THE SANITARY SEWER SYSTEM SHALL BE TESTED IN ACCORDANCE WITH TOWN OF WALLKILL TOWN CODE SECTION 194-26, INCLUDING BUT NOT LIMITED TO VACUUM TESTING OF MANHOLES, LOW PRESSURE AIR TEST OF MAINS AND LATERALS, AND VIDEO RECORDING


7. THE PROPOSED SEWERMAIN SHALL BE INSTALLED IN ACCORDANCE WITH ALL TOWN OF WALLKILL REQUIREMENTS. THE PROPOSED SEWERMAIN SHALL BE OWNED AND MAINTAINED BY THE PROJECT SPONSOR.

COPIES OF THIS DOCUMENT

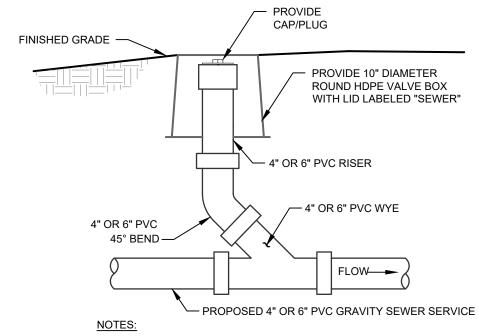

1. CLEANOUTS SHALL BE SPACED AT INTERVALS NO

MORE THAN 75 FEET APART.

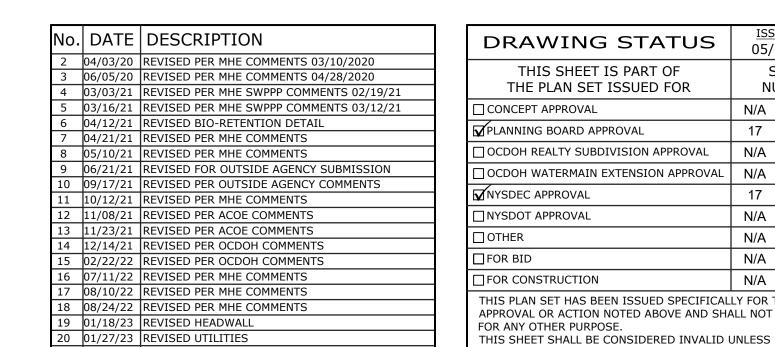

05/08/23 REVISED PER NEW BUILDING LAYOUT

EXISTING

MANHOLE


DRAWING STATUS	ISSUE DATE: 05/08/2023			
THIS SHEET IS PART OF THE PLAN SET ISSUED FOR	SHEET NUMBER			
☐ CONCEPT APPROVAL	N/A	OF	N/A	
☑PLANNING BOARD APPROVAL	17	OF	22	
OCDOH REALTY SUBDIVISION APPROVAL	N/A	OF	N/A	
OCDOH WATERMAIN EXTENSION APPROVAL	N/A	OF	9	
MNYSDEC APPROVAL	17	OF	22	
□NYSDOT APPROVAL	N/A	OF	N/A	
□OTHER	N/A	OF	2	
☐FOR BID	N/A	OF	N/A	
☐ FOR CONSTRUCTION	N/A	OF	N/A	
THIS PLAN SET HAS BEEN ISSUED SPECIFICALLY FOR THE APPROVAL OR ACTION NOTED ABOVE AND SHALL NOT BE USED FOR ANY OTHER PURPOSE.				

ACCOMPANIED BY ALL SHEETS OF THE DENOTED PLAN SET(S).

WITHOUT AN ACTUAL OR FACSIMILE OF THE ENGINEER'S SIGNATURE AND AN ORIGINAL STAMP RED OR BLUE INK SHALL BE CONSIDERED INVALID. UNAUTHORIZED ALTERATIONS OR ADDITIONS TO THIS PROF EDUC

CUMENT BEARING THE L OF A LICENSED FESSIONAL ENGINEER VIOLATION OF TION 7209 SUBSECTION	
F THE NEW YORK STATE ICATION LAW.	JAY SAMUELSON, P.E. NEW YORK LICENSE # 080023
0 1	2 3
ORIGINA	L SCALE IN INCHES

☐NGINEERING| MONTGOMERY OFFICE 71 CLINTON STREET ROPERTIES MO chieving Successful Results with Innovative Designs MONTGOMERY, NY 12549 Ph: (845) 457-7727 WWW.EP-PC.COM **DETAILS** 599 E. MAIN ST. - RDM WAREHOUSE (LOT 2) 599 EAST MAIN STREET TOWN OF WALLKILL ORANGE COUNTY, NEW YORK 980.1504 01/06/20 AS NOTED 21 - 05/08/2023 TOWN OF WALLKILL PB SHEET 17 OF 27

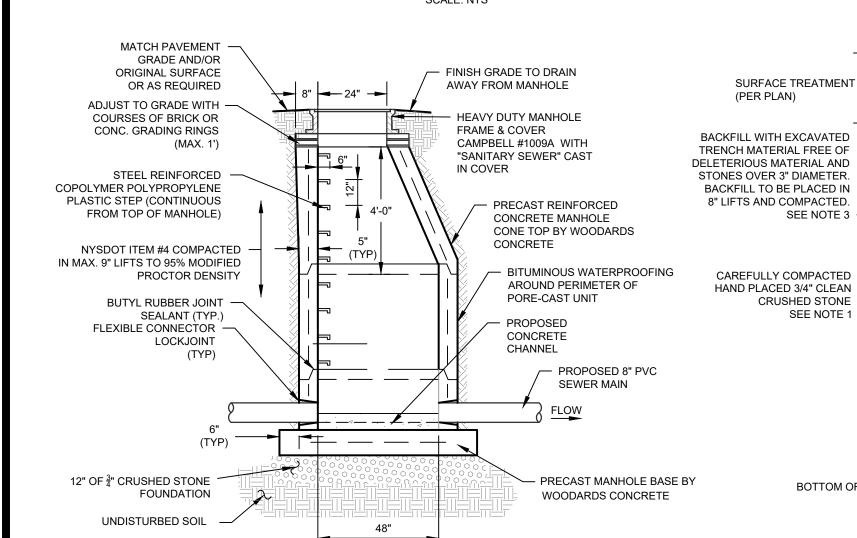

LIGHT

UNDISTURBED SUBGRADE —

— CONDUIT AS


-#6 COPPER GROUND WIRE

LUG IN POLE -3/4"x8'-0" COPPER GROUND ROD

CONNECT TO GROUNDING

- 1. CONCRETE TO HAVE A MINIMUM COMPRESSIVE STRENGTH OF 4000 PSI @ 28 DAYS.
- 2. REINFORCEMENT TO BE IN CONFORMANCE WITH ASTM A615 GRADE 60.
- 3. ALL MANHOLE SECTIONS TO CONFORM WITH ASTM SPECIFICATION C-478
- 4. ALL MANHOLES WITHIN PAVEMENT AREAS SHALL BE DESIGNED TO WITHSTAND HS-25 LOADING.

SEWER MANHOLE

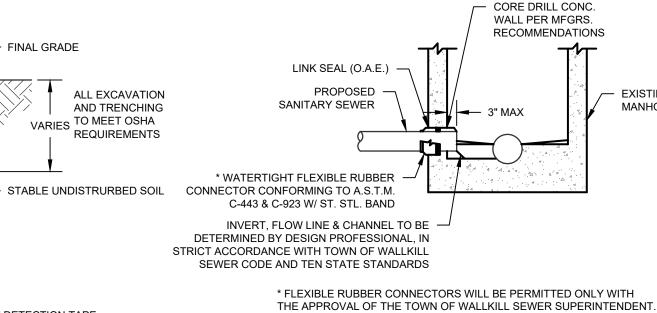

* FLEXIBLE RUBBER CONNECTORS WILL BE PERMITTED ONLY WITH

SEWER MAIN TO MANHOLE CONNECTION DETAIL

SCALE: NTS

SEWER MANHOLE COVER

BOTTOM OF TRENCH

SEE NOTE 3 -

SEE NOTE 1 -

MODIFIED PROCTOR TEST.

1. ALL FILL BELOW BUILDING AND PAVEMENT TO BE COMPACTED TO 95%

MAXIMUM DRY DENSITY AS DETERMINED BY MODIFIED PROCTOR TEST.

2. ALL SEWER MAINS SHALL BE 8" OR 10" SDR 35 PVC. ALL SEWER HEADERS SHALL BE 6" SDR 35 AND ALL SEWER LATERAL TO BE 4" SDR 35 PVC.

3. ALL FILL BELOW BUILDINGS, PAVEMENT AREAS, SIDEWALKS, CURBS, ETC;

SHALL BE WITH ITEM 4 (NYSDOT SPEC) FOR THE FULL DEPTH THE

EXCAVATION. BACKFILL SHALL BE PLACED IN 8" MAXIMUM LIFTS AND

COMPACTED TO 95% OF MAXIMUM DRY DENSITY AS DETERMINED BY

── PIPE DIA. + 2'-0" MAX ——


FINAL GRADE


3" DETECTION TAPE


PVC SDR35 BELL & SOCKET TYTON

PUSH-ON JOINT SEWER PIPE

2: \980.1504 — RDM\Details.dwg Date Printed: May 04, 2023, 2:26pm

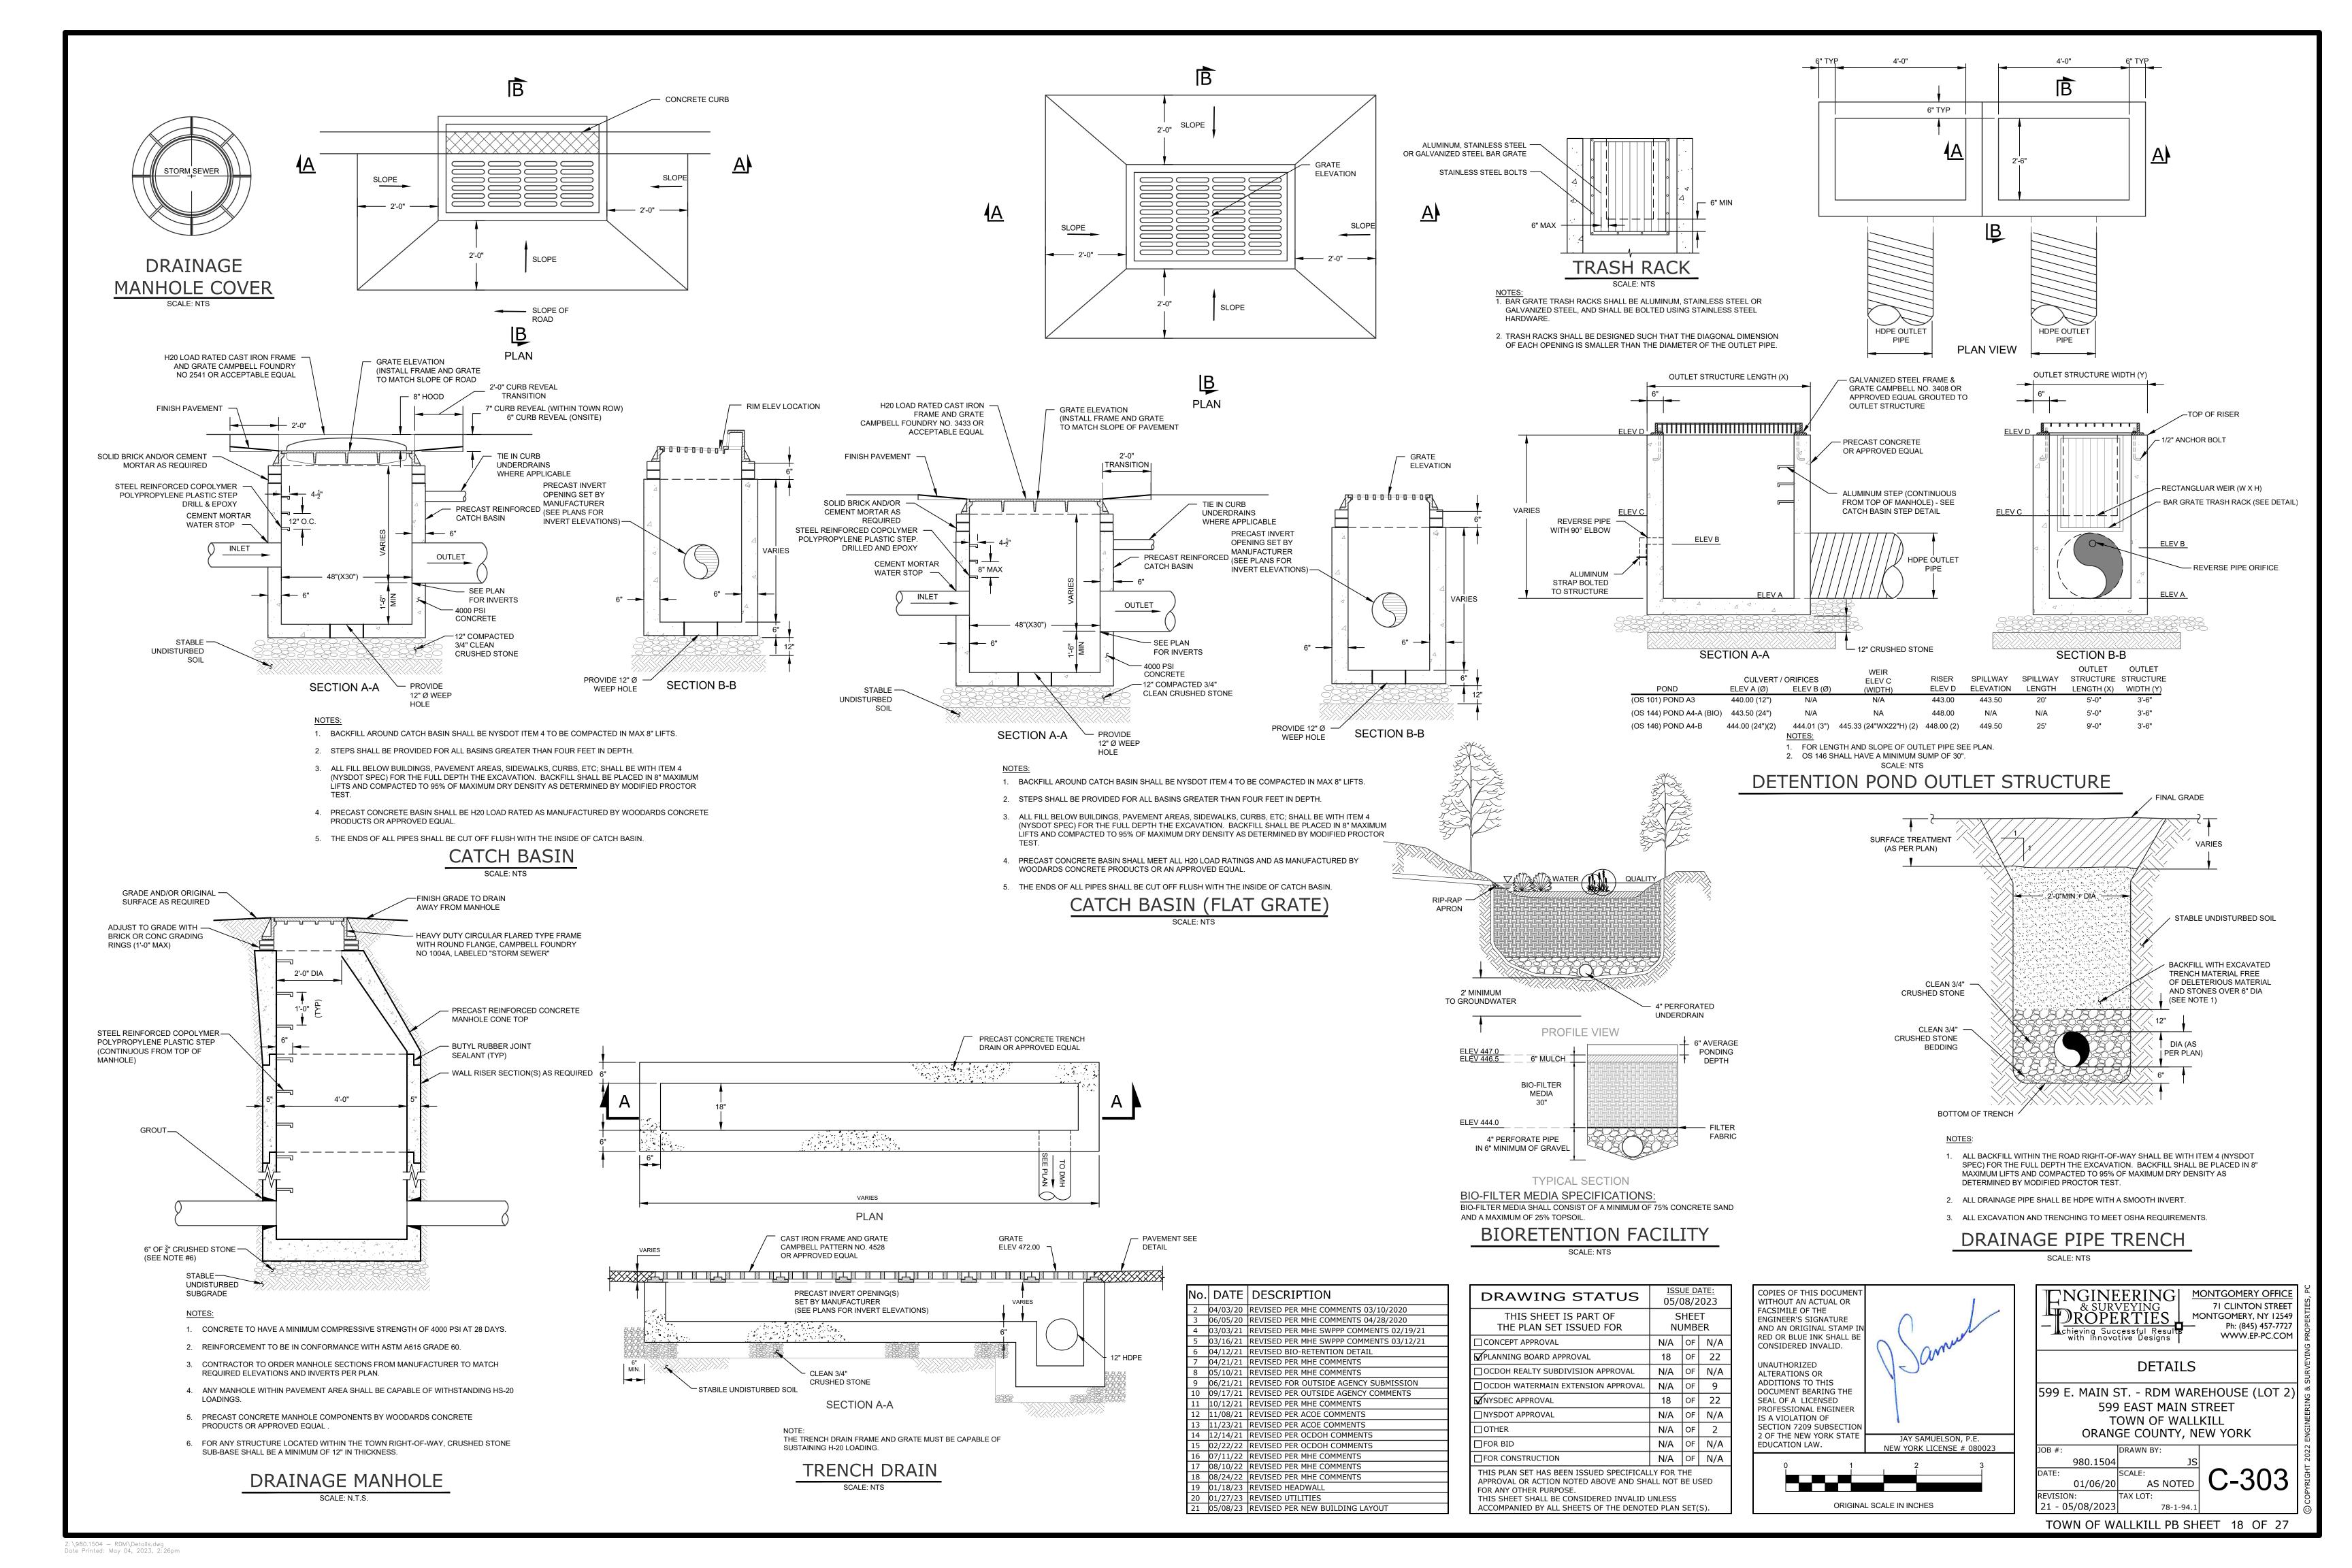

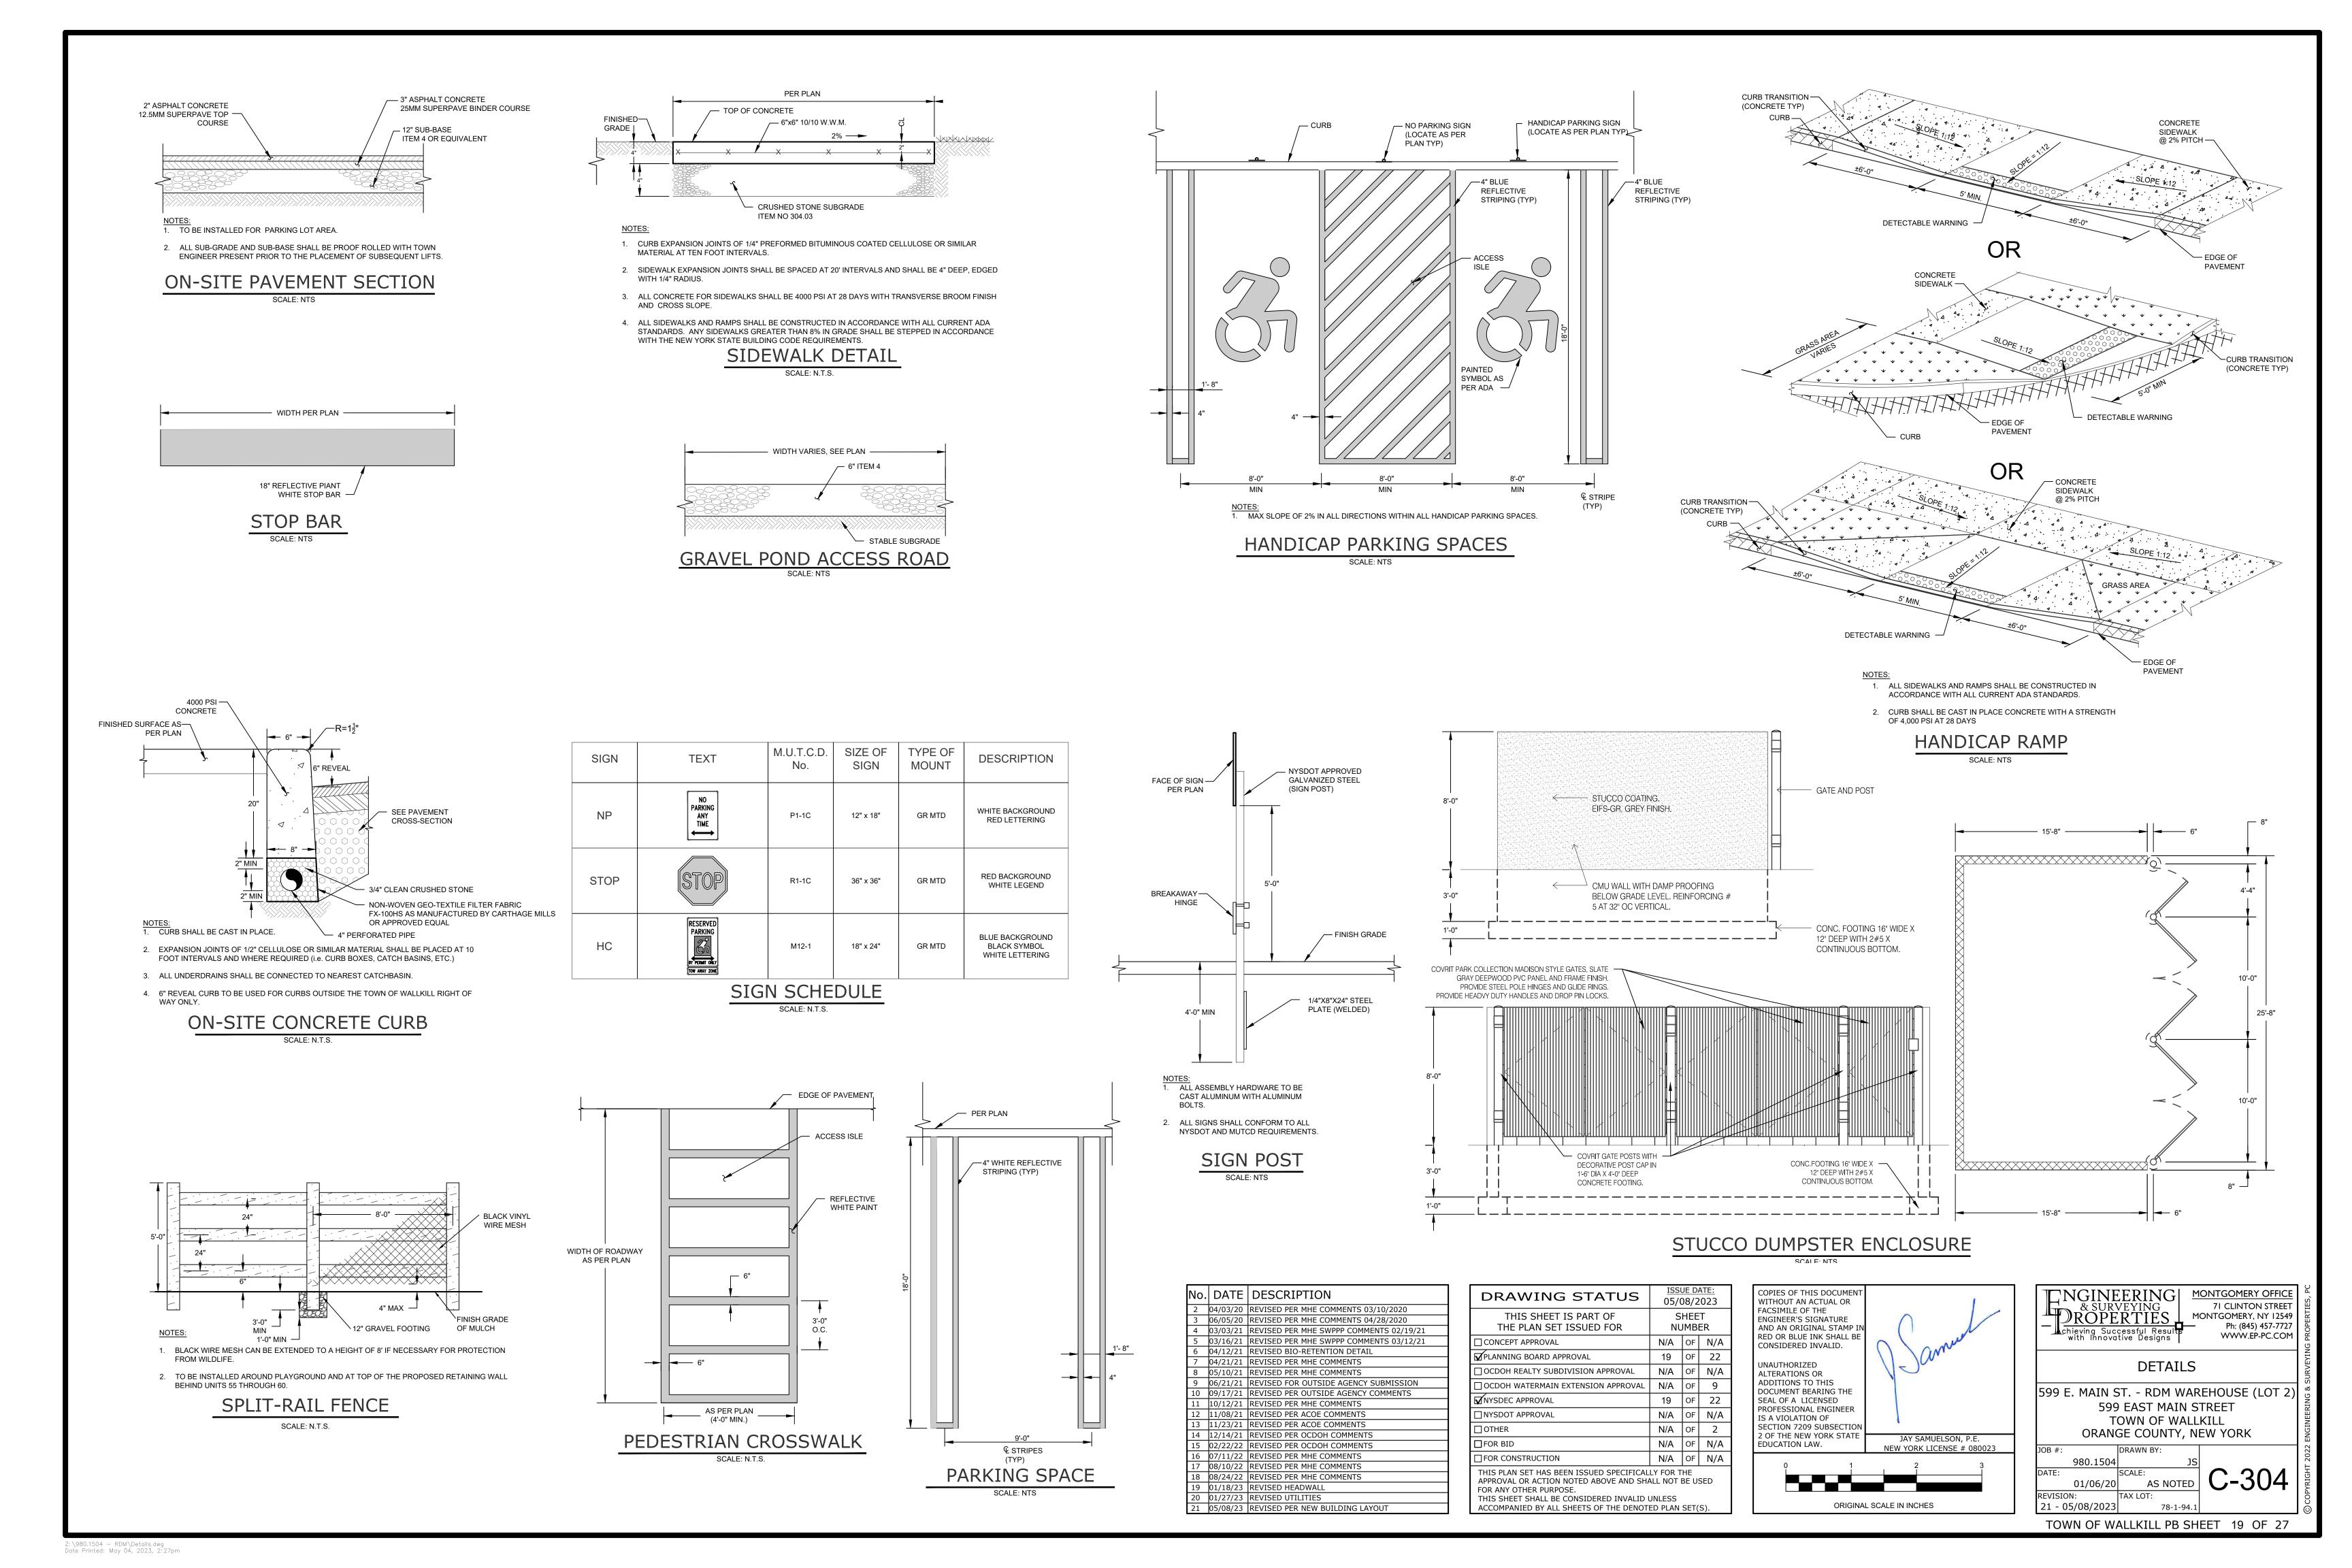


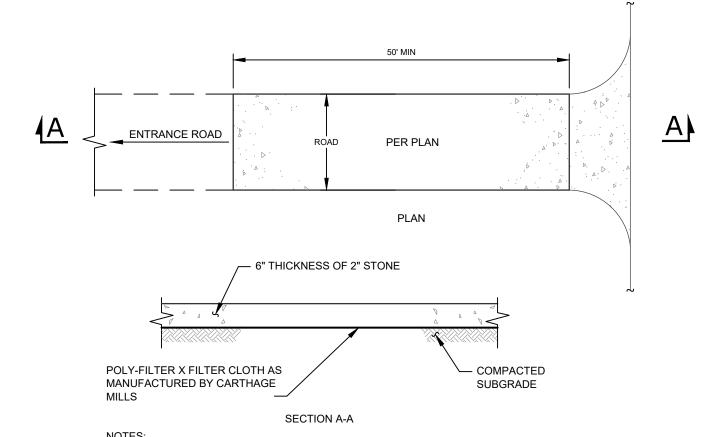

- 1. STONE SIZE USE 2" STONE, OR RECLAIMED OR RECYCLED CONCRETE EQUIVALENT.
- 2. WIDTH 24 FOOT MINIMUM, BUT NOT LESS THAN THE FULL WIDTH AT POINTS WHERE INGRESS OR EGRESS OCCURS.
- 3. SURFACE WATER ALL SURFACE WATER FLOWING OR DIVERTED TOWARD CONSTRUCTION ENTRANCES SHALL BE PIPED ACROSS THE ENTRANCE. IF PIPING IS IMPRACTICAL A MOUNTABLE BERM WITH 5:1 SLOPES WILL BE PERMITTED.
- 4. MAINTENANCE THE ENTRANCE SHALL BE MAINTAINED IN A CONDITION WHICH SHALL PREVENT TRACKING OR FLOWING OF SEDIMENT ONTO PUBLIC RIGHTS-OF-WAY THIS MAY REQUIRED PERIODIC TOP DRESSING WITH ADDITIONAL STONE AS CONDITIONS DEMAND AND REPAIR AND/OR CLEANOUT OF ANY MEASURES USED TO TRAP SEDIMENT. ALL SEDIMENT SPILLED, DROPPED, WASHED, OR TRACKED ONTO PUBLIC RIGHTS-OF-WAY MUST BE REMOVED IMMEDIATELY.
- 5. WASHING WHEELS SHALL BE CLEANED TO REMOVE SEDIMENT PRIOR TO ENTRANCE ONTO PUBLIC RIGHTS-OF-WAY. WHEN WASHING IS REQUIRED, IT SHALL BE DONE ON AN AREA STABILIZED WITH STONE AND WHICH DRAINS INTO AN APPROVED SEDIMENT TRAPPING DEVICE.
- 6. PERIODIC INSPECTIONS AND NEEDED MAINTENANCE SHALL BE PROVIDED AFTER EACH RAIN

SCALE: NTS

STABILIZED CONSTRUCTION ENTRANCE

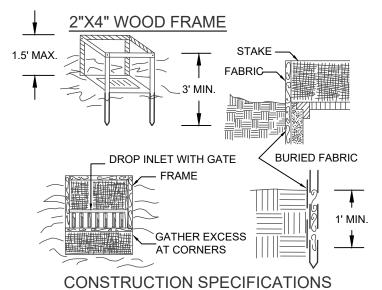

1. FILTER FABRIC SHALL HAVE AN EOS OF 40-85. BURLAP MAY BE USED FOR SHORT TERM APPLICATIONS

2. CUT FABRIC FROM A CONTINUOUS ROLL TO ELIMINATE JOINTS. IF JOINTS ARE NEEDED THEY WILL BE OVERLAPPED TO THE NEXT STAKE. 3. STAKE MATERIALS WILL BE STANDARD 2" x 4" WOOD OR EQUIVALENT.

METAL WITH A MINIMUM LENGTH OF 3 FEET. 4. SPACE STAKES EVENLY AROUND INLET 3 FEET APART AND DRIVE A

MINIMUM 18 INCHES DEEP, SPANS GREATER THAN 3 FEET MAY BE BRIDGED


WITH THE USE OF WIRE MESH BEHIND THE FILTER FABRIC FOR SUPPORT. 5. FABRIC SHALL BE EMBEDDED 1 FOOT MINIMUM BELOW GROUND AND

BACKFILLED. IT SHALL BE SECURELY FASTENED TO THE STAKES AND FRAME

6. A 2" x 4" WOOD FRAME SHALL BE COMPLETED AROUND THE CREST OF THE

FABRIC FOR OVER FLOW STABILITY MAXIMUN DRAINAGE AREA 1 ACRE

FILTER FABRIC DROP INLET PROTECTION

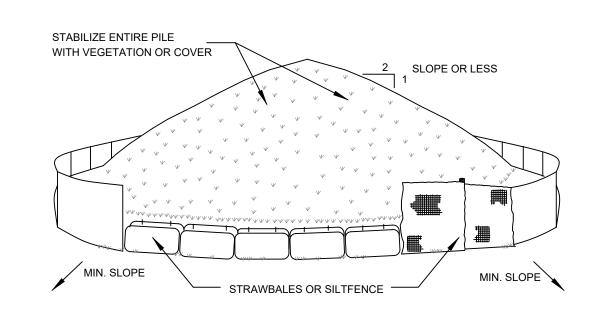

NOTES:


1. AREA CHOSEN FOR STOCKPILING OPERATIONS SHALL BE DRY AND STABLE

3. UPON COMPLETION OF SOIL STOCKPILING, EACH PILE SHALL BE SURROUNDED A WITH

2. MAXIMUM SLOPE OF STOCKPILE SHALL BE 1:2.

EITHER SILT FENCING OR STRAWBALES, THEN STABILIZED WITH VEGETATION OR COVERED. 4. SEE SPECIFICATIONS (THIS MANUAL) FOR INSTALLATION OF SILTFENCE.

SOIL STOCKPILING

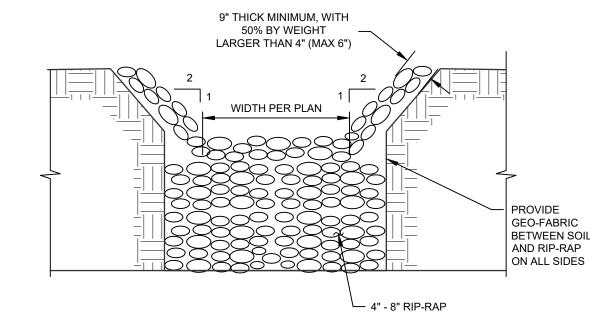

PRIOR TO INSTALLATION OF ANY RECP'S.

FENCE POST @ 8'-0" OC —

SILT FENCE FABRIC

EXCAVATED /

TRENCH __/

1. SILT FENCE TO BE MAINTAINED IN

SOIL STABILIZATION PERIOD.

PLACE DURING CONSTRUCTION AND

(3'-0" WIDE) MIRAFI

TOP OF SLOPE

1. ROLLED EROSION CONTROL PRODUCT (RECP'S) SHALL BE USED ON ALL CONSTRUCTED SLOPES GREATER THAN 3 HORIZONTAL

2. PREPARATION OF THE SOIL INCLUDING ANY NECESSARY APPLICATION OF LIME, FERTILIZER, AND SEED SHALL BE COMPLETED

ANCHORING THE RECP'S IN A 6" DEEP BY 6" WIDE TRENCH WITH APPROXIMATELY 12" OF RECP'S EXTENDED BEYOND THE

UP-SLOPE PORTION OF THE TRENCH. ANCHOR THE RECP'S WITH A ROW OF STAPLES/STAKES APPROXIAMTELY 12" APART IN

AND FOLD REMAINING 12" PORTION OF RECP'S BACK OVER SEED AND COMPACTED SOIL. SECURE RECP'S OVER COMPACTED

SOIL SURFACE BY PLACING STAPLES/STAKES IN APPROPRIATE LOCATIONS AS SHOWN IN THE PRODUCT'S STAPLE PATTERN

THE BOTTON OF THE TRENCH. BACKELL AND COMPACT THE TRENCH AFTER STAPLING. APPLY SEED TO COMPACTED SOIL

INSTALL RECP - NORTH AMERICAN GREEN BIONET S150BN OR APPROVED EQUAL. BEGIN AT THE TOP OF THE SLOPE BY

4. ROLL THE RECP'S DOWN THE SLOPE OR HORZONTALLY ACROSS THE SLOPE. ALL RECP'S MUST BE SECURLY FASTENED TO

5. THE EDGES OF PARALLEL RECP'S MUST BE STAPLED WITH APPROXIMATELY 2" TO 5" OVERLAP DEPENDING ON RECP'S TYPE.

3" OVERLAP. STAPLE THROUGH OVERLAPPED AREA, APPROXIMATELY 12" APART ACROSS THE ENTIRE RECP'S WIDTH.


6. CONSECUTIVE RECP'S SPLICED DOWN THE SLOPE MUST BE PLACED END OVER END (SHINGLE STYLE) WITH AN APPROXIAMATE

SLOPE STABILIZATION

(ROLLED EROSION CONTROL PRODUCT)

SOIL WITH A ROW OF STAPLES/STAKES SPACE APPROXIMATELY 12" APART ACROSS THE WIDTH OF THE RECP'S.


OVERFLOW WEIR(S

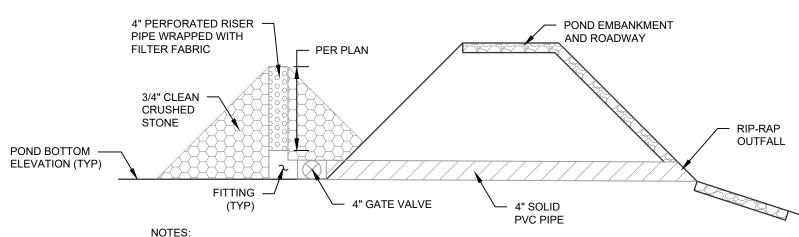


. 4" SOLID PVC PIPE AND 4" GATE VALVE SHALL BE INSTALLED FIRST TO ALLOW CONTRACTOR TO DRAIN THE POND IN ORDER TO COMPLETE THE CONSTRUCTION OF THE STORMWATER MANAGEMENT POND. IN THE EVENT THE STORMWATER DETAINED BY THE POND IS SEDIMENT LADEN, THE CONTRACTOR SHALL CLOSE THE VALVE AND PUMP THE STORMWATER TO A SUITABLE BMP

2. ONCE THE CONSTRUCTION OF THE ENTIRE PROJECT IS COMPLETE AND EXPOSED AREAS ARE STABILIZED, THE RISER PIPE AND SOLID PIPE SHALL BE REMOVED OR PERMANENTLY ABANDONED FOR POND A4A.

PERFORATED RISER PIPE

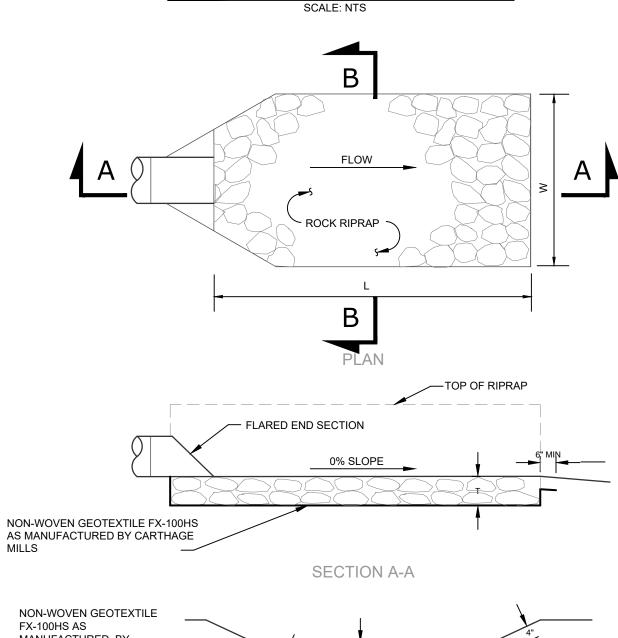

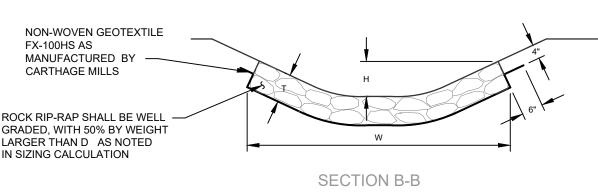

FES OUTLET PROTECTION

OUTLET PROTECTION SIZING CALCULATIONS

END SECTION	DIA. (in)	Q _{MAX} (cfs)	V _{MAX} (ft/s)	D ₅₀ (in)	D _{MAX} (in)	L (ft)	W (ft)	T (in)	H (in)
FES 102	15	2.2	1.8	4	6	8	9.25	12	15
FES 111	15	8.5	6.9	4	6	11	12.25	12	15
FES 112	24	32.6	10.4	9	15	20	22	24	24
FES 134	24	34.6	11	9	15	20	22	24	24
FES 145	24	26.7	8.4	9	15	16	18	24	24
FES 153	18	14.0	7.9	6	9	12	13.5	18	18
FES 200	12	4.7	5.9	4	6	11	12.25	12	15

EROSION AND SEDIMENTATION CONTROL NOTES SITE DISTURBANCE SHALL BE LIMITED TO THE MINIMUM NECESSARY GRADING AND VEGETATION REMOVAL 1 REQUIRED FOR CONSTRUCTION AND IN ACCORDANCE WITH THE ACREAGE LISTED ON THE PLANS PER PHASE (IF APPLICABLE

SITE DISTURBANCE GREATER THAN ONE (1) ACRE WILL REQUIRED COVERAGE UNDER THE NYSDEC SPDES GENERAL PERMIT GP-0-20-001 FOR STORMWATER DISCHARGE ASSOCIATED WITH CONSTRUCTION

2.1. GP-0-20-001 REQUIRES DAILY INSPECTIONS BY THE CONTRACTOR (TRAINING & CERTIFICATION REQUIRED) AS WELL AS WEEKLY INSPECTIONS BY A QUALIFIED PROFESSIONAL

NOTES AND PROCEDURES IN THIS PLAN SET) SHALL BE IMPLEMENTED WITHIN 7 DAYS FROM THE

OR MORE OF THE PROPOSED CONSTRUCTION PHASES. THE FOLLOWING ADDITIONAL ITEMS ARE A REQUIREMENT OF THE 5-ACRE DISTURBANCE LIMIT WAIVER 2.2.1. THE INSPECTIONS BY THE QUALIFIED PROFESSIONAL SHALL BE 2 TIMES EVERY 7 DAYS.

CEASING OF SOIL DISTURBANCE FOR THAT AREA. 3 ORANGE CONSTRUCTION FENCE LOCATIONS SHALL BE STAKED BY A SURVEYOR AND INSTALLATION SHALL BE CONFIRMED BY THE ENGINEER PRIOR TO ANY LAND DISTURBANCE WITHIN 125 FEET OF AN EXISTING WETLAND AND IN AREAS WHERE TREES AND STONE WALLS ARE TO BE PRESERVED. ALL ORANGE CONSTRUCTION FENCING SHALL BE MAINTAINED THROUGHOUT CONSTRUCTION TO PROTECT SENSITIVE AREAS. THE ORANGE CONSTRUCTION FENCING WILL BE REMOVED UPON FINAL STABILIZATION OF ALL AREAS WITHIN 125 FEET OF FENCING.

4. TEMPORARY EROSION CONTROL MEASURES, INCLUDING SILT FENCES AND/OR STRAW BALE DIKES, DRAINAGE STRUCTURES, AND RIP-RAP PROTECTION SHALL BE INSTALLED PRIOR TO GROUND

DISTURBANCE FOR GRADING AND CONSTRUCTION. 5. ALL DISTURBED AREAS SHALL BE SEEDED AND MULCHED AS SOON AS PRACTICAL FOLLOWING DISTURBANCE TO STABILIZE BARE SOIL AND PROMOTE THE PROMPT RE-ESTABLISHMENT OF VEGETATION: 5.1. AN ADEQUATE SEEDBED SHALL BE PREPARED BY SCARIFYING COMPACTED SOIL AND REMOVING

5.2. LIME SHALL BE APPLIED SUFFICIENTLY TO ATTAIN A SOIL ACIDITY PH OF 6.0 TO 7.0. 5.3. FERTILIZER (5-10-10 MIXTURE OR EQUIVALENT) SHALL BE APPLIED PER SOIL TEST RESULTS OR AT A

RATE OF 600 LBS. PER ACRE. 5.4. DISTURBED AREAS WHICH WILL REMAIN TEMPORARILY FALLOW FOR PERIODS GREATER THAN 30 DAYS SHALL BE SEEDED AT THE FOLLOWING RATE TO PRODUCE TEMPORARY GROUND COVER: 30 LBS. RYEGRASS (ANNUAL OR PERENNIAL) PER ACRE. DURING THE WINTER, USE 100 LBS. CERTIFIED

5.5. PERMANENT SEEDING SHALL BE APPLIED ON 4" MIN TOPSOIL AT THE FOLLOWING RATE: 8 LBS EMPIRE BIRDSFOOT TREFOIL OR COMMON WHITE CLOVER PER ACRE PLUS 20 LBS TALL FESCUE PER ACRE PLUS

2 LBS REDTOP OR 5 LBS RYEGRASS (PERENNIAL) PER ACRE 5.6. ALL SEEDING SHALL BE PERFORMED USING THE BROADCAST METHOD OR HYDROSEEDING, UNLESS OTHERWISE APPROVED.

5.7. OPTIMUM SEEDING PERIODS ARE 3/15-6/1 AND 8/1-10/15. 5.8. ALL DISTURBED AREAS SHALL BE STABILIZED SUBSEQUENT TO SEEDING BY APPLYING 2 TONS OF STRAW MULCH PER ACRE. STRAW MULCH SHALL BE ANCHORED BY APPLYING 750 LBS OF WOOD FIBER MULCH PER ACRE WITH A HYDROSEEDER, OR TUCKING THE MULCH WITH SMOOTH DISCS OR OTHER MULCH ANCHORING TOOLS TO A DEPTH OF 3". MULCH ANCHORING TOOLS SHALL BE PULLED

ALL EROSION AND SEDIMENTATION CONTROL MEASURES AND DRAINAGE STRUCTURES SHALL BE INSPECTED FOLLOWING EVERY RAIN EVENT, AND MAINTENANCE AND REPAIRS SHALL BE PERFORMED PROMPTLY TO MAINTAIN PROPER FUNCTION. TRAPPED SEDIMENT SHALL BE REMOVED AND DEPOSITED IN A PROTECTED AREA IN A PROPER MANNER WHICH WILL NOT RESULT IN EROSION

TEMPORARY CONTROL MEASURES SHALL REMAIN IN PLACE UNTIL DISTURBED AREAS ARE PERMANENTLY STABILIZED AND GROUND COVER IS COMPLETELY REESTABLISHED. FOLLOWING STABILIZATION, TEMPORARY MEASURES SHALL BE REMOVED TO AVOID INTERFERENCE WITH DRAINAGE.

ALL STORM INLETS TO BE PROTECTED FROM SEDIMENTATION DURING CONSTRUCTION. SYNTHETIC OR ORGANIC SOIL STABILIZERS MAY BE USED UNDER SUITABLE CONDITIONS AND IN SUFFICIENT QUANTITIES. MULCH NETTING SUCH AS PAPER, JUTE, EXCELSIOR, COTTON OR PLASTIC MAY BE USED. STAPLE IN PLACE. OVER HAY OR STRAW MULCH. USE A DEGRADABLE NETTING IN AREAS TO BE

10. STABILIZATION OF STEEP SLOPES SHALL BE ACHIEVED BY APPLYING LIME AND FERTILIZER AS SPECIFIED ABOVE AND SEEDING WITH THE FOLLOWING MIXTURE:

> PERENNIAL RYE GRASS **CROWN VETCH**

SPREADING FESCUE

SURFACE DEBRIS AND OBSTACLES.

"AROOSTOOK" WINTER RYE (CEREAL RYE) PER ACRE.

ACROSS SLOPES ALONG TOPOGRAPHIC CONTOURS.

11. FOR CONSTRUCTION THAT OCCURS DURING WINTER MONTHS (I.E. NOVEMBER 15 - APRIL 1) ADDITIONAL MEASURES SHALL BE TAKEN IN ACCORDANCE WITH THE STANDARD & SPECIFICATIONS FOR WINTER STABILIZATION SECTION OF THE NEW YORK STATE STANDARDS AND SPECIFICATIONS FOR FROSION CONTROL, LATEST VERSION AS PUBLISHED BY THE NYSDEC SUCH AS BUT NOT LIMITED TO THE

• ENSURING COMPLIANCE WITH SNOW STORAGE STOCKPILE AREAS • SNOW STOCKPILES AT CONSTRUCTION ENTRANCE SHALL BE OUTSIDE THE STABILIZED CONSTRUCTION ENTRANCE TO ENSURE THE FUNCTIONALITY OF THE EROSION CONTROL MEASURE.

 MAINTAIN BUFFERS TO ALL PERIMETER SILT FENCES. • INSTALL ADDITIONAL SILT FENCE AS NECESSARY FOR ANY DISTURBED AREAS UPGRADIENT OF A WATER

• PROVIDE MAINTENANCE OF ALL DRAINAGE STRUCTURE TO KEEP CLEAR OF SNOW, ICE, DEBRIS, ETC. • IN AREAS WHERE SOIL DISTURBANCE ACTIVITY HAS TEMPORARILY OR PERMANENTLY CEASED. THE APPLICATION OF SOIL STABILIZATION MEASURES SHOULD BE INITIATED BY THE END OF THE NEXT BUSINESS DAY AND COMPLETED WITHIN THREE (3) DAYS. ROLLED EROSION CONTROL BLANKETS MUST BE USED ON ALL SLOPES 3 HORIZONTAL TO 1 VERTICAL OR STEEPER.

THE STANDARD RATE OF 2 TONS PER ACRE, MAKING THE APPLICATION RATE 4 TONS PER ACRE. OTHER MANUFACTURED MULCHES SHOULD BE APPLIED AT DOUBLE THE MANUFACTURER'S RECOMMENDED

• IF STRAW MULCH ALONE IS USED FOR TEMPORARY STABILIZATION. IT SHALL BE APPLIED AT DOUBLE

• TO ENSURE ADEQUATE STABILIZATION OF DISTURBED SOIL IN ADVANCE OF A MELT EVENT, AREAS OF DISTURBED SOIL SHOULD BE STABILIZED AT THE END OF EACH WORK DAY UNLESS:

•• WORK WILL RESUME WITHIN 24 HOURS IN THE SAME AREA AND NO PRECIPITATION IS FORECAST OR; •• THE WORK IS IN DISTURBED AREAS THAT COLLECT AND RETAIN RUNOFF, SUCH AS OPEN UTILITY TRENCHES, FOUNDATIONS, EXCAVATIONS, OR WATER MANAGEMENT AREAS.

• USE STONE PATHS TO STABILIZE ACCESS PERIMETERS OF BUILDINGS UNDER CONSTRUCTION AND AREAS WHERE CONSTRUCTION VEHICLE TRAFFIC IS ANTICIPATED. STONE PATHS SHOULD BE A MINIMUM 10.E. VEGETATE IN ACCORDANCE WITH LANDSCAPE PLAN. 10 FEET IN WIDTH BUT WIDER AS NECESSARY TO ACCOMMODATE EQUIPMENT.

SEQUENCE OF **CONSTRUCTION ACTIVTY**

THAN 21 DAYS FROM LAST DISTURBANCE.

A MEETING WITH TOWN REPRESENTATIVES. INCLUDING TOWN ENGINEER, AS WELL AS CONTRACTORS, PROJECT MANAGER AND FOREMAN, IS TO TAKE PLACE A MINIMUM OF ONE WEEK PRIOR TO CONSTRUCTION.

CONSTRUCTION STAGING: STAKE OUT LIMIT OF DISTURBANCE. INSTALL SILT FENCE DOWN HILL OF PROPOSED CONSTRUCTION. INSTALL STABILIZED CONSTRUCTION ENTRANCE AND STABLIZE CONSTRUCTION ROAD(S). INSTALL TEMPORARY SEDIMENT TRAP. INSTALL PERMANENT/TEMPORARY GRASSED.

2.2. A WAIVER HAS BEEN APPLIED FOR TO THE MS4 FOR DISTURBANCE GREATER THAN 5 ACRES FOR ONE 3. CLEARING AND GRUBBING: REMOVE VEGETATION FROM AREA OF CONSTRUCTION. STRIP TOPSOIL AND STOCKPILE IN AREAS SHOWN ON THE PLAN. INSTALL SEDIMENT BARRIERS AROUND AND ESTABLISH TEMPORARY

VEGETATION ON TOPSOIL STOCKPILES. 2.2.2. IN AREAS OF TEMPORARY OR PERMANENT DISTURBANCE, STABILIZATION (IN ACCORDANCE WITH 4. ROUGH GRADING: CUT AND FILL SITE TO APPROXIMATE ELEVATIONS SHOWN ON THE PLAN. IMPLEMENT DUST CONTROL MEASURES AS NECESSARY. ESTABLISH PERMANENT STABLIZATION IN AREAS THAT ARE COMPLETE. ESTABLISH TEMPORARY STABLIZATION ON AREAS THAT WILL BE GRADED AGAIN MORE

> ROAD/BUILDING CONSTRUCTION AND UTILITY INSTALLATION: FINAL GRADING AND CONSTRUCTION OF ROADWAYS. BUILDING EXCAVATION AND CONSTRUCTION. INSTALL UTILITIES. INSTALL DRAINAGE INLET AND OUTLIFT PROTECTION AS EACH INLET/OUTLET IS CONSTRUCTED. ENSURE ALL EROSION

CONTROL MEASURES ARE IN WORKING ORDER. FINAL GRADING AND LANDSCAPING: REMOVE TEMPORARY SEDIMENT TRAPS AND INSTALL PERMANENT WATER QUALITY/QUANTITY FACILITIES. COMPLETE FINE GRADING OF SITE. SPREAD TOPSOIL AND PREPARE FOR PERMANENT SEEDING AND PLANTING. ESTABLISH PERMANENT VEGETATION IN ALL REMAINING UNSTABILIZED AREAS. INSTALL ALL SITE LANDSCAPING AND

POST CONSTRUCTION: UPON STABILIZATION OF THE SITE AND ESTABLISHMENT OF ALL VEGETATION COVER REMOVE ALL REMAINING TEMPORARY EROSION. CONTROL MEASURES SUCH AS SILT FENCE. REMOVE ALL SILT AND DEBRIS FROM THE SITE INCLUDING ROADWAYS, CATCH BASINS AND STORM DRAINS

EARTHWORK CONSTRUCTION

ALL WORK TO BE PERFORMED TO THE SPECIFICATIONS OF THE TOWN OF WALLKILL

ALL TOPSOIL, ROOTS, STUMPS AND OTHER DELETERIOUS MATERIAL SHALL BE REMOVED FROM ALL CONSTRUCTION AREAS.

ALL FILL FOR POND CONSTRUCTION, BELOW BUILDINGS AND PAVEMENT TO BE COMPACTED TO 95% OF MAXIMUM DRY DENSITY AS DETERMINED BY MODIFIED PROCTOR COMPACTION TEST ASTM D1557.

CELLAR, ROOF AND FOOTING DRAINS SHALL CONNECT TO THE STORM DRAINAGE SYSTEM OR OTHER FREE-FLOWING OUTLET AT A MINIMUM SLOPE OF 0.5%. FOOTING DRAIN SHALL BE INSTALLED BENEATH BOTTOM OF FOOTING.

COMPLETION OF GRADING AND BASIN, BERMS AFTER OCTOBER 15 SHALL REQUIRE MULCHING AND ANCHORING IN ACCORDANCE WITH NOTES ENTITLED "SEDIMENTATION EROSION CONTROL".

ALL SLOPES IN EXCESS OF 3H:1V SHALL BE CONSTRUCTED WITH LOCALLY AVAILABLE GLACIAL TILL. THE EMBANKMENT FILL SHALL BE PLACED IN SIX-INCHTHICK LIFTS. EACH LIFT SHALL BE PLACED AND COMPACTED TO 95% OF MAXIMUM DRY DENSITY AS DETERMINED BY MODIFIED PROCTOR COMPACTION TEST ASTM D1557.

7. CONSTRUCT POND EMBANKMENT WITH LOCALLY AVAILABLE GLACIAL TILL WITH 3H:1V SIDE SLOPES OR AS NOTED ON PLAN. THE EMBANKMENT FILL SHALL BE PLACED IN A SIX-INCH THICK CONTINUOUS LAYER OVER THE ENTIRE LENGTH EACH LIFT SHALL BE PLACED AT OPTIMUM MOISTURE CONTENT AND COMPACTED TO 95% OF MAXIMUM DRY DENSITY AS DETERMINED BY MODIFIED PROCTOR COMPACTION TEST ASTM D1557.

8. STABILIZATION OF POND BERMS, AND ALL SLOPES IN EXCESS OF 3H:1V IN ACCORDANCE WITH "EROSION AND SEDIMENTATION CONTROL

ALL POND OUTLETS SHALL HAVE SEEPAGE CONTROL COLLARS PLACED AT 1/3 AND 2/3 THE WIDTH OF THE EMBANKMENT.


10. SOIL RESTORATION SHALL BE APPLIED TO ALL DISTURBED AREAS THAT WILL REMAIN AS PERVIOUS SURFACES. SOIL RESTORATION SHALL CONSIST OF THE FOLLOWING:


10.A. APPLY 3 INCHES OF COMPOST OVER SUBSOIL

TILL COMPOST INTO SUBSOIL TO A DEPTH OF AT LEAST 12 INCHES USING A CAT-MOUNTED RIPPER, TRACTOR MOUNTED DISC, OR TILLER, MIXING, AND CIRCULATING AIR AND COMPOST INTO

ROCK-PICK UNTIL UPLIFTED STONE/ROCK MATERIALS OF FOUR INCHES AND LARGER SIZE ARE CLEANED OFF THE SITE.

10.D. APPLY TOPSOIL TO A DEPTH OF 6 INCHES.

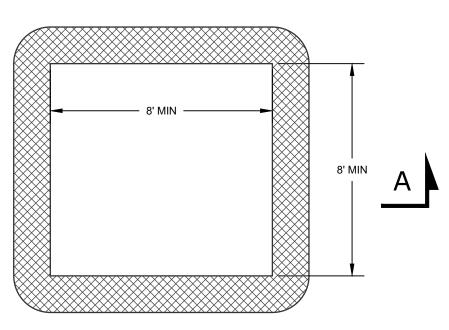

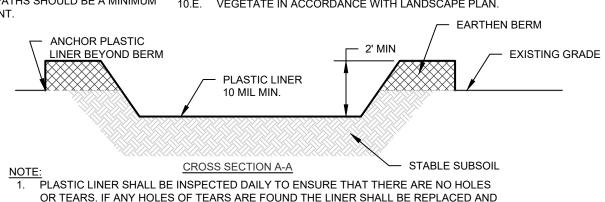

CLEANED IMMEDIATELY. THE PLASTIC LINER SHALL BE REPLACED WITH EACH CLEANING OF THE WASHOUT FACILITY. WASHOUT FACILITY SHALL BE LOCATED A MINIMUM OF 100 FEET FROM DRAINAGE

SWALES, STORM DRAIN INLETS, WETLANDS, STREAMS OR OTHER SURFACE WATERS.

3. ACCUMULATED HARDENED MATERIAL SHALL BE REMOVED WHEN 75% OF THE STORAGE CAPACITY OF THE STRUCTURE IS FILLED. ANY EXCESS WASH WATER SHALL BE PUMPED INTO A CONTAINMENT VESSEL AND PROPERLY DISPOSED OF.


4. DISPOSE OF THE HARDENED MATERIAL OFF-SITE IN A CONSTRUCTION/DEMOLITION


CONCRETE WASHOUT

No.	DATE	DESCRIPTION DRAWING STATUS				ISSUE DATE 05/08/202		
2	04/03/20	REVISED PER MHE COMMENTS 03/10/2020	TUTO CUEST TO DART OF	 				
3	06/05/20	REVISED PER MHE COMMENTS 04/28/2020	THIS SHEET IS PART OF	1	HEE			
4	03/03/21	REVISED PER MHE SWPPP COMMENTS 02/19/21	THE PLAN SET ISSUED FOR	NL	NUMBER			
5	03/16/21	REVISED PER MHE SWPPP COMMENTS 03/12/21	☐ CONCEPT APPROVAL	N/A	OF	N		
6	04/12/21	REVISED BIO-RETENTION DETAIL				\vdash		
7	04/21/21	REVISED PER MHE COMMENTS	☑ PLANNING BOARD APPROVAL	20	OF			
8	05/10/21	REVISED PER MHE COMMENTS	☐ OCDOH REALTY SUBDIVISION APPROVAL	N/A	OF	N		
9	06/21/21	REVISED FOR OUTSIDE AGENCY SUBMISSION	OCDOH WATERMAIN EXTENSION APPROVAL	N/A	OF			
10	09/17/21	REVISED PER OUTSIDE AGENCY COMMENTS			+ -	<u> </u>		
11	10/12/21	REVISED PER MHE COMMENTS	✓NYSDEC APPROVAL	20	OF			
12	11/08/21	REVISED PER ACOE COMMENTS	☐ NYSDOT APPROVAL	N/A	OF	lΝ		
13	11/23/21	REVISED PER ACOE COMMENTS	□OTHER	NI/A	OF	\vdash		
14	12/14/21	REVISED PER OCDOH COMMENTS	DOTTIER	N/A				
15	02/22/22	REVISED PER OCDOH COMMENTS	☐ FOR BID	N/A	OF	N		
16	07/11/22	REVISED PER MHE COMMENTS	☐ FOR CONSTRUCTION	N/A	OF	N		
17	08/10/22	REVISED PER MHE COMMENTS						
18	08/24/22	REVISED PER MHE COMMENTS	THIS PLAN SET HAS BEEN ISSUED SPECIFICAL APPROVAL OR ACTION NOTED ABOVE AND SHA			SED		
19	01/18/23	REVISED HEADWALL	FOR ANY OTHER PURPOSE.	ALL INOT	DL U.	ンレレ		
20	01/27/23	REVISED UTILITIES	THIS SHEET SHALL BE CONSIDERED INVALID	UNLESS				
21	05/08/23	REVISED PER NEW BUILDING LAYOUT	ACCOMPANIED BY ALL SHEETS OF THE DENOTED PLAN SET(S					

BACKFILL

DRAWING STATUS	ISSUE DATE: 05/08/2023				
THIS SHEET IS PART OF THE PLAN SET ISSUED FOR	SHEET NUMBER				
CONCEPT APPROVAL	N/A	OF	N/A		
☑PLANNING BOARD APPROVAL	20	OF	22		
OCDOH REALTY SUBDIVISION APPROVAL	N/A	OF	N/A		
OCDOH WATERMAIN EXTENSION APPROVAL	N/A	OF	9		
NYSDEC APPROVAL	20	OF	22		
NYSDOT APPROVAL	N/A	OF	N/A		
OTHER	N/A	OF	2		
☐ FOR BID	N/A	OF	N/A		
☐ FOR CONSTRUCTION	N/A	OF	N/A		
THIS PLAN SET HAS BEEN ISSUED SPECIFICALLY FOR THE APPROVAL OR ACTION NOTED ABOVE AND SHALL NOT BE USED					

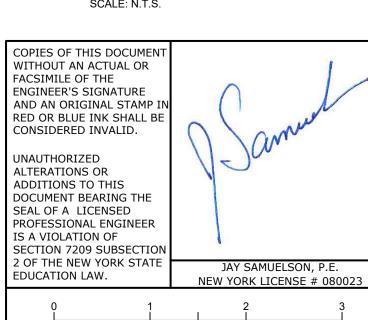


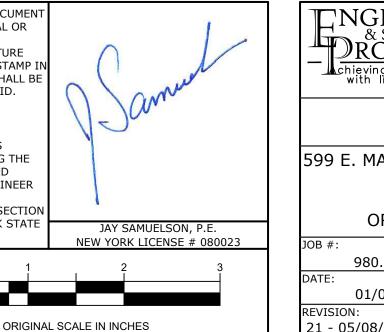



TOWN OF WALLKILL PB SHEET 20 OF 27

Date Printed: May 04, 2023, 2:27pm

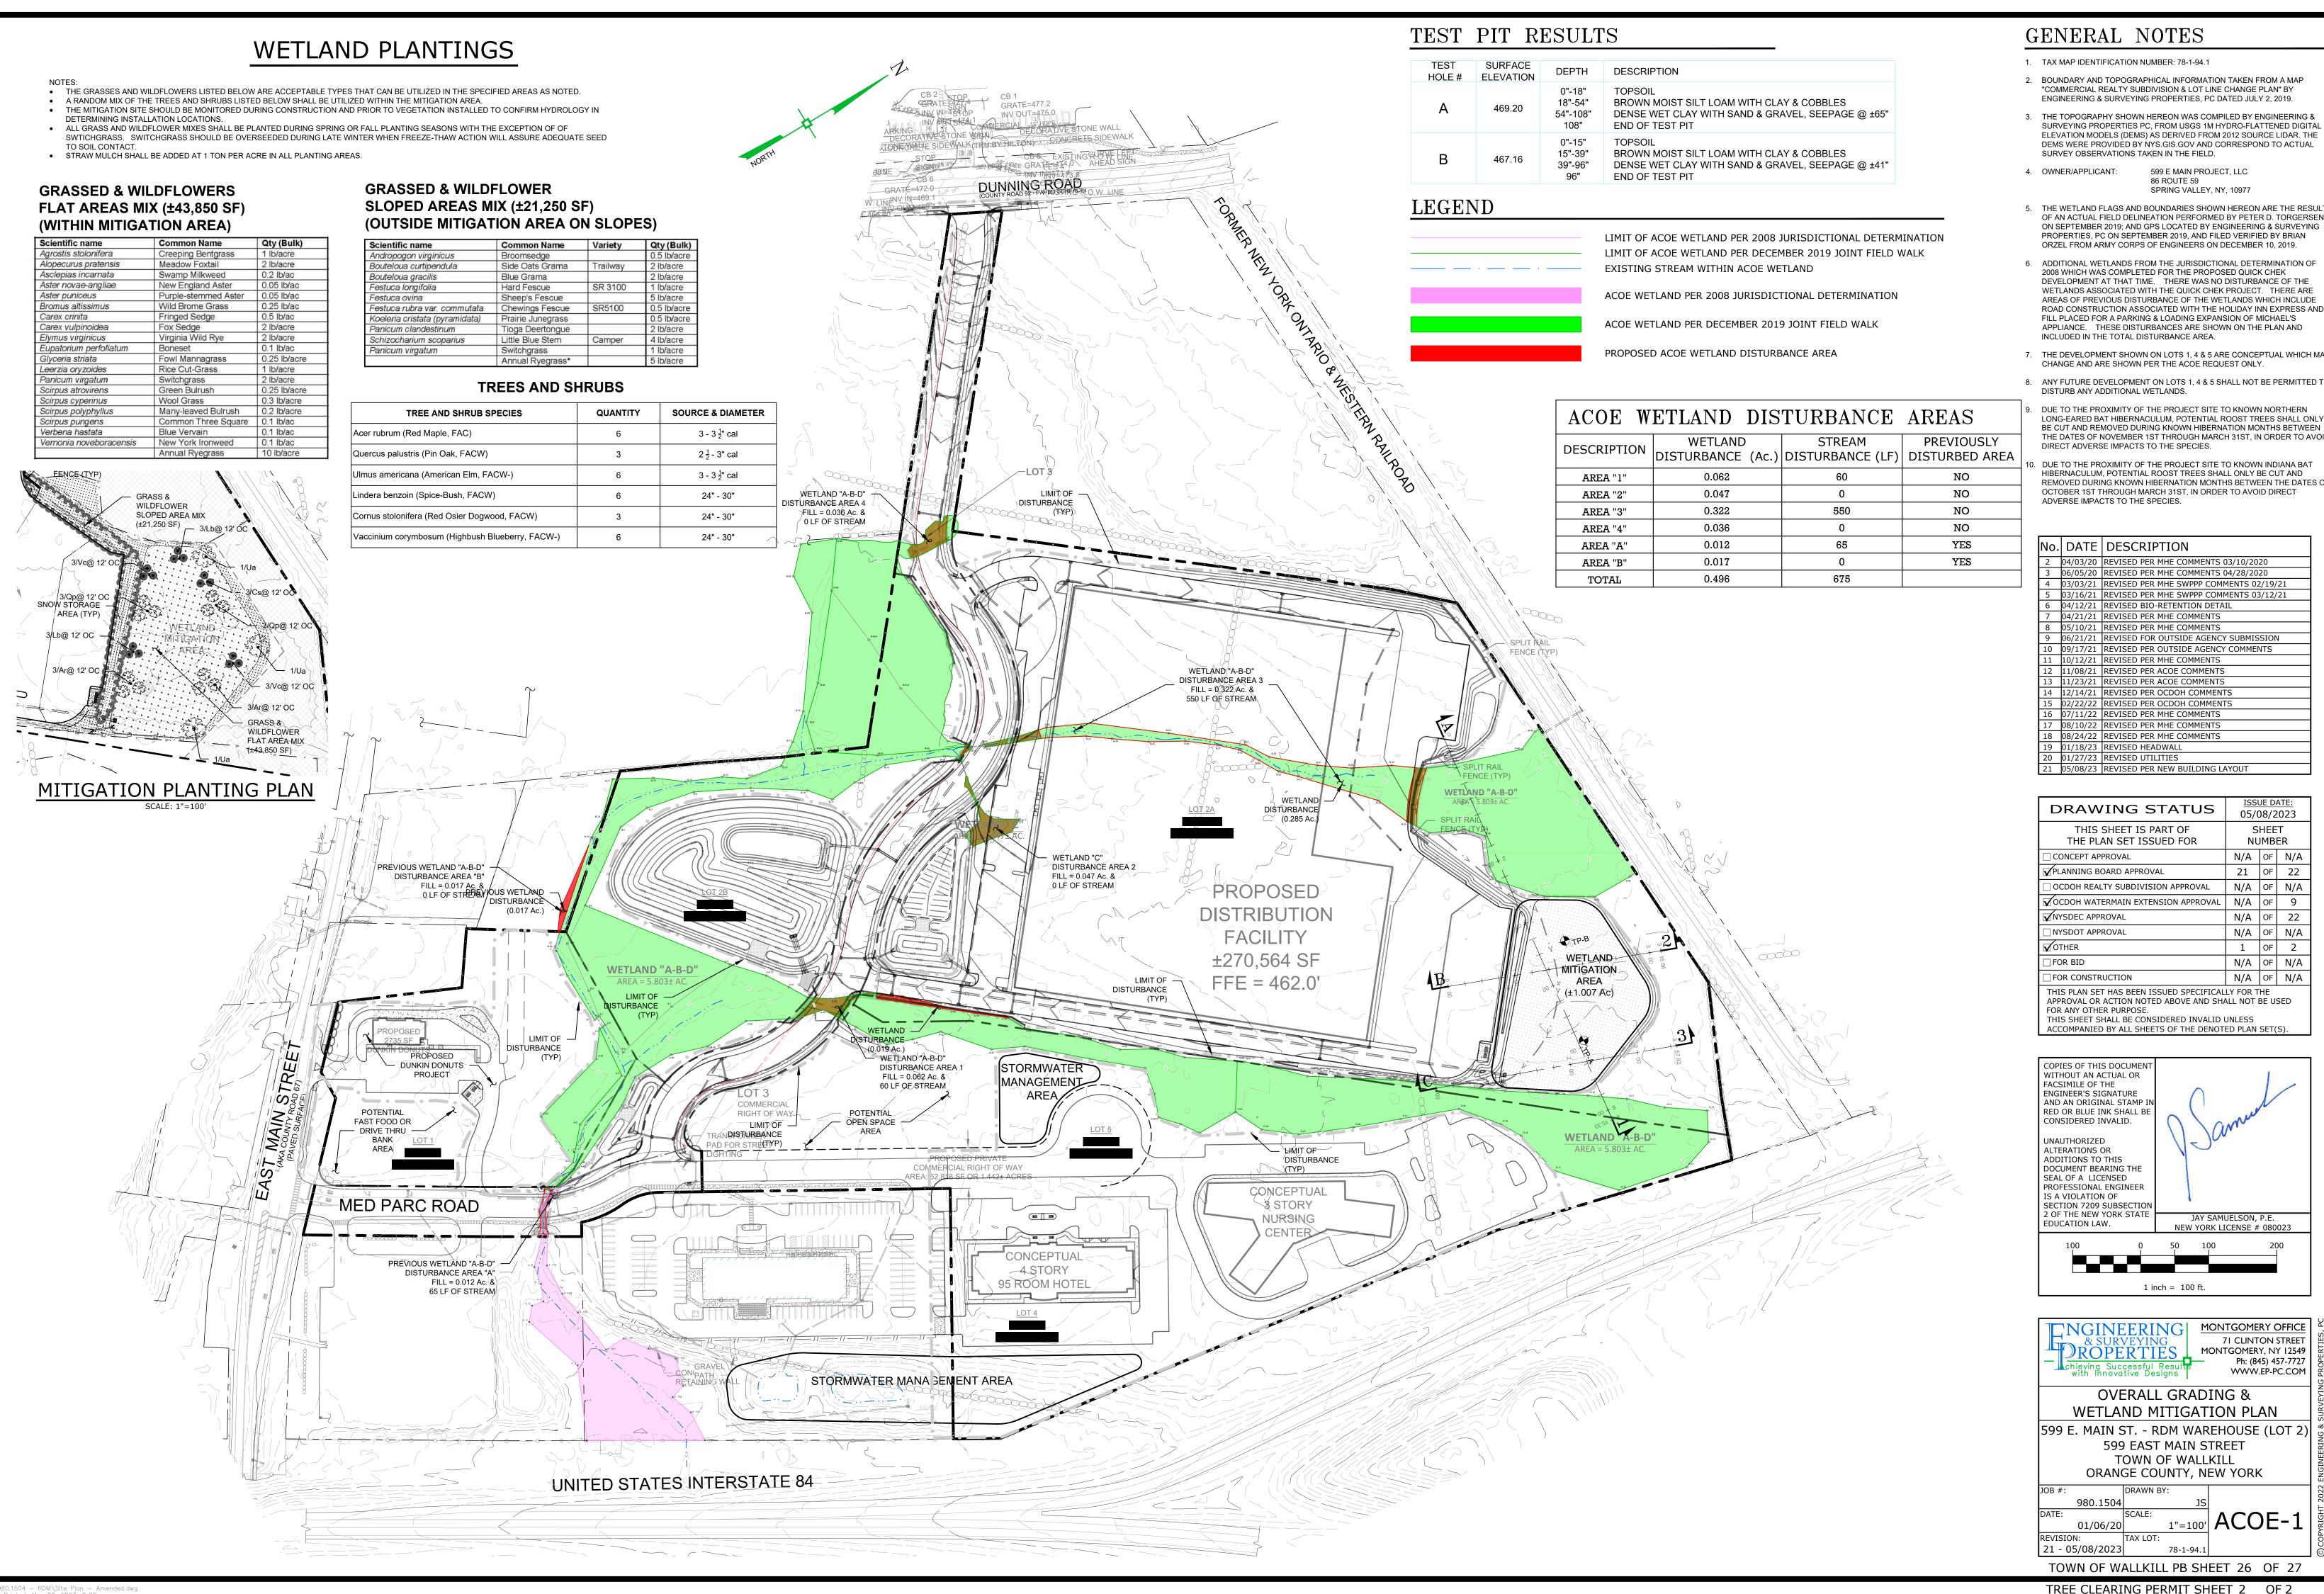

- 2. BOUNDARY AND TOPOGRAPHICAL INFORMATION TAKEN FROM A MAP "COMMERCIAL REALTY SUBDIVISION & LOT LINE CHANGE PLAN" BY ENGINEERING & SURVEYING PROPERTIES, PC DATED JULY 2, 2019.
- 3. THE TOPOGRAPHY SHOWN HEREON WAS COMPILED BY ENGINEERING & SURVEYING PROPERTIES PC, FROM USGS 1M HYDRO-FLATTENED DIGITAL ELEVATION MODELS (DEMS) AS DERIVED FROM 2012 SOURCE LIDAR. THE DEMS WERE PROVIDED BY NYS.GIS.GOV AND CORRESPOND TO ACTUAL
 - 599 E MAIN PROJECT, LLC

SPRING VALLEY, NY, 10977

- OF AN ACTUAL FIELD DELINEATION PERFORMED BY PETER D. TORGERSEN ON SEPTEMBER 2019: AND GPS LOCATED BY ENGINEERING & SURVEYING PROPERTIES, PC ON SEPTEMBER 2019, AND FILED VERIFIED BY BRIAN ORZEL FROM ARMY CORPS OF ENGINEERS ON DECEMBER 10, 2019.
- ADDITIONAL WETLANDS FROM THE JURISDICTIONAL DETERMINATION OF 2008 WHICH WAS COMPLETED FOR THE PROPOSED QUICK CHEK DEVELOPMENT AT THAT TIME. THERE WAS NO DISTURBANCE OF THE WETLANDS ASSOCIATED WITH THE QUICK CHEK PROJECT. THERE ARE AREAS OF PREVIOUS DISTURBANCE OF THE WETLANDS WHICH INCLUDE ROAD CONSTRUCTION ASSOCIATED WITH THE HOLIDAY INN EXPRESS AN FILL PLACED FOR A PARKING & LOADING EXPANSION OF MICHAEL'S APPLIANCE. THESE DISTURBANCES ARE SHOWN ON THE PLAN AND
- 7. THE DEVELOPMENT SHOWN ON LOTS 1, 4 & 5 ARE CONCEPTUAL WHICH MAY
- 8. ANY FUTURE DEVELOPMENT ON LOTS 1, 4 & 5 SHALL NOT BE PERMITTED TO


DUE TO THE PROXIMITY OF THE PROJECT SITE TO KNOWN NORTHERN LONG-EARED BAT HIBERNACULUM. POTENTIAL ROOST TREES SHALL ONLY BE CUT AND REMOVED DURING KNOWN HIBERNATION MONTHS BETWEEN THE DATES OF NOVEMBER 1ST THROUGH MARCH 31ST, IN ORDER TO AVOID


DUE TO THE PROXIMITY OF THE PROJECT SITE TO KNOWN INDIANA BAT HIBERNACULUM, POTENTIAL ROOST TREES SHALL ONLY BE CUT AND REMOVED DURING KNOWN HIBERNATION MONTHS BETWEEN THE DATES OF OCTOBER 1ST THROUGH MARCH 31ST, IN ORDER TO AVOID DIRECT

No.	DATE	DESCRIPTION
2	04/03/20	REVISED PER MHE COMMENTS 03/10/2020
3	06/05/20	REVISED PER MHE COMMENTS 04/28/2020
4	03/03/21	REVISED PER MHE SWPPP COMMENTS 02/19/21
5	03/16/21	REVISED PER MHE SWPPP COMMENTS 03/12/21
6	04/12/21	REVISED BIO-RETENTION DETAIL
7	04/21/21	REVISED PER MHE COMMENTS
8	05/10/21	REVISED PER MHE COMMENTS
9	06/21/21	REVISED FOR OUTSIDE AGENCY SUBMISSION
10	09/17/21	REVISED PER OUTSIDE AGENCY COMMENTS
11	10/12/21	REVISED PER MHE COMMENTS
12	11/08/21	REVISED PER ACOE COMMENTS
13	11/23/21	REVISED PER ACOE COMMENTS
14	12/14/21	REVISED PER OCDOH COMMENTS
15	02/22/22	REVISED PER OCDOH COMMENTS
16	07/11/22	REVISED PER MHE COMMENTS
17	08/10/22	REVISED PER MHE COMMENTS
18	08/24/22	REVISED PER MHE COMMENTS
19	01/18/23	REVISED HEADWALL
20	01/27/23	REVISED UTILITIES
21	05/08/23	REVISED PER NEW BUILDING LAYOUT

DRAWING STATUS	ISSUE DATE: 05/08/2023				
THIS SHEET IS PART OF THE PLAN SET ISSUED FOR	SHEET NUMBER				
☐ CONCEPT APPROVAL	N/A	OF	N/A		
✓ PLANNING BOARD APPROVAL	21	OF	22		
OCDOH REALTY SUBDIVISION APPROVAL	N/A	OF	N/A		
OCDOH WATERMAIN EXTENSION APPROVAL	N/A	OF	9		
NYSDEC APPROVAL	N/A	OF	22		
NYSDOT APPROVAL	N/A	OF	N/A		
√ OTHER	1	OF	2		
☐ FOR BID	N/A	OF	N/A		
☐ FOR CONSTRUCTION	N/A	OF	N/A		
THIS DIAN SET HAS BEEN ISSUED SPECIFICALLY FOR THE					


APPROVAL OR ACTION NOTED ABOVE AND SHALL NOT BE USED THIS SHEET SHALL BE CONSIDERED INVALID UNLESS ACCOMPANIED BY ALL SHEETS OF THE DENOTED PLAN SET(S).

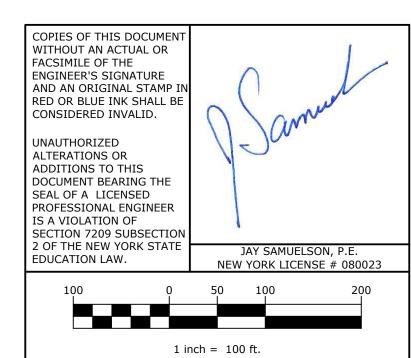


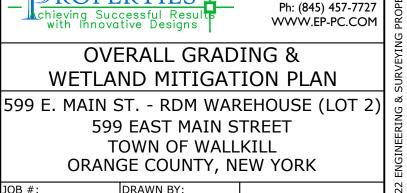

71 CLINTON STREET


1"=100' ACOE-1

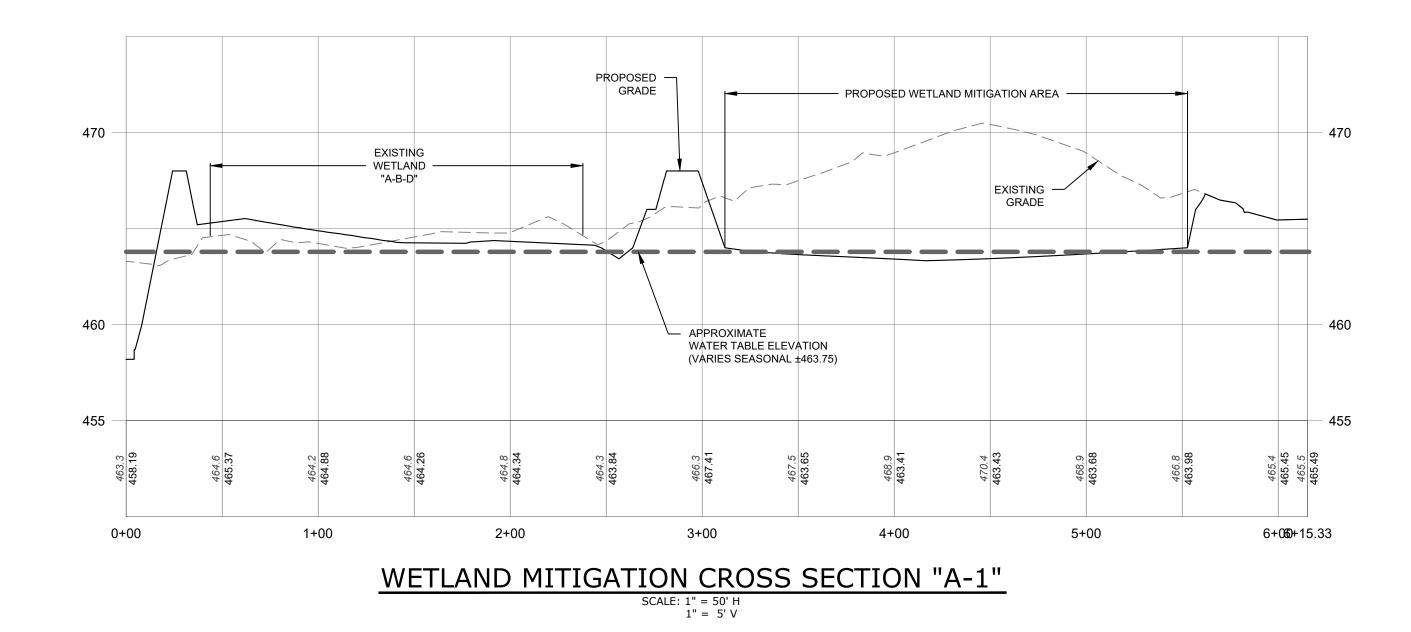

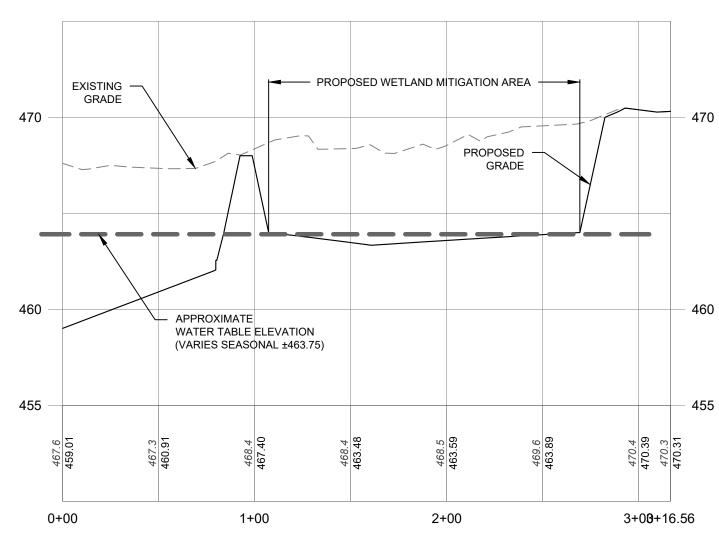

WETLAND MITIGATION CROSS SECTION "B-2"

SCALE: 1" = 50' H
1" = 5' V

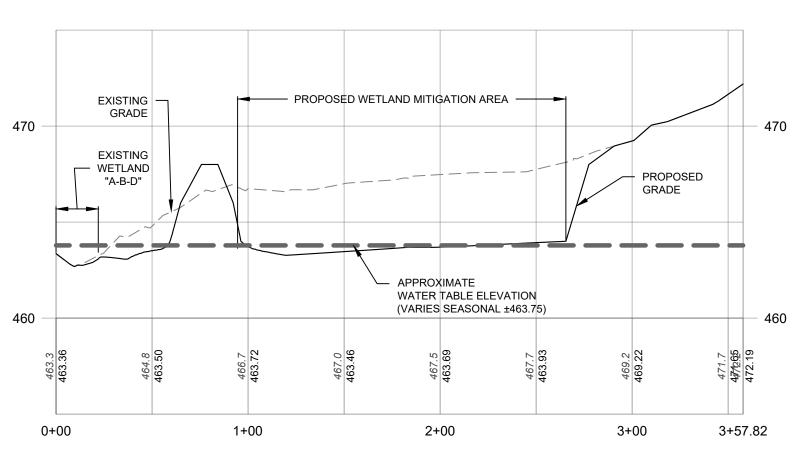

WETLAND MITIGATION CROSS SECTION "C-3"

SCALE: 1" = 50' H
1" = 5' V

No.	DATE	DESCRIPTION
2	04/03/20	REVISED PER MHE COMMENTS 03/10/2020
3	06/05/20	REVISED PER MHE COMMENTS 04/28/2020
4	03/03/21	REVISED PER MHE SWPPP COMMENTS 02/19/21
5	03/16/21	REVISED PER MHE SWPPP COMMENTS 03/12/21
6	04/12/21	REVISED BIO-RETENTION DETAIL
7	04/21/21	REVISED PER MHE COMMENTS
8	05/10/21	REVISED PER MHE COMMENTS
9	06/21/21	REVISED FOR OUTSIDE AGENCY SUBMISSION
10	09/17/21	REVISED PER OUTSIDE AGENCY COMMENTS
11	10/12/21	REVISED PER MHE COMMENTS
12	11/08/21	REVISED PER ACOE COMMENTS
13	11/23/21	REVISED PER ACOE COMMENTS
14	12/14/21	REVISED PER OCDOH COMMENTS
15	02/22/22	REVISED PER OCDOH COMMENTS
16	07/11/22	REVISED PER MHE COMMENTS
17	08/10/22	REVISED PER MHE COMMENTS
18	08/24/22	REVISED PER MHE COMMENTS
19	01/18/23	REVISED HEADWALL
20	01/27/23	REVISED UTILITIES
21	05/08/23	REVISED PER NEW BUILDING LAYOUT

DRAWING STATUS	ISSUE DATE: 05/08/2023				
THIS SHEET IS PART OF THE PLAN SET ISSUED FOR	SHEET NUMBER				
CONCEPT APPROVAL	N/A	OF	N/A		
☑ PLANNING BOARD APPROVAL	22	OF	22		
OCDOH REALTY SUBDIVISION APPROVAL	N/A	OF	N/A		
OCDOH WATERMAIN EXTENSION APPROVAL	N/A	OF	9		
NYSDEC APPROVAL	N/A	OF	22		
NYSDOT APPROVAL	N/A	OF	N/A		
☑ OTHER	2	OF	2		
☐ FOR BID	N/A	OF	N/A		
☐ FOR CONSTRUCTION	N/A	OF	N/A		
THIS PLAN SET HAS BEEN ISSUED SPECIFICALLY FOR THE					

THIS PLAN SET HAS BEEN ISSUED SPECIFICALLY FOR THE APPROVAL OR ACTION NOTED ABOVE AND SHALL NOT BE USED FOR ANY OTHER PURPOSE.
THIS SHEET SHALL BE CONSIDERED INVALID UNLESS ACCOMPANIED BY ALL SHEETS OF THE DENOTED PLAN SET(S).

COPIES OF THIS DOCUMENT WITHOUT AN ACTUAL OR FACSIMILE OF THE ENGINEER'S SIGNATURE AND AN ORIGINAL STAMP IN RED OR BLUE INK SHALL BE CONSIDERED INVALID.

UNAUTHORIZED ALTERATIONS OR ADDITIONS TO THIS DOCUMENT BEARING THE SEAL OF A LICENSED PROFESSIONAL ENGINEER IS A VIOLATION OF SECTION 7209 SUBSECTION 2 OF THE NEW YORK STATE EDUCATION LAW.

JAY SAMUELSON, P.E. NEW YORK LICENSE # 080023

ROPERTIES MONTG

**MONTGOMERY OFFICE 71 CLINTON STREET MONTGOMERY, NY 12549

Ph: (845) 457-7727 With Innovative Designs

WWW.EP-PC.COM

OVERALL GRADING & WETLAND MITIGATION PLAN

599 E. MAIN ST. - RDM WAREHOUSE (LOT 2)
599 EAST MAIN STREET
TOWN OF WALLKILL

ORANGE COUNTY, NEW YORK

DRAWN BY:

980.1504 JS

DATE: SCALE:
01/06/20 AS NOTED

REVISION: TAX LOT:
21 - 05/08/2023 78-1-94.1

TOWN OF WALLKILL PB SHEET 27 OF 27